

Great North Road Solar and Biodiversity Park

Environmental Statement Volume 3, Chapter 5 Development Description Figures 5.5 – 5.21 (Part 3 of 3)

Document reference – EN010162/APP/6.3.5C

Revision Number 4


April 2026

Infrastructure Planning (Applications: Prescribed Forms and Procedure) Regulations 2009, APFP Regulation 5(2)(a)

6.3.5 ENVIRONMENTAL STATEMENT VOLUME 3, CHAPTER 5 DEVELOPMENT DESCRIPTION FIGURES

<i>Revision</i>	<i>Drawing Title</i>	<i>Part</i>	<i>Reason for Revision</i>
01	Figure 5.1 Works Areas	Part 1 of 3	No changes made
04	Figure 5.2 Masterplan	Part 1 of 3	Updated Figure to include Permissive Footpath 22.
03	Figure 5.3 Environmental Constraints	Part 2 of 3	Updated Figure to include Permissive Footpath 22 and constraint buffers to reflect Chapter 5.
01	Figure 5.4 Illustrative Design	Part 2 of 3	No changes made
03	Figure 5.5 Illustrative Construction Layout	Part 3 of 3	Updated Figure to include Permissive Footpath 22.
01	Figure 5.6 Illustrative Solar Array Plan, Elevation and Cross-Section	Part 3 of 3	No changes made
01	Figure 5.7 Illustrative CCTV Pole	Part 3 of 3	No changes made
01	Figure 5.8 Illustrative Access Track Cross-Section	Part 3 of 3	No changes made
01	Figure 5.10 Illustrative Inverter, Transformer Elevations	Part 3 of 3	No changes made
01	Figure 5.11 Illustrative Fence and Gate Elevations	Part 3 of 3	No changes made
01	Figure 5.12 Illustrative Substation Layout	Part 3 of 3	No changes made
01	Figure 5.13 Illustrative Construction Compound Layout	Part 3 of 3	No changes made
01	Figure 5.14 BESS Elevations	Part 3 of 3	No changes made
01	Figure 5.15 PCS Elevations	Part 3 of 3	No changes made
01	Figure 5.16 132kV Substation Elevation	Part 3 of 3	No changes made
01	Figure 5.17 400kV Substation Elevation	Part 3 of 3	No changes made
01	Figure 5.18 132kV and 400kV relay and control room	Part 3 of 3	No changes made

<i>Revision</i>	<i>Drawing Title</i>	<i>Part</i>	<i>Reason for Revision</i>
01	Figure 5.19 Illustrative Switchgear Buildings and Welfare Cabins	Part 3 of 3	No changes made
01	Figure 5.20 Illustrative Auxiliary Transformer House Area	Part 3 of 3	No changes made
01	Figure 5.21 Illustrative Spare Parts Containers	Part 3 of 3	No changes made

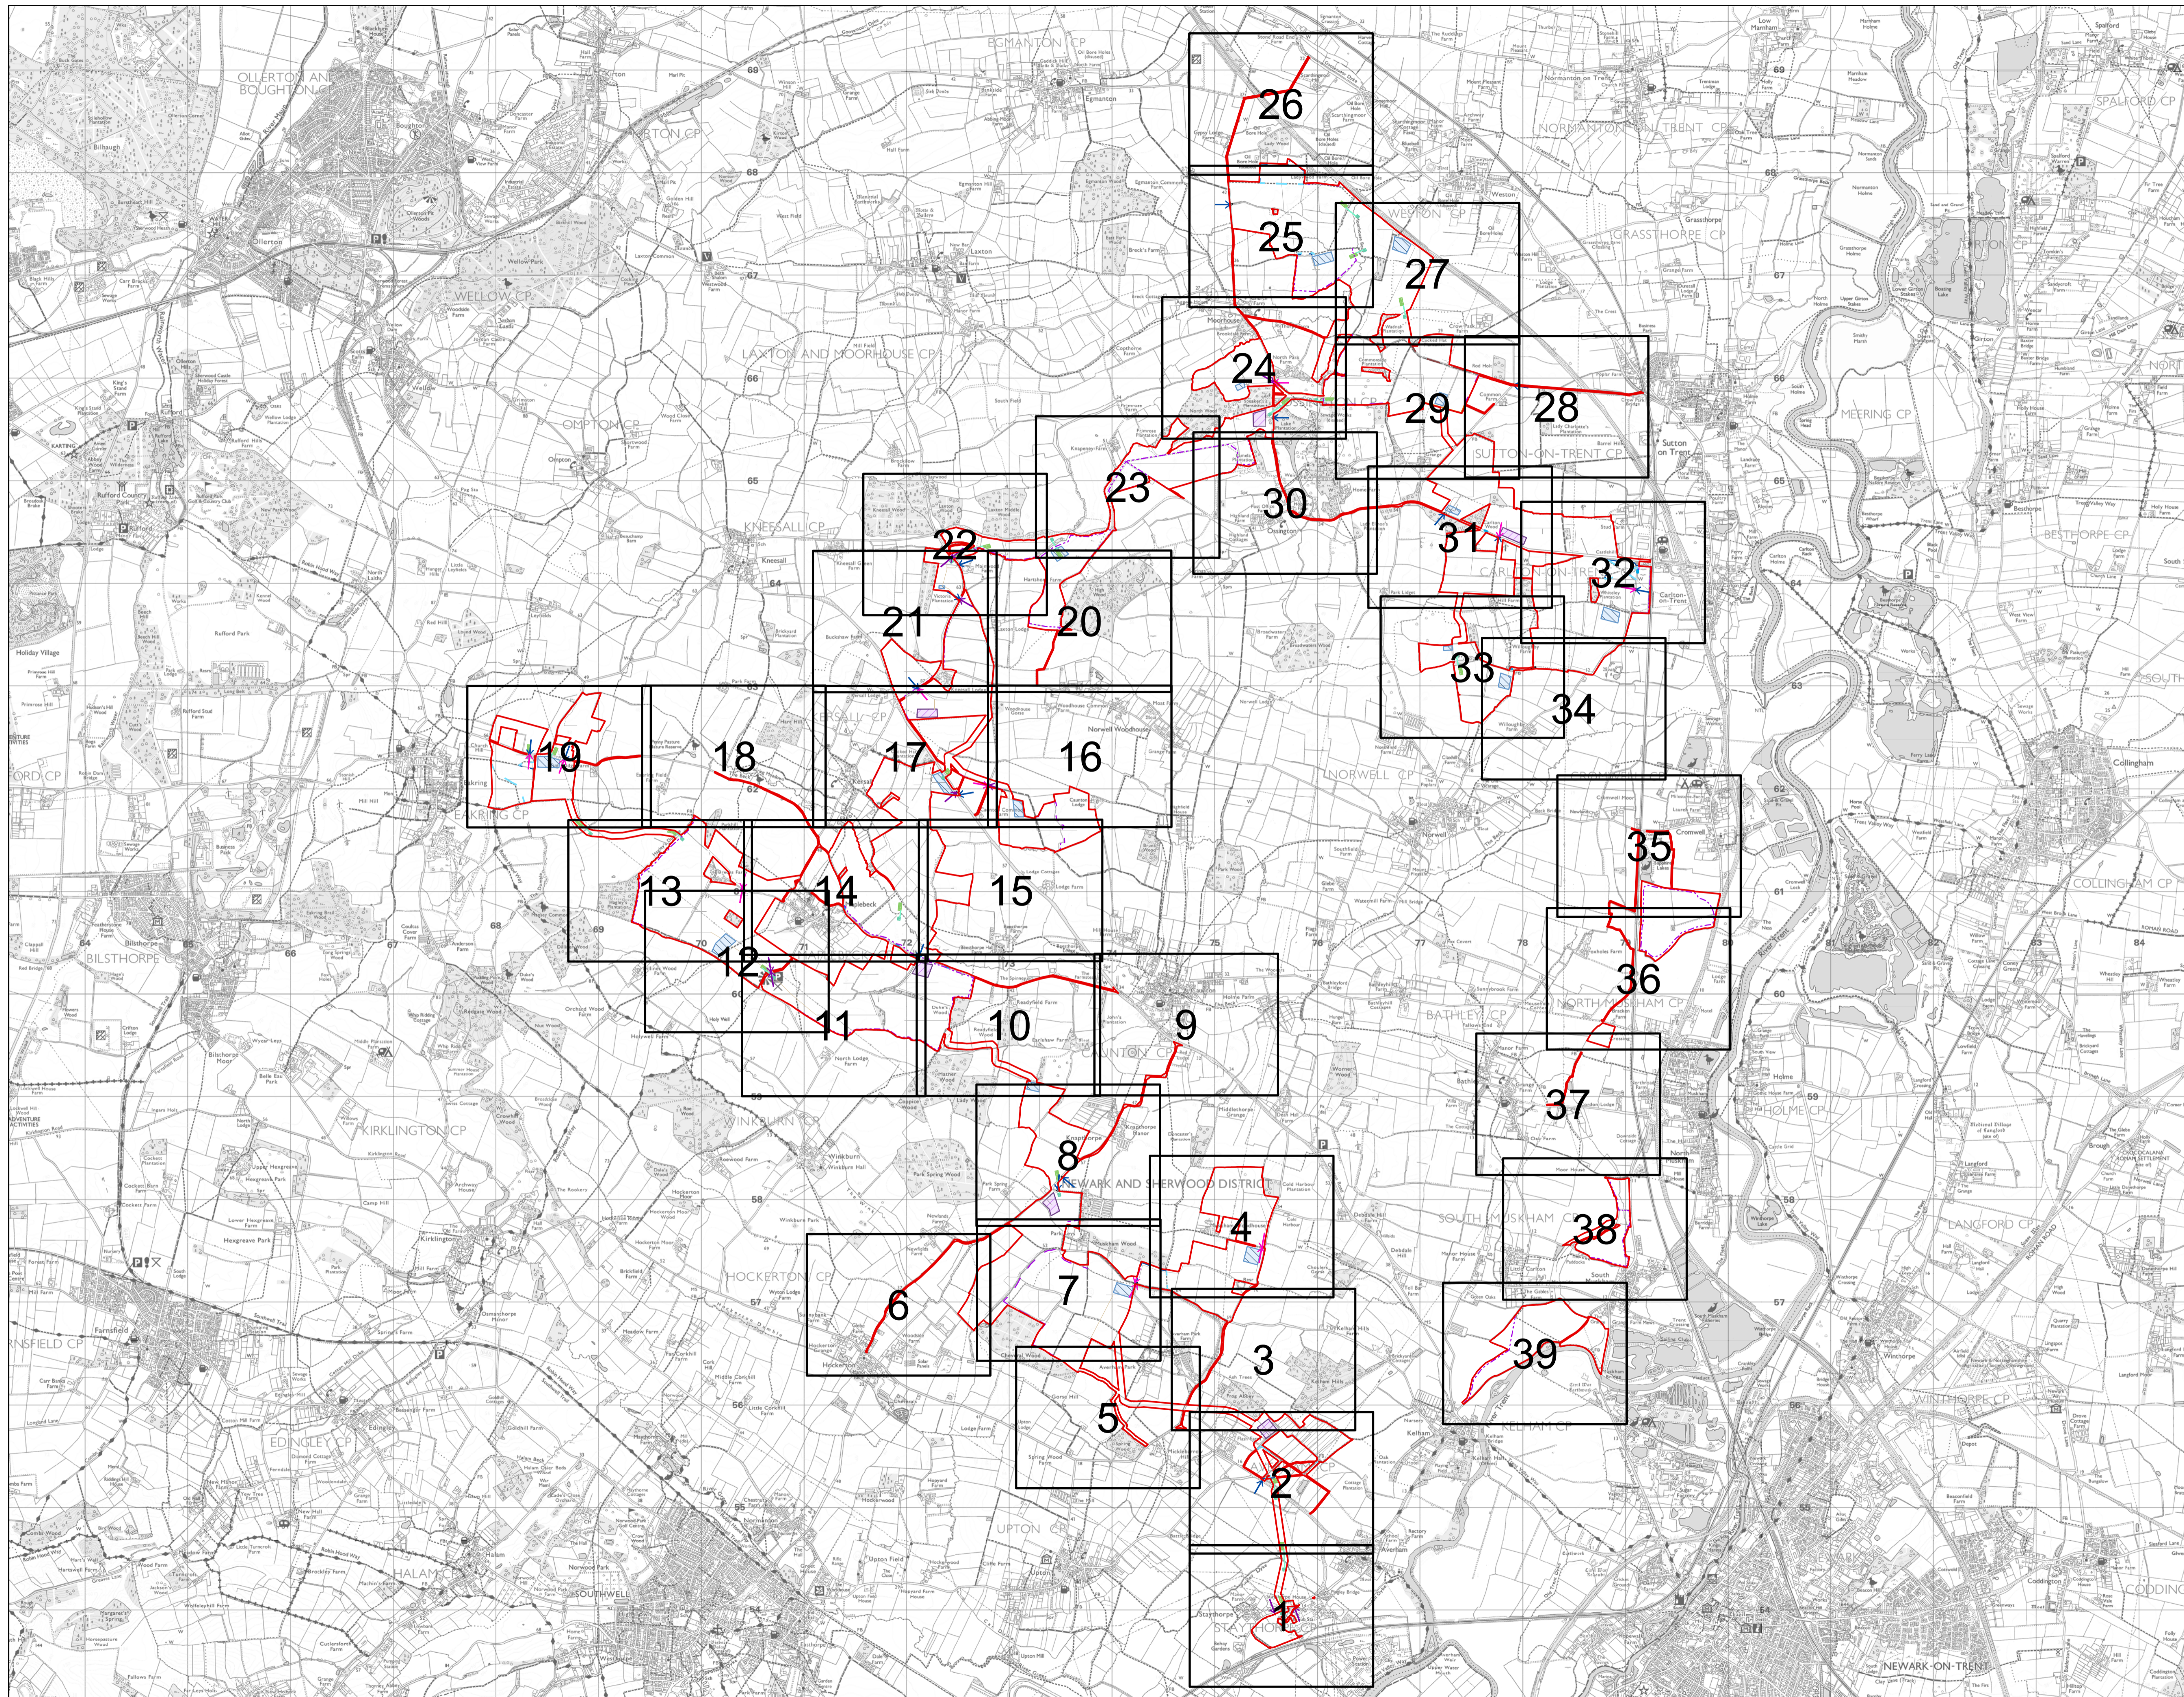

NOTES
ALL DIMENSIONS ARE IN METRES UNLESS STATED OTHERWISE.


Legend

- Order Limits
- ↑ Construction Only Access Point
- ↑ Maintenance and Construction Access Point
- ↑ Maintenance Access and Construction Cross Over Point
- Footpath Closure
- Footpath Diversion
- Bridleway Closed For Construction and Decommissioning
- Bridleway Diversion for Construction and Decommissioning
- New Permissive Footpath
- New Permissive Bridleway
- Access Bellmouth
- Passing Places
- HDD Connection Channel
- HDD Compound Pull-Back Rig
- HDD Compound Rig Side
- Internal Tarmac Roads
- Internal Stone Roads
- Temporary Construction Roads
- Main Compound Areas
- Satellite Compound Areas

The Legend is identical on all sheets of the Illustrative Construction Layout and therefore not all items specified in the Legend are found on each sheet

Revision 3	AD	LA	14/04/2026	Rev03
Revision 2	AD	LA	14/01/2025	Rev02
Revision 1	AD	LA	24/06/2025	Rev01
Revision Details	By	Check	Date	Suffix

Applicant: Elements Green Trent Limited

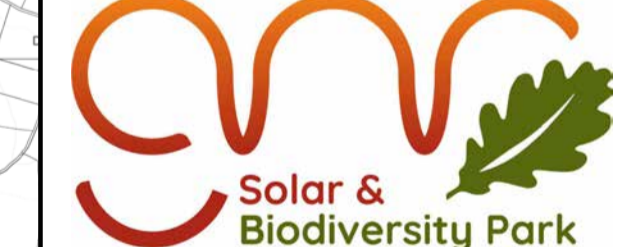

Project Title:
GREAT NORTH ROAD SOLAR AND BIODIVERSITY PARK

Purpose of Issue:
DCO APPLICATION

Development Consent Order Number:
EN010162


Development Consent Order Drawing Number:
EN010162/APP/6.3.5.5B

Drawing Title:
Illustrative Construction Layout Key Plan


Designed: AD	Drawn: AD	Checked: LA	Date: 14/04/2026
Internal Project Number: 026	Suitability: DCO Application		

Scale @ A1:
1:30,000

Rev:
Rev03

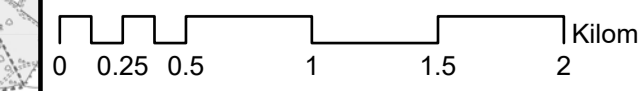

FOR CONTINUATION REFER TO SHEET 2

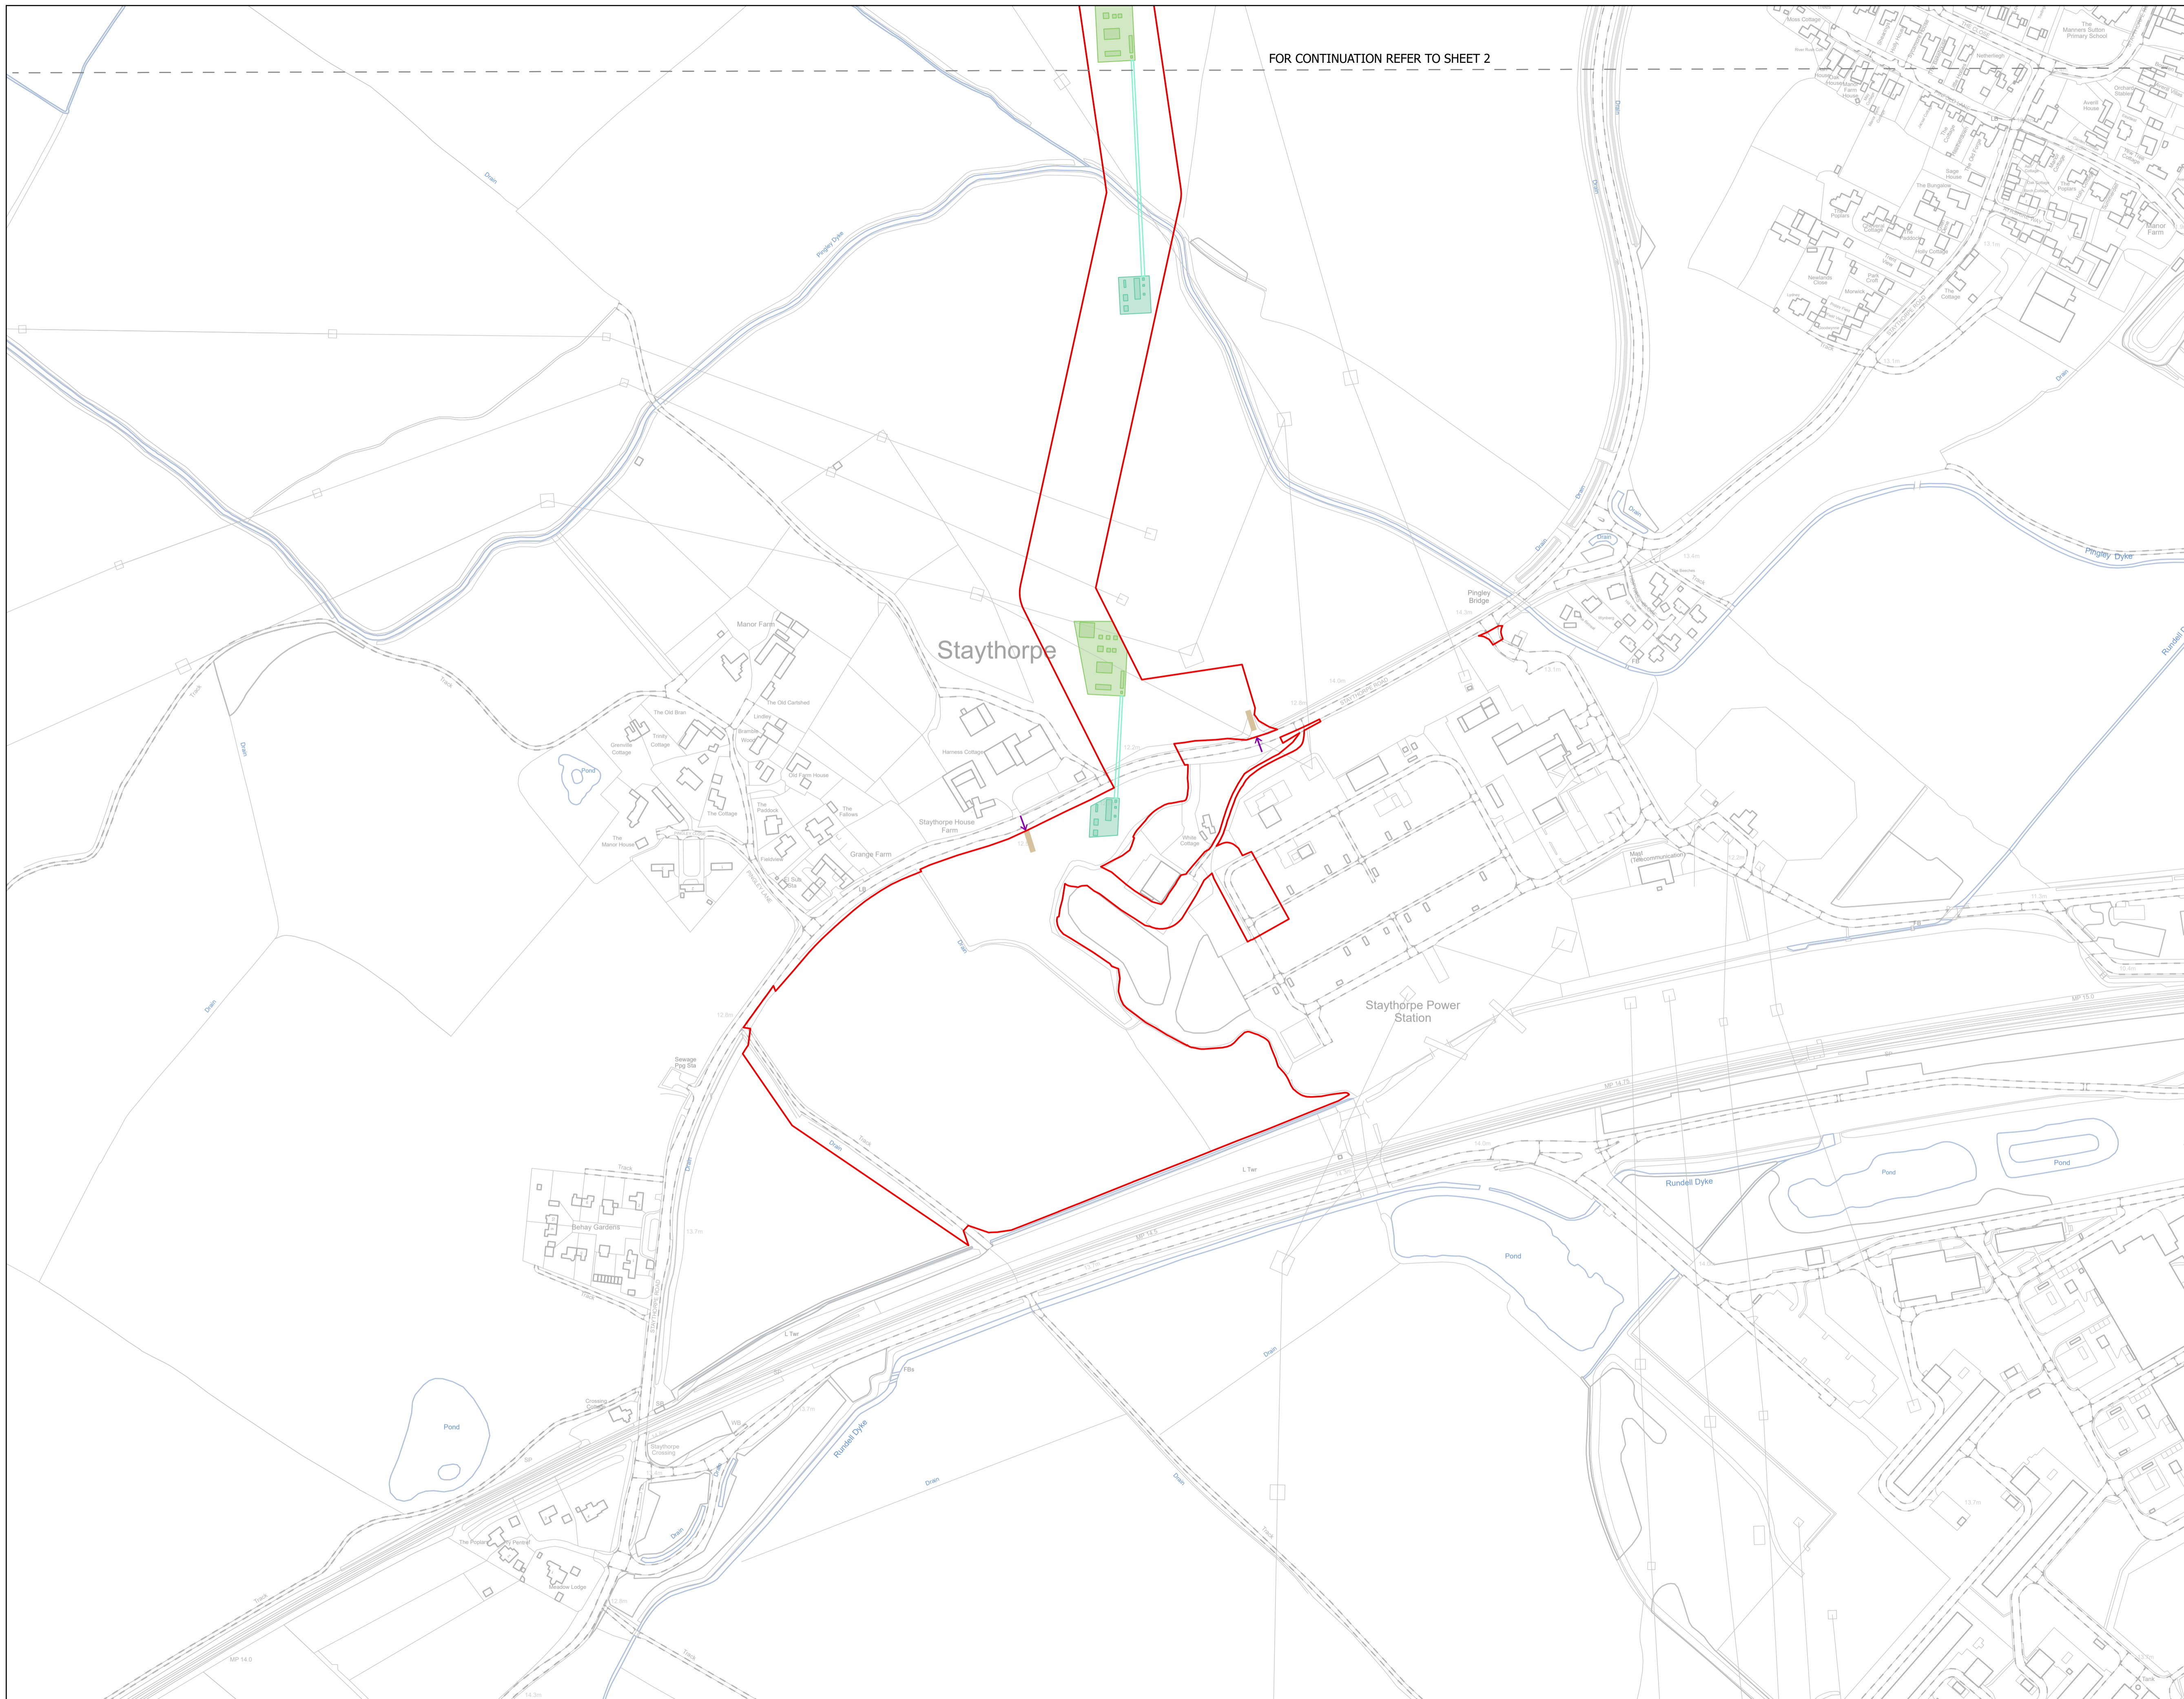


NOTES
1. ALL DIMENSIONS ARE IN METRES UNLESS STATED OTHERWISE.

Legend

- Order Limits
- ↑ Construction Only Access Point
- ↑ Maintenance and Construction Access Point
- ↑ Maintenance Access and Construction Cross Over Point
- Footpath Closure
- Footpath Diversion
- Bridleway Closed For Construction and Decommissioning
- New Permissive Footpath
- New Permissive Bridleway
- Bridleway Diversion for Construction and Decommissioning
- Access Bellmouth
- Passing Places
- HDD Connection Channel
- HDD Compound Pull-Back Rig
- HDD Compound Rig Side
- Internal Tarmac Roads
- Internal Stone Roads
- Temporary Construction Roads
- Main Compound Areas
- Satellite Compound Areas

The Legend is identical on all sheets of the Illustrative Construction Layout and therefore not all items specified in the Legend are found on each sheet

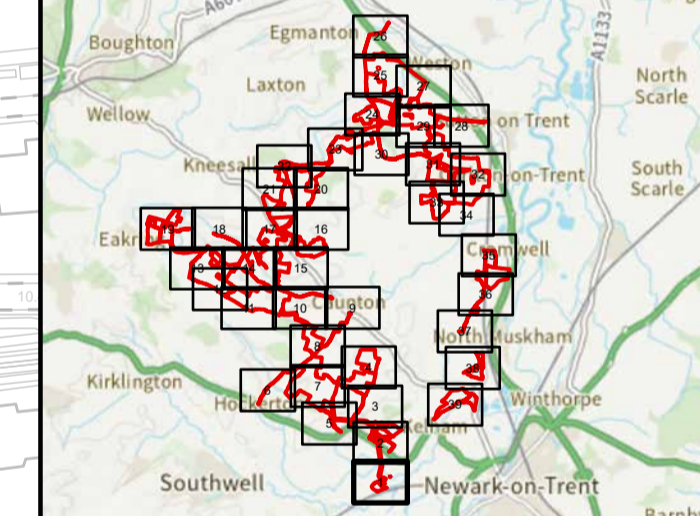

Revision 3	AD	LA	14/04/2026	Rev03
Revision 2	AD	LA	14/01/2026	Rev02
Revision 1	AD	LA	24/06/2025	Rev01
Revision Details	By	Check	Date	Suffix

Applicant: Elements Green Trent Limited



Project Title:
GREAT NORTH ROAD SOLAR AND BIODIVERSITY PARK

Purpose of Issue:
DCO APPLICATION

Development Consent Order Number:
EN010162

Development Consent Order Drawing Number:
EN010162/APP/6.3.5.5B


Drawing Title:
Illustrative Construction Layout SHEET 1 of 39


Designed: AD	Drawn: AD	Checked: LA	Date: 14/04/2026
-----------------	--------------	----------------	---------------------

Internal Project Number: 026	Suitability: DCO Application
---------------------------------	---------------------------------

Scale @ A1:
1:2,500

N	Rev: Rev03
---	---------------

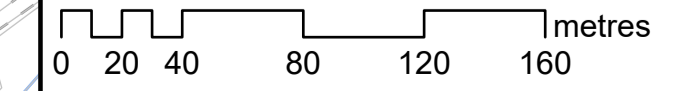

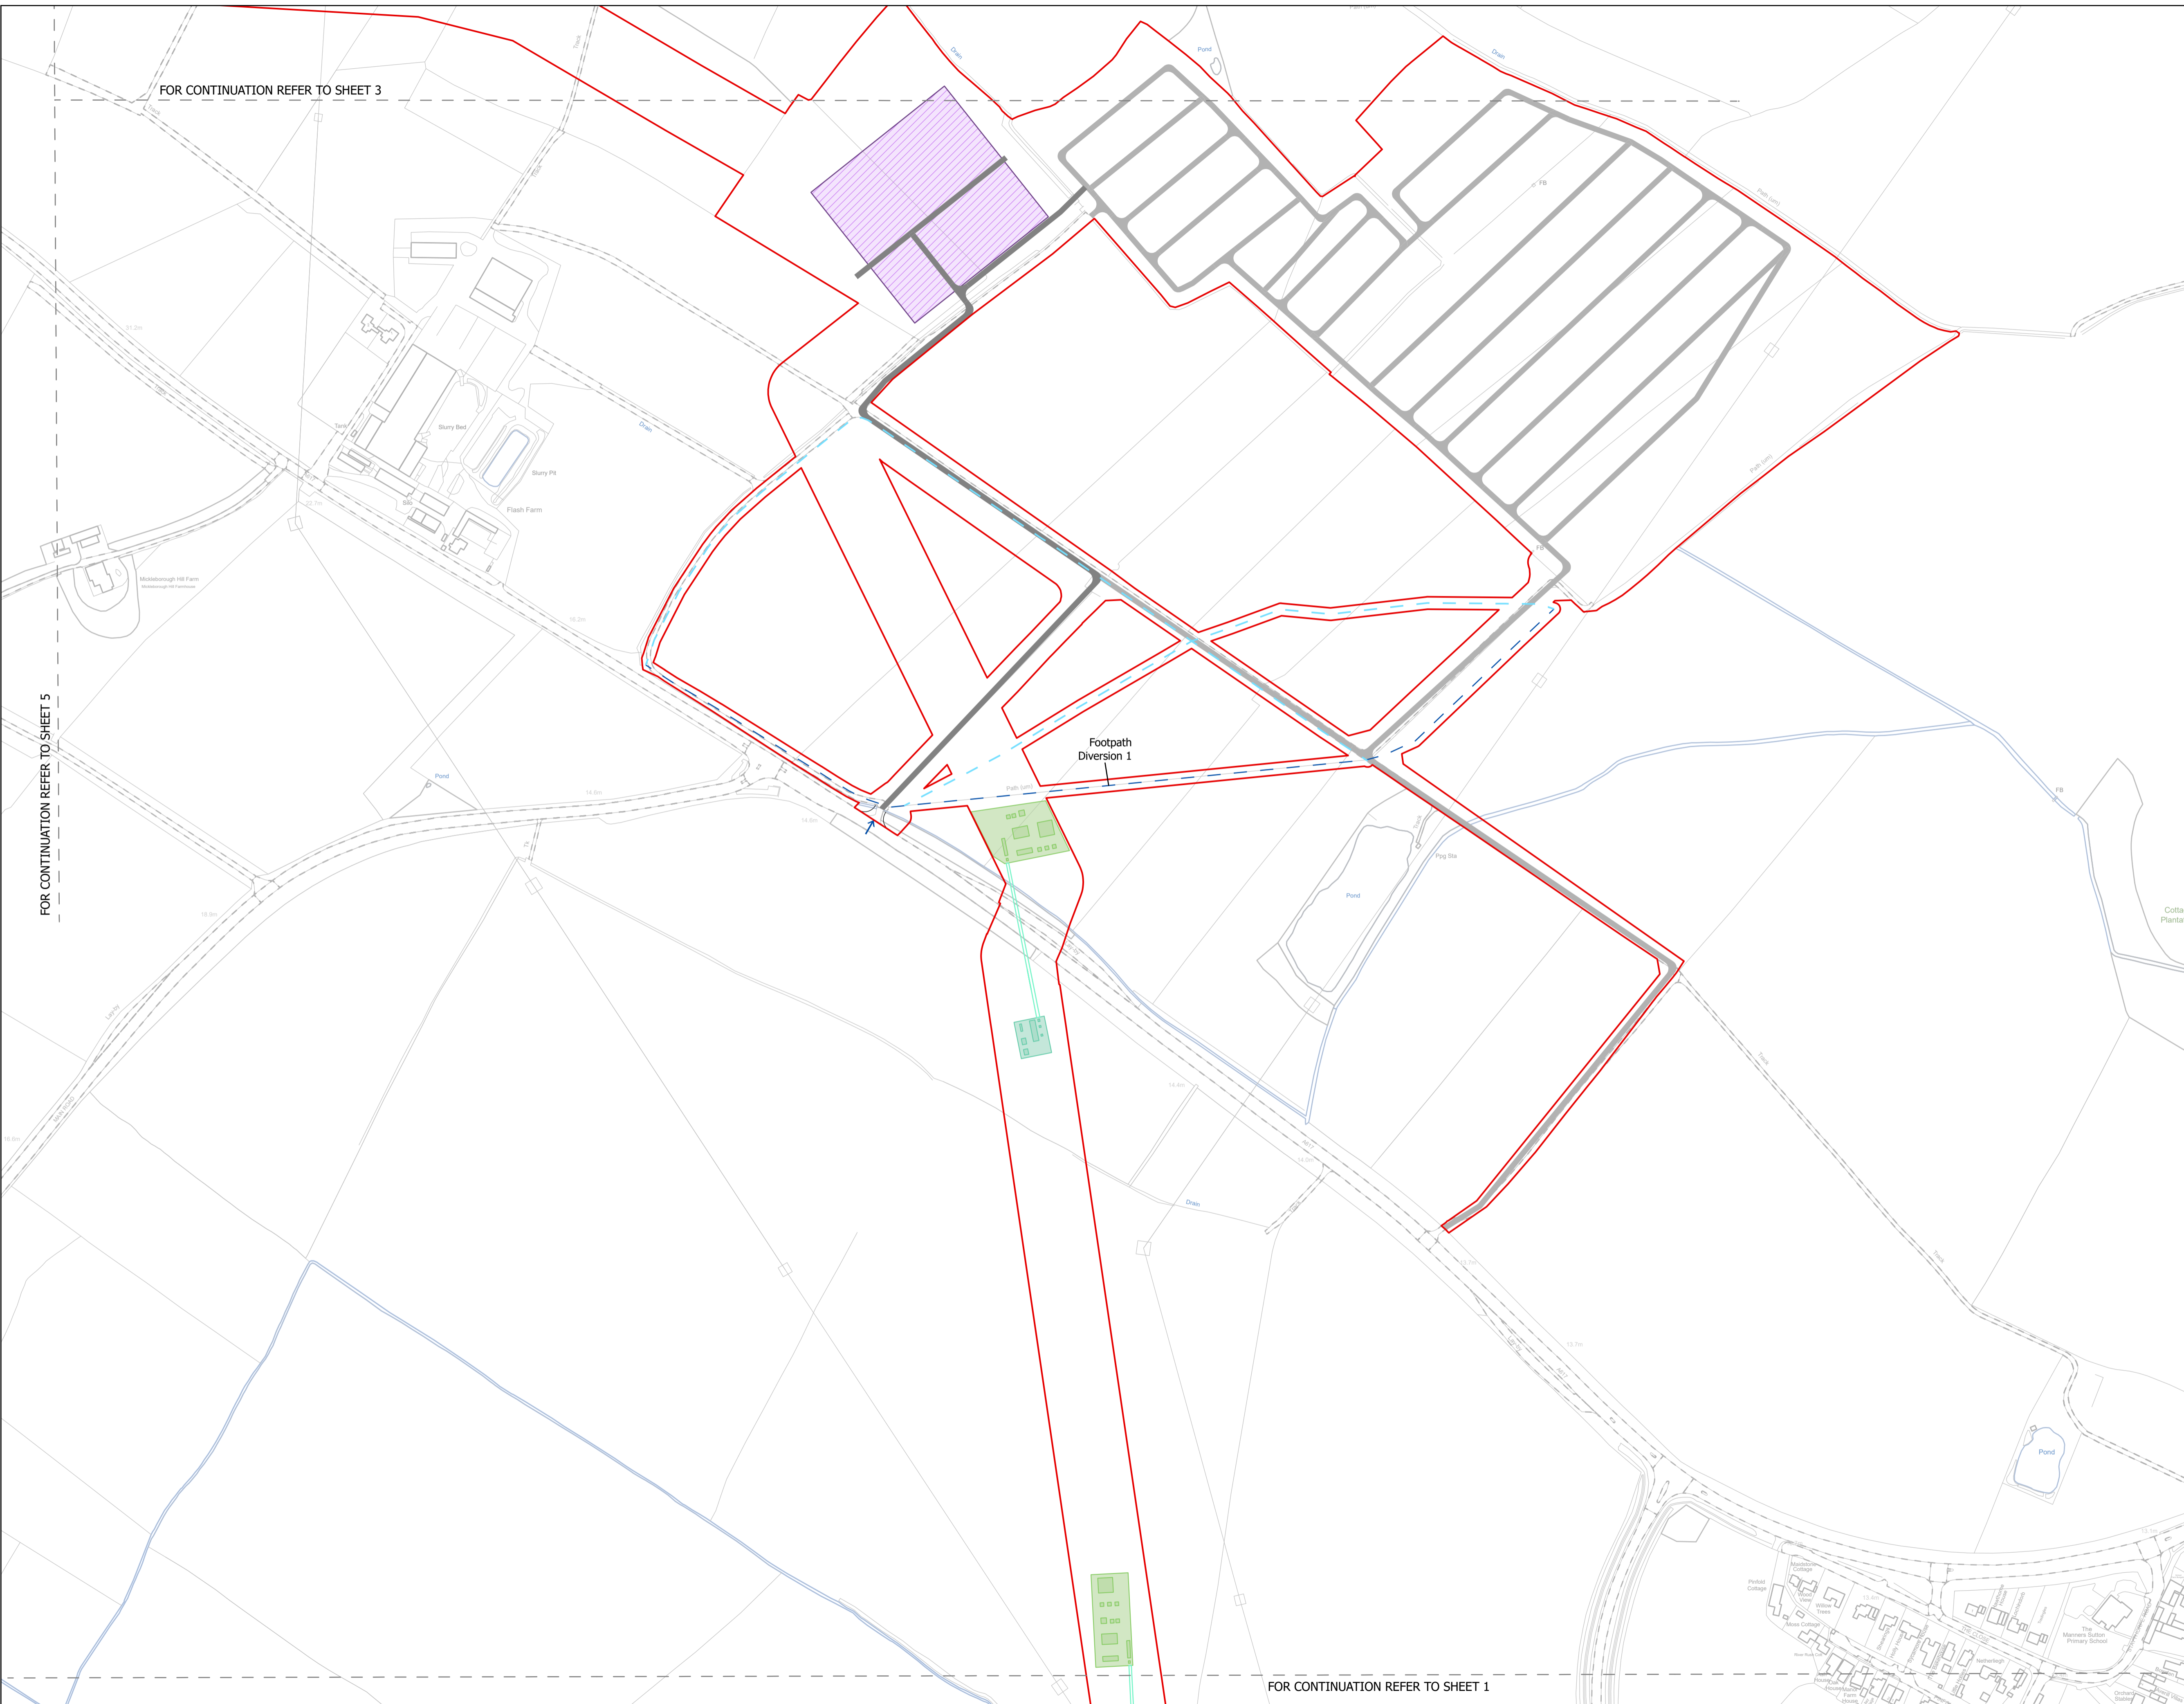

FOR CONTINUATION REFER TO SHEET 3


FOR CONTINUATION REFER TO SHEET 5

FOR CONTINUATION REFER TO SHEET 1

NOTES
1. ALL DIMENSIONS ARE IN METRES UNLESS STATED OTHERWISE.

- Legend**
- Order Limits
 - ↑ Construction Only Access Point
 - ↑ Maintenance and Construction Access Point
 - ↑ Maintenance Access and Construction Cross Over Point
 - Footpath Closure
 - Footpath Diversion
 - Bridleway Closed For Construction and Decommissioning
 - New Permissive Footpath
 - New Permissive Bridleway
 - Bridleway Diversion For Construction and Decommissioning
 - Access Bellmouth
 - Passing Places
 - HDD Connection Channel
 - HDD Compound Pull-Back Rig
 - HDD Compound Rig Side
 - Internal Tarmac Roads
 - Internal Stone Roads
 - Temporary Construction Roads
 - Main Compound Areas
 - Satellite Compound Areas

The Legend is identical on all sheets of the Illustrative Construction Layout and therefore not all items specified in the Legend are found on each sheet

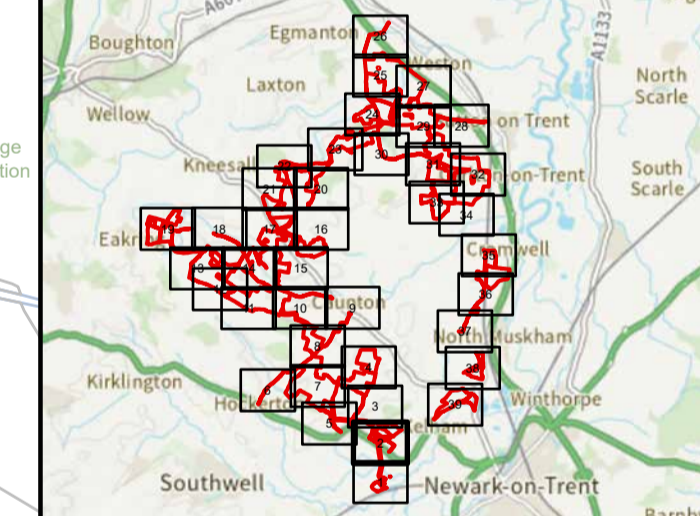

Revision 3	AD	LA	14/04/2026	Rev03
Revision 2	AD	LA	14/01/2026	Rev02
Revision 1	AD	LA	24/06/2025	Rev01
Revision Details	By	Check	Date	Suffix

Applicant: Elements Green Trent Limited

Solar & Biodiversity Park

Project Title:
GREAT NORTH ROAD SOLAR AND BIODIVERSITY PARK

Purpose of Issue:
DCO APPLICATION

Development Consent Order Number:
EN010162

Development Consent Order Drawing Number:
EN010162/APP/6.3.5.5B

Drawing Title:
Illustrative Construction Layout SHEET 2 of 39


Designed: AD	Drawn: AD	Checked: LA	Date: 14/04/2026
-----------------	--------------	----------------	---------------------


Internal Project Number:
026

Suitability:
DCO Application

Scale @ A1:
1:2,500

Rev:
Rev03

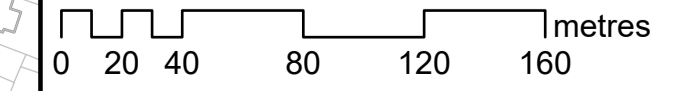


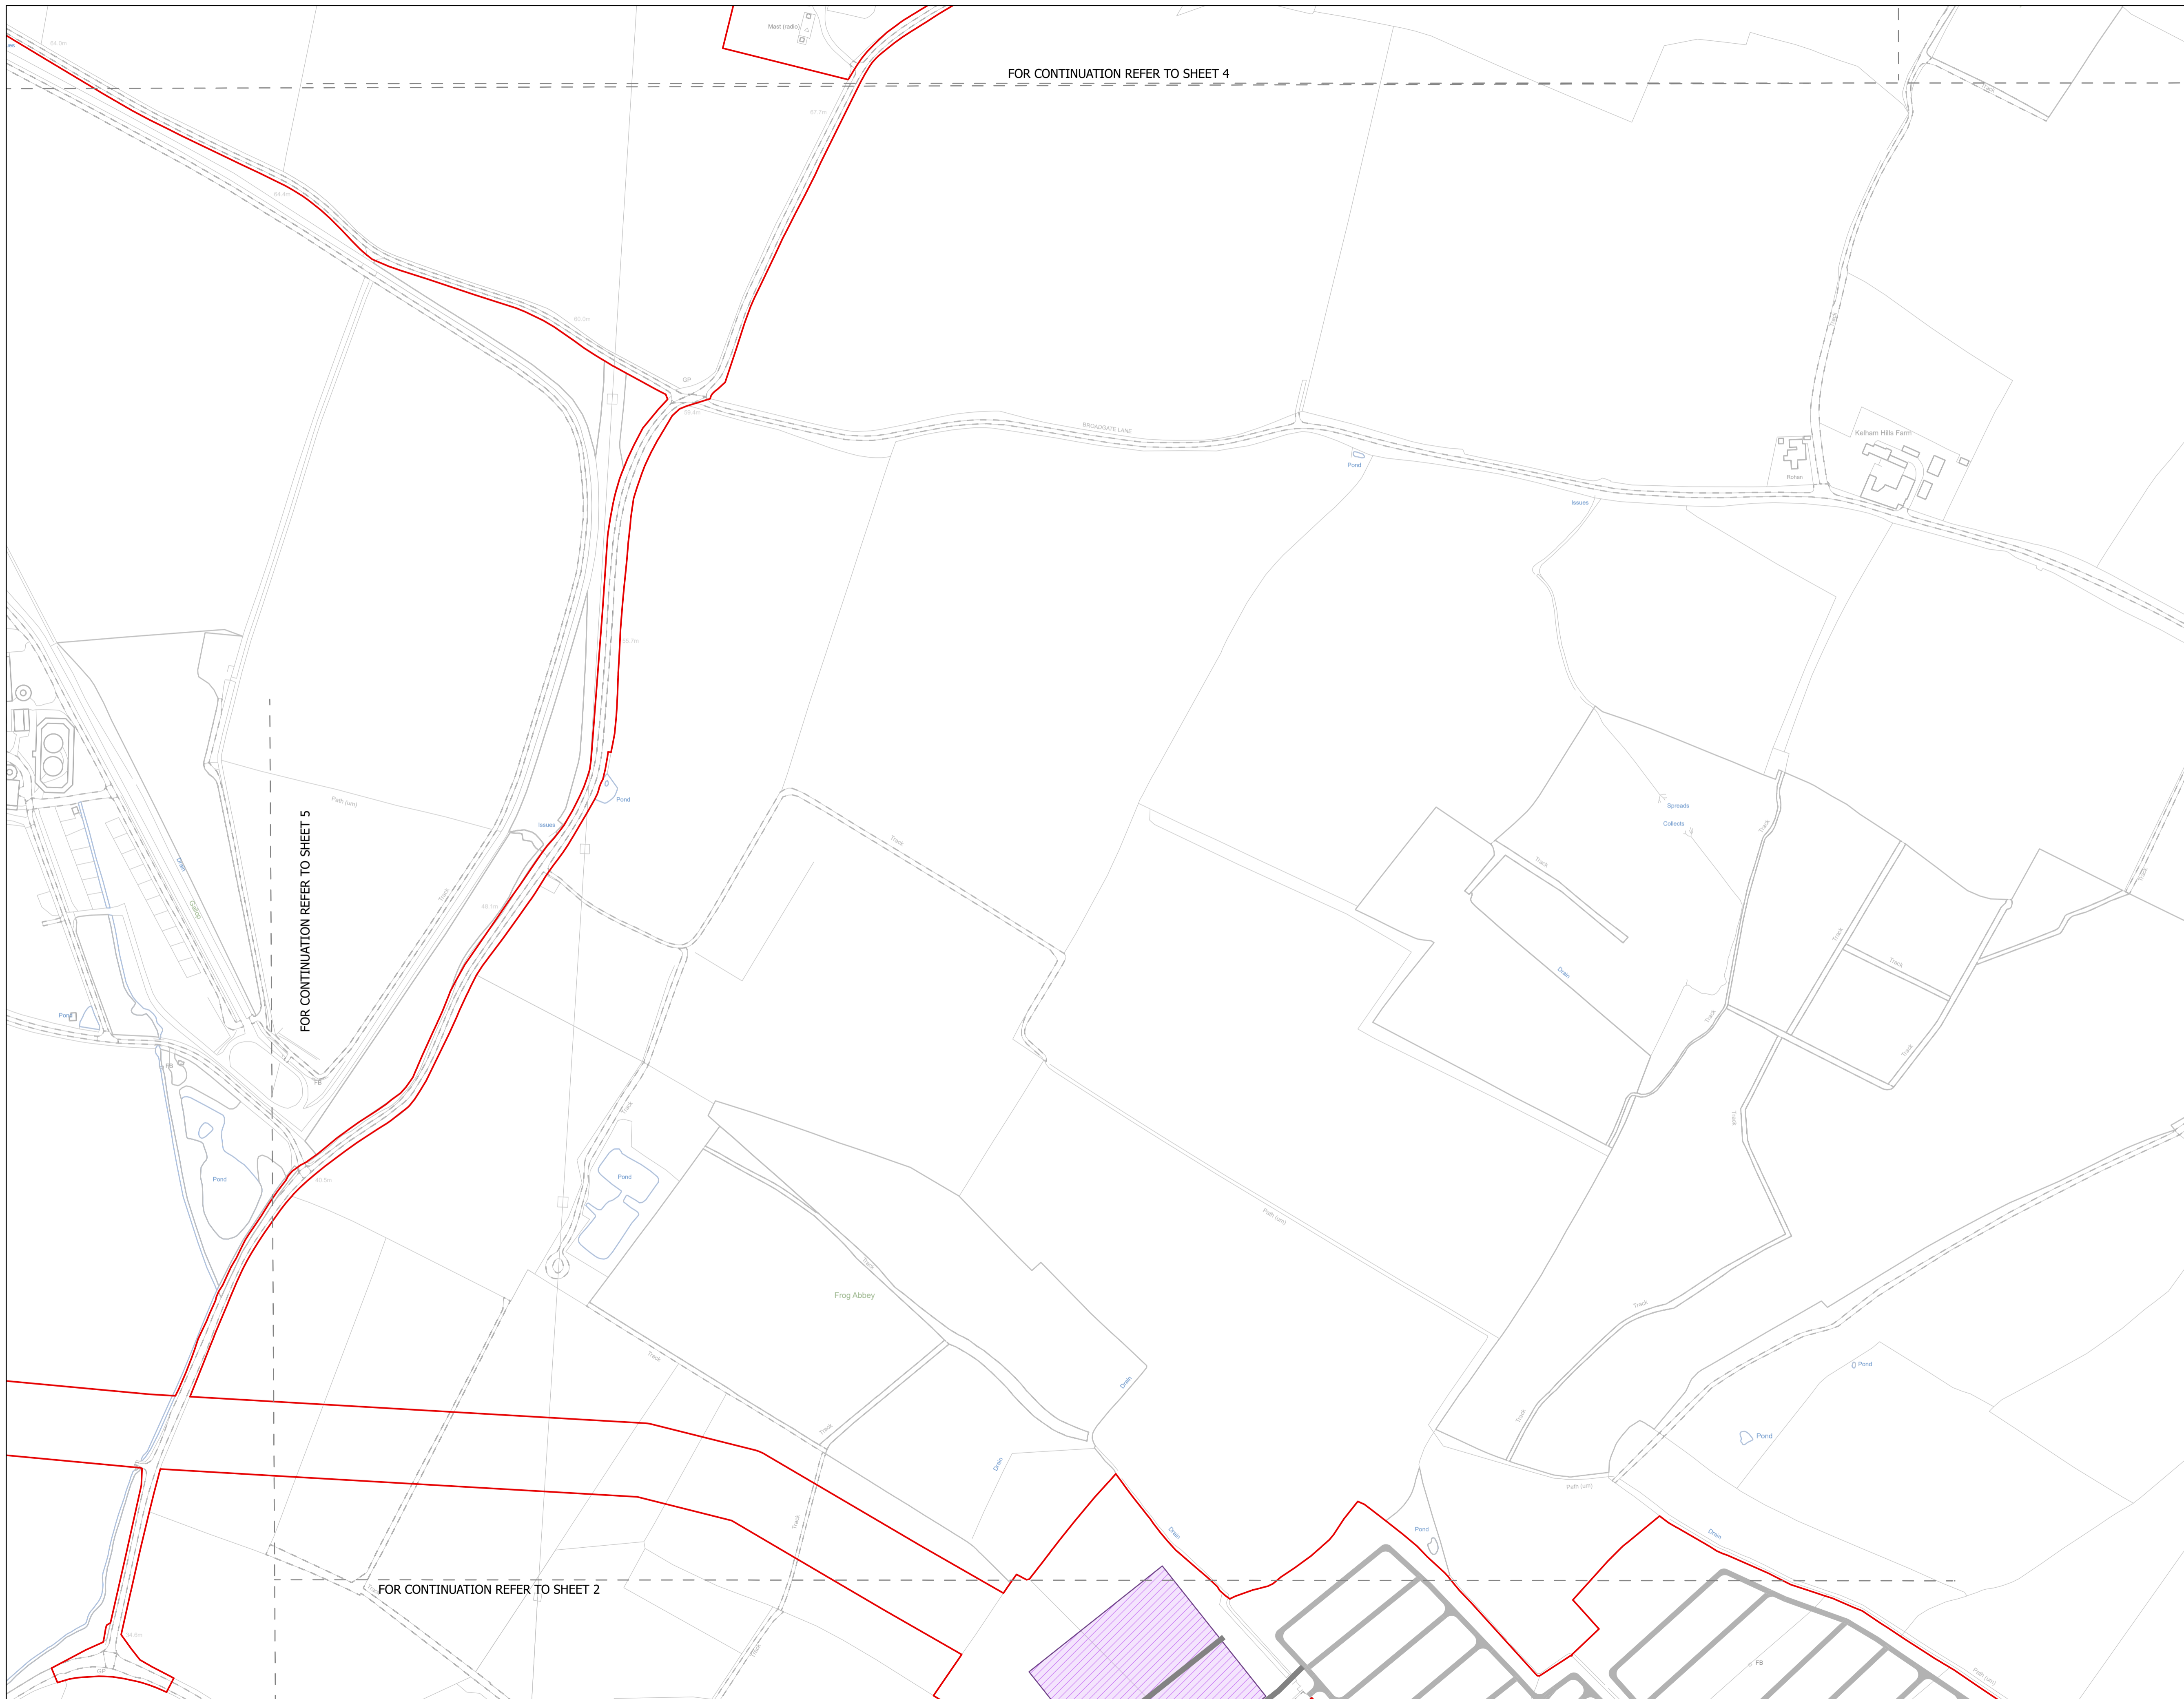

NOTES
1. ALL DIMENSIONS ARE IN METRES UNLESS STATED OTHERWISE.

- Legend**
- Order Limits
 - ↑ Construction Only Access Point
 - ↑ Maintenance and Construction Access Point
 - ↑ Maintenance Access and Construction Cross Over Point
 - Footpath Closure
 - Footpath Diversion
 - Bridleway Closed For Construction and Decommissioning
 - New Permissive Footpath
 - New Permissive Bridleway
 - Bridleway Diversion for Construction and Decommissioning
 - Access Bellmouth
 - Passing Places
 - HDD Connection Channel
 - HDD Compound Pull-Back Rig
 - HDD Compound Rig Side
 - Internal Tarmac Roads
 - Internal Stone Roads
 - Temporary Construction Roads
 - Main Compound Areas
 - Satellite Compound Areas

The Legend is identical on all sheets of the Illustrative Construction Layout and therefore not all items specified in the Legend are found on each sheet

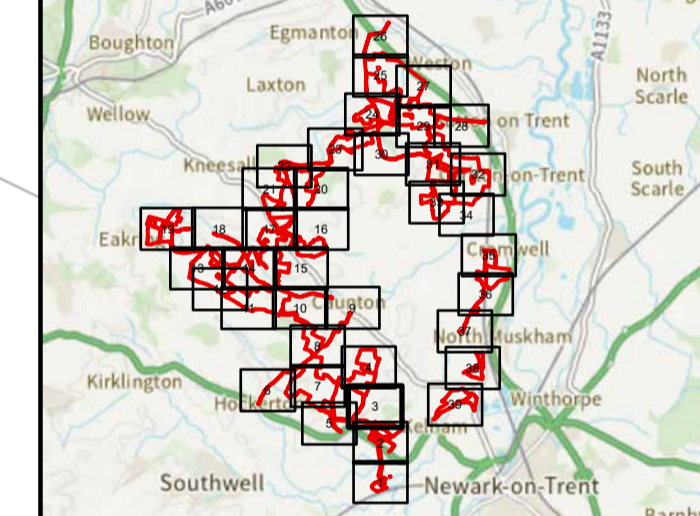

Revision 3	AD	LA	14/04/2026	Rev03
Revision 2	AD	LA	14/01/2026	Rev02
Revision 1	AD	LA	24/06/2025	Rev01
Revision Details	By	Check	Date	Suffix



Project Title:
GREAT NORTH ROAD SOLAR AND BIODIVERSITY PARK

Purpose of Issue:
DCO APPLICATION

Development Consent Order Number:
EN010162

Development Consent Order Drawing Number:
EN010162/APP/6.3.5.5B


Drawing Title:
Illustrative Construction Layout SHEET 3 of 39


Designed: AD	Drawn: AD	Checked: LA	Date: 14/04/2026
Internal Project Number: 026	Suitability: DCO Application		

Scale @ A1:
1:2,500

N

Rev:
Rev03

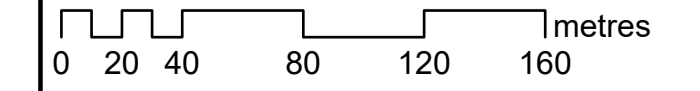

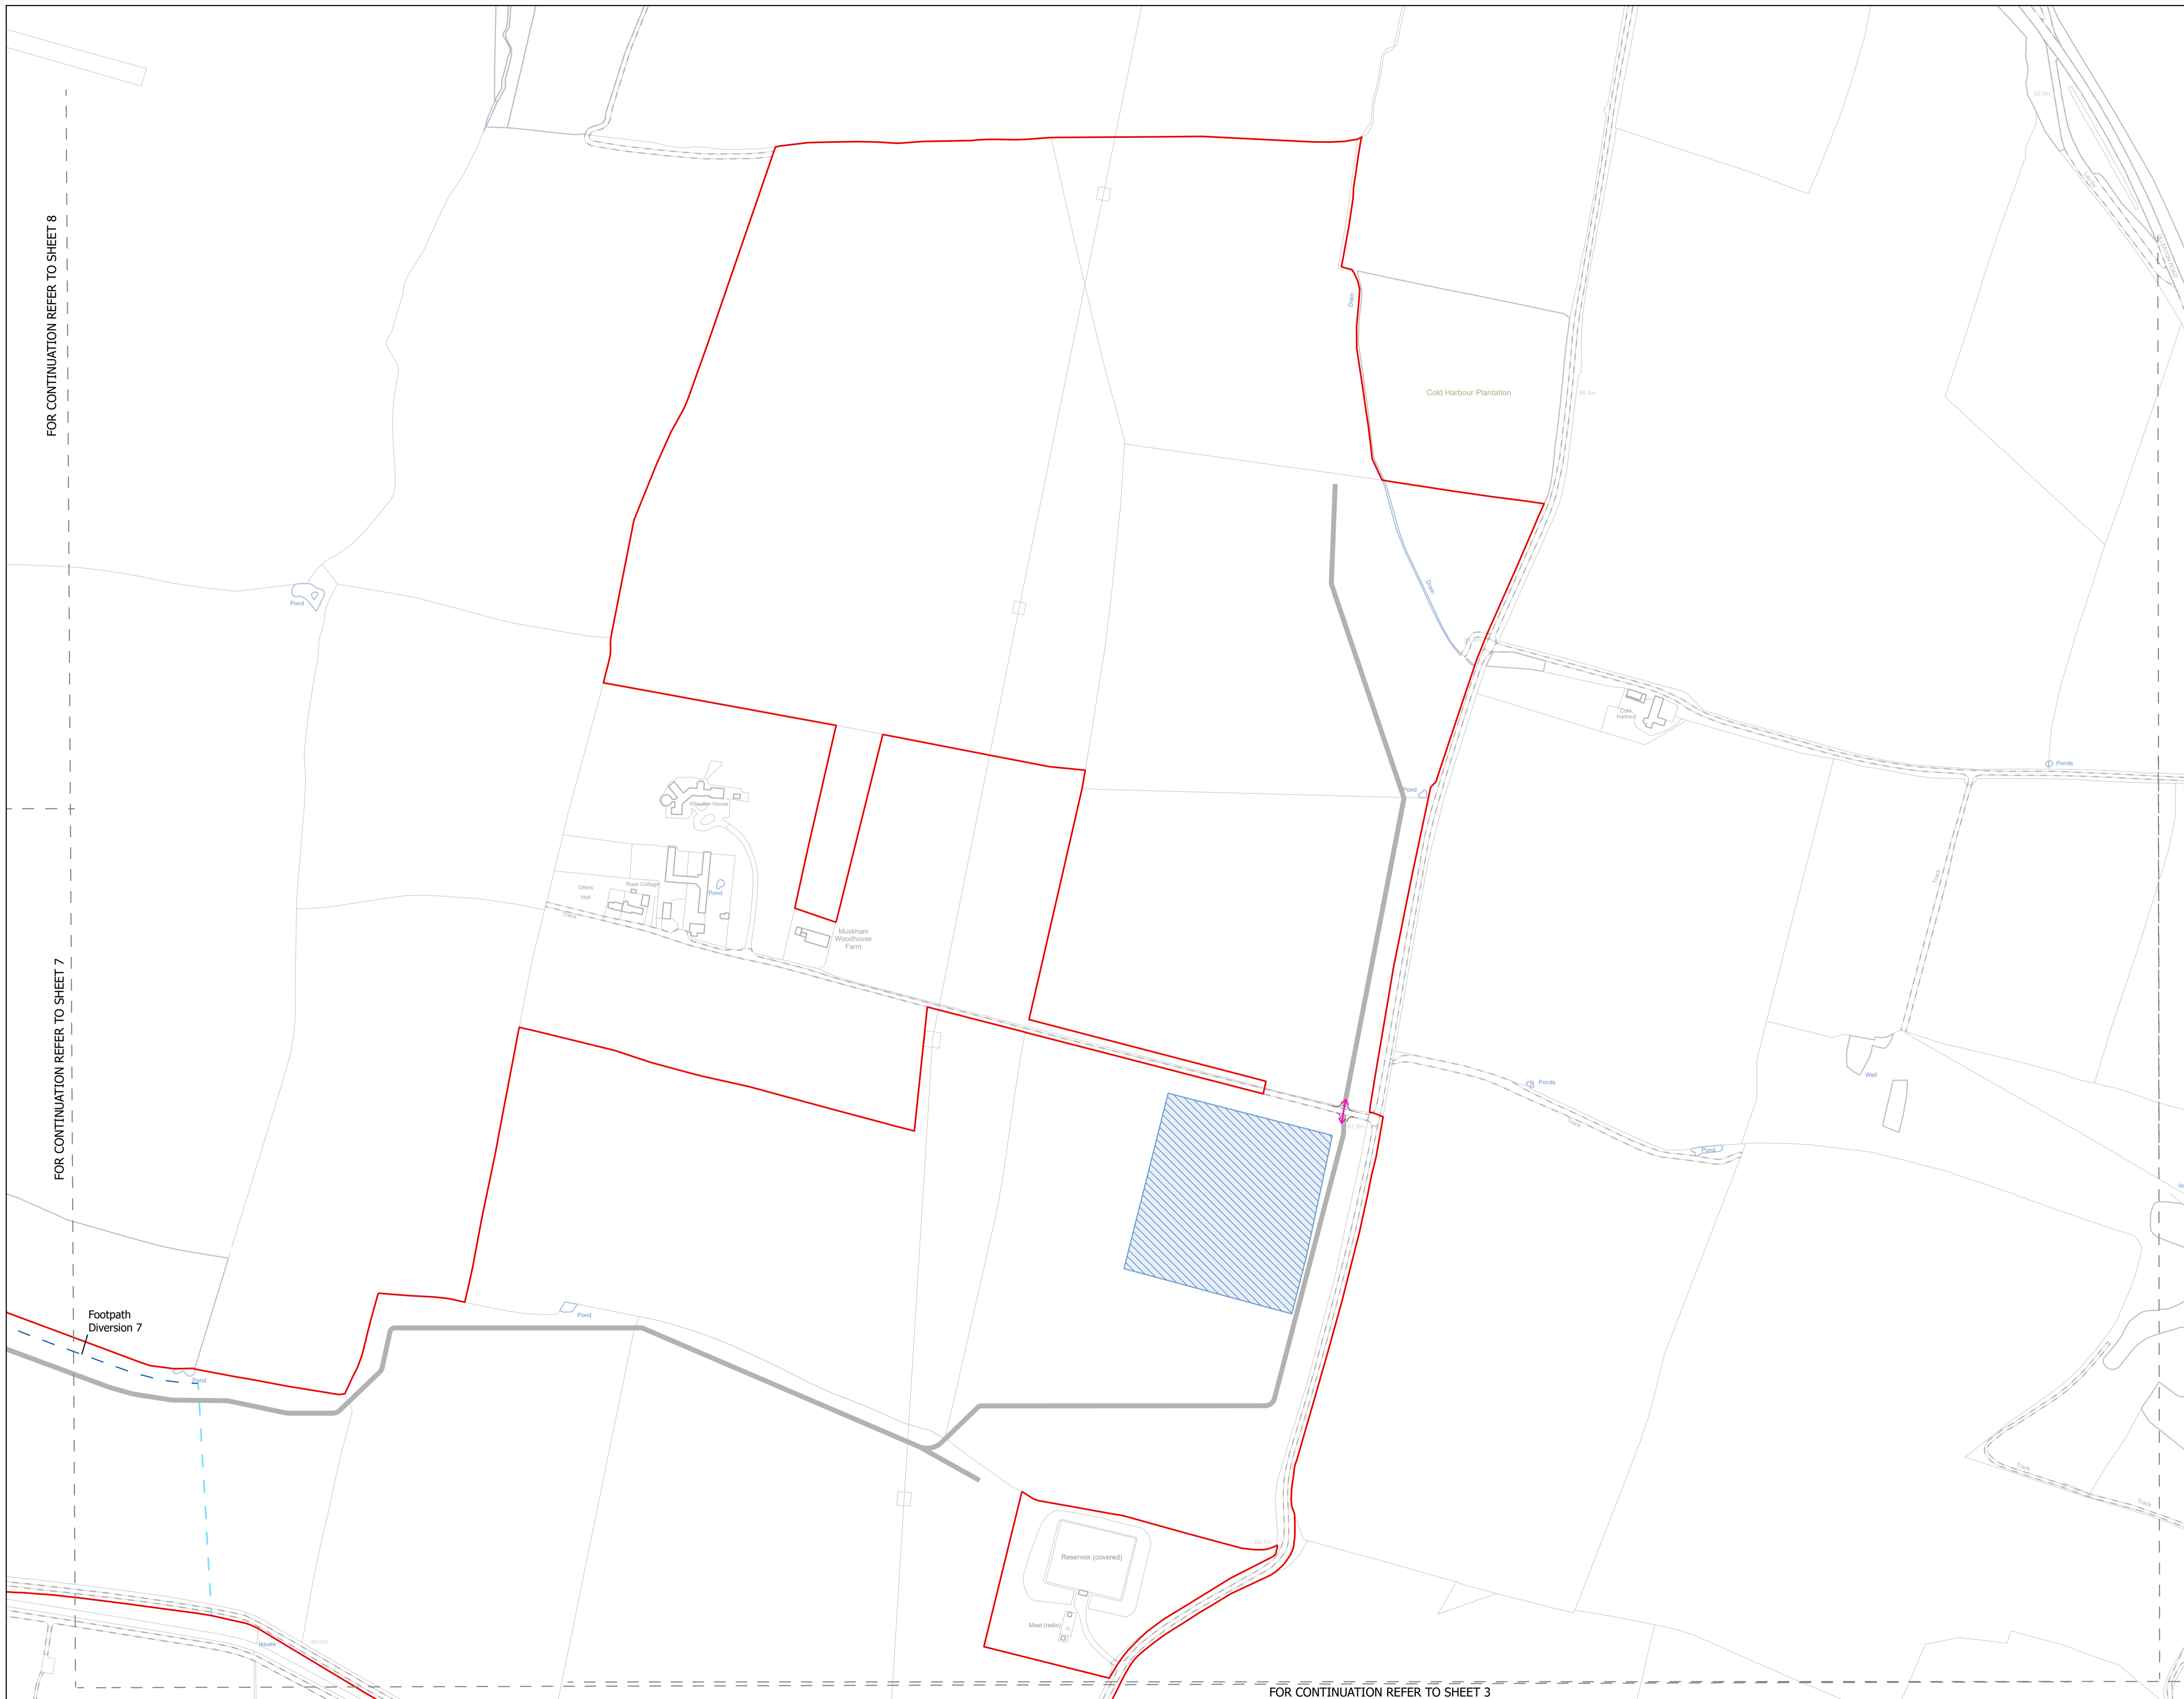

FOR CONTINUATION REFER TO SHEET 8


FOR CONTINUATION REFER TO SHEET 7

FOR CONTINUATION REFER TO SHEET 3

NOTES
1. ALL DIMENSIONS ARE IN METRES UNLESS STATED OTHERWISE.

- Legend**
- Order Limits
 - ↑ Construction Only Access Point
 - ↑ Maintenance and Construction Access Point
 - ↑ Maintenance Access and Construction Cross Over Point
 - Footpath Closure
 - Footpath Diversion
 - Bridleway Closed For Construction and Decommissioning
 - New Permissive Footpath
 - New Permissive Bridleway
 - Bridleway Diversion for Construction and Decommissioning
 - Access Bellmouth
 - Passing Places
 - HDD Connection Channel
 - HDD Compound Pull-Back Rig
 - HDD Compound Rig Side
 - Internal Tarmac Roads
 - Internal Stone Roads
 - Temporary Construction Roads
 - Main Compound Areas
 - Satellite Compound Areas

The Legend is identical on all sheets of the Illustrative Construction Layout and therefore not all items specified in the Legend are found on each sheet

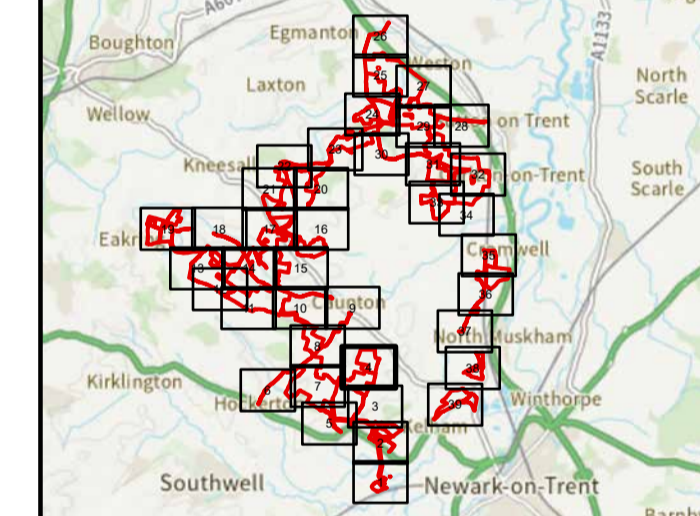

Revision	By	Check	Date	Suffix
Revision 3	AD	LA	14/04/2026	Rev03
Revision 2	AD	LA	14/01/2026	Rev02
Revision 1	AD	LA	24/06/2025	Rev01

Applicant: Elements Green Trent Limited



Project Title:
GREAT NORTH ROAD SOLAR AND BIODIVERSITY PARK

Purpose of Issue:
DCO APPLICATION

Development Consent Order Number:
EN010162

Development Consent Order Drawing Number:
EN010162/APP/6.3.5.5B

Drawing Title:
Illustrative Construction Layout SHEET 4 of 39


Designed:	Drawn:	Checked:	Date:
AD	AD	LA	14/04/2026


Internal Project Number:
026

Suitability:
DCO Application

Scale @ A1:
1:2,500

Rev:
Rev03

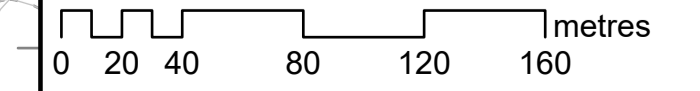

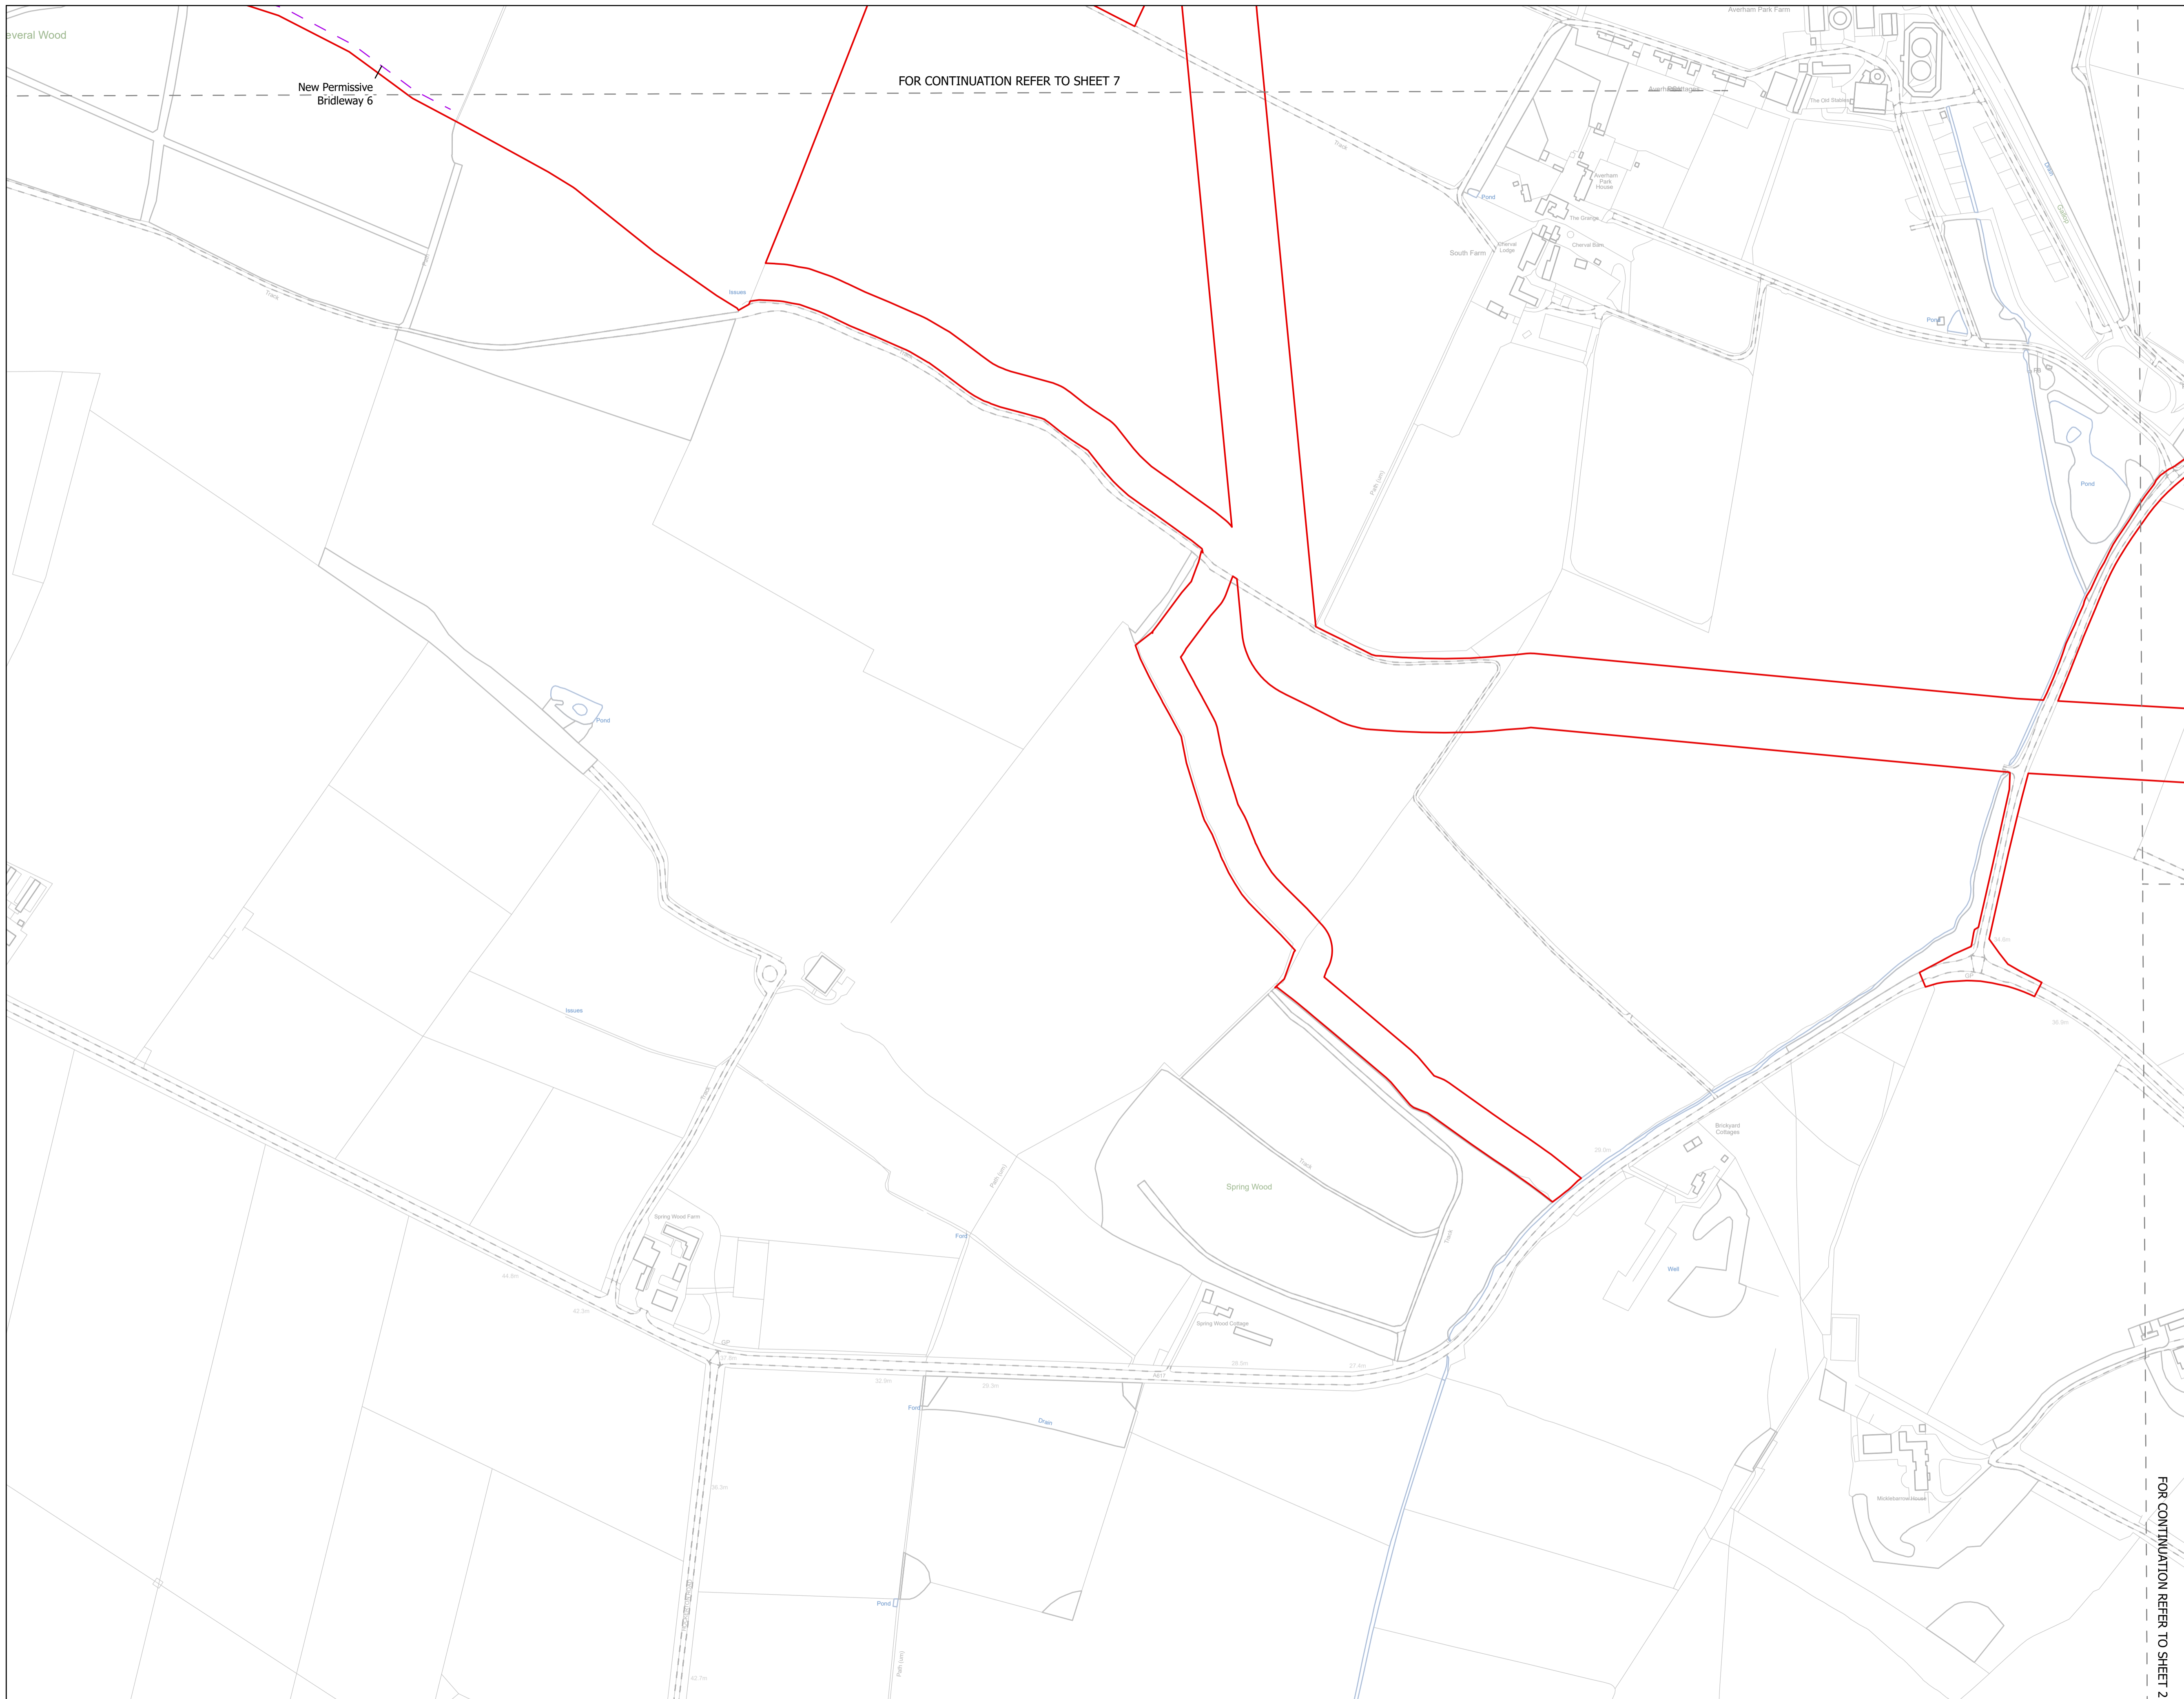


FOR CONTINUATION REFER TO SHEET 7

FOR CONTINUATION REFER TO SHEET 3

NOTES
1. ALL DIMENSIONS ARE IN METRES UNLESS STATED OTHERWISE.

- Legend**
- Order Limits
 - ↑ Construction Only Access Point
 - ↑ Maintenance and Construction Access Point
 - ↑ Maintenance Access and Construction Cross Over Point
 - Footpath Closure
 - Footpath Diversion
 - Bridleway Closed For Construction and Decommissioning
 - New Permissive Footpath
 - New Permissive Bridleway
 - Bridleway Diversion for Construction and Decommissioning
 - Access Bellmouth
 - Passing Places
 - HDD Connection Channel
 - HDD Compound Pull-Back Rig
 - HDD Compound Rig Side
 - Internal Tarmac Roads
 - Internal Stone Roads
 - Temporary Construction Roads
 - Main Compound Areas
 - Satellite Compound Areas

The Legend is identical on all sheets of the Illustrative Construction Layout and therefore not all items specified in the Legend are found on each sheet

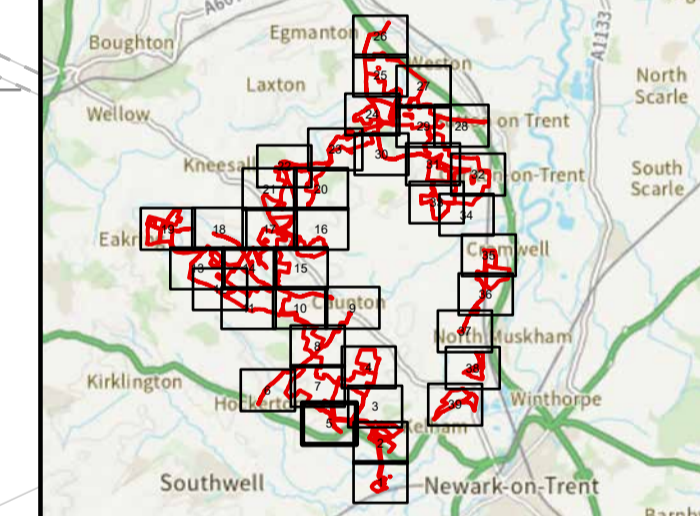

Revision 3	AD	LA	14/04/2026	Rev03
Revision 2	AD	LA	14/01/2026	Rev02
Revision 1	AD	LA	24/06/2025	Rev01
Revision Details	By	Check	Date	Suffix



Project Title:
GREAT NORTH ROAD SOLAR AND BIODIVERSITY PARK

Purpose of Issue:
DCO APPLICATION


Development Consent Order Number:
EN010162

Development Consent Order Drawing Number:
EN010162/APP/6.3.5.5B


Drawing Title:
Illustrative Construction Layout SHEET 5 of 39

Designed: AD	Drawn: AD	Checked: LA	Date: 14/04/2026
Internal Project Number: 026		Suitability: DCO Application	

Scale @ A1:
1:2,500

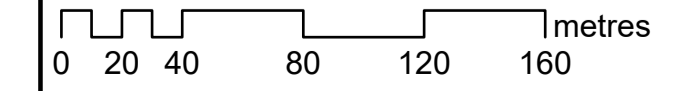


FOR CONTINUATION REFER TO SHEET 2

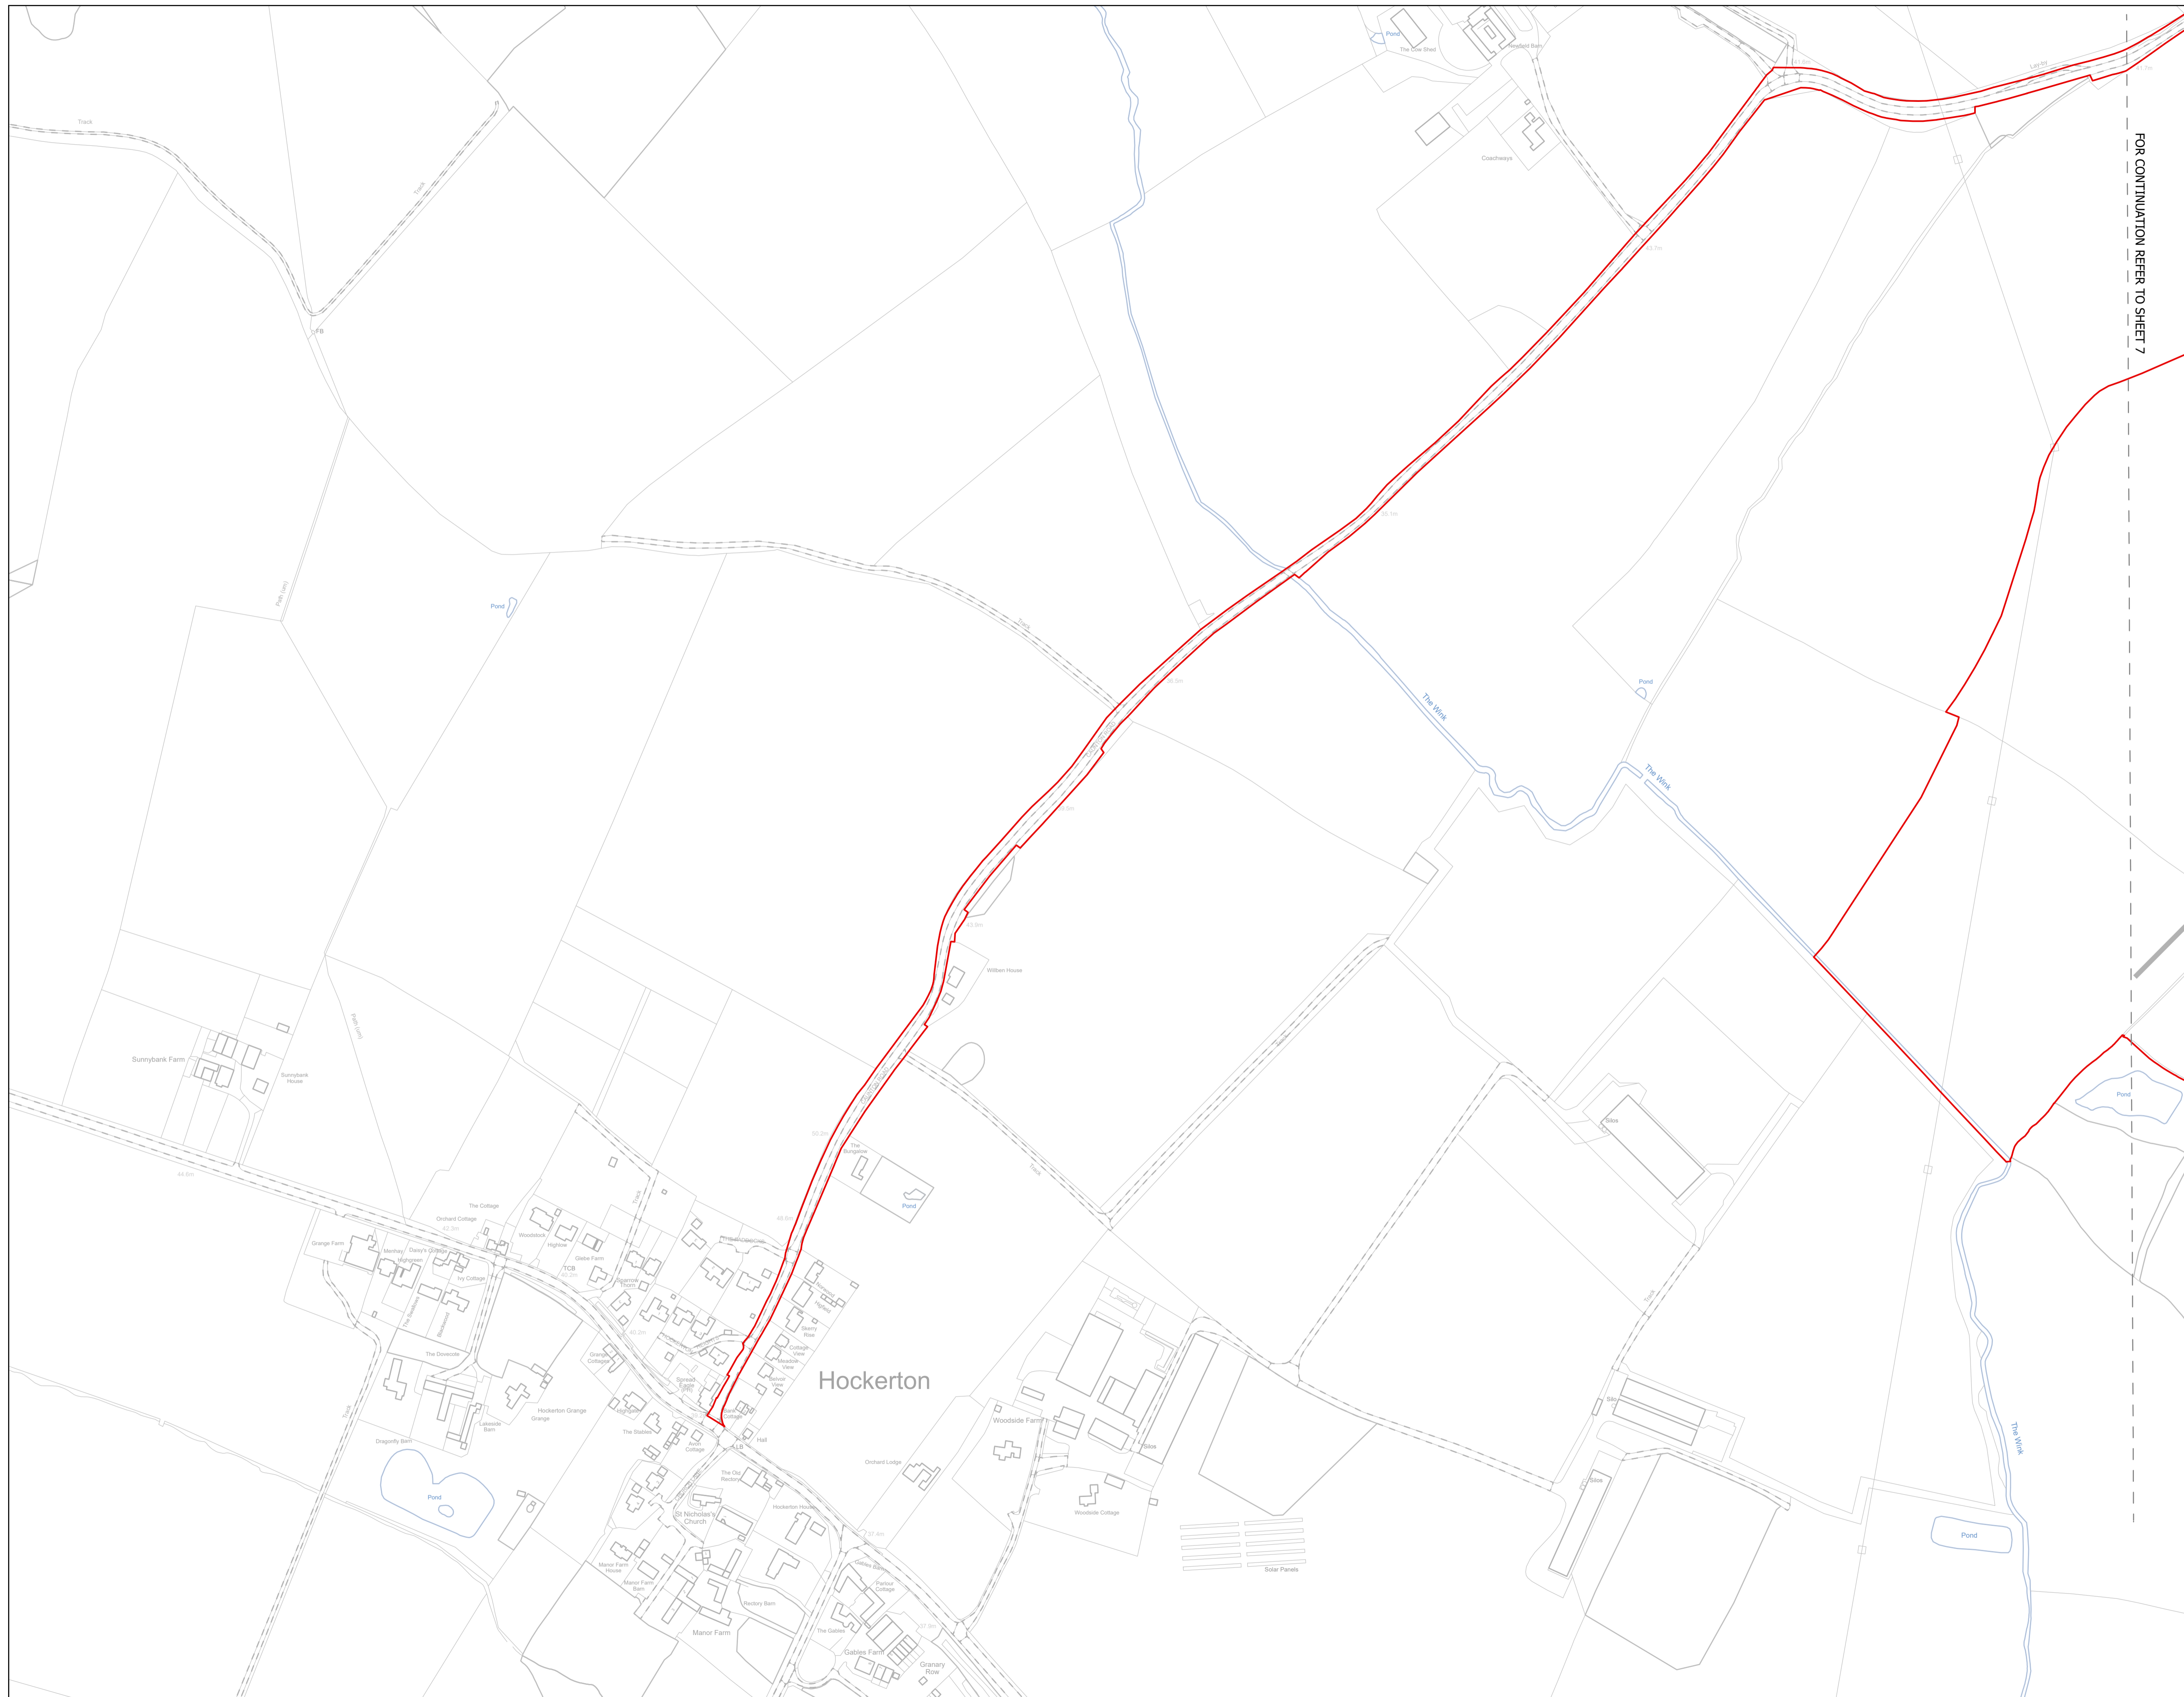

NOTES
1. ALL DIMENSIONS ARE IN METRES UNLESS STATED OTHERWISE.

- Legend**
- Order Limits
 - ↑ Construction Only Access Point
 - ↑ Maintenance and Construction Access Point
 - ↑ Maintenance Access and Construction Cross Over Point
 - Footpath Closure
 - Footpath Diversion
 - Bridleway Closed For Construction and Decommissioning
 - New Permissive Footpath
 - New Permissive Bridleway
 - Bridleway Diversion for Construction and Decommissioning
 - Access Bellmouth
 - Passing Places
 - HDD Connection Channel
 - HDD Compound Pull-Back Rig
 - HDD Compound Rig Side
 - Internal Tarmac Roads
 - Internal Stone Roads
 - Temporary Construction Roads
 - Main Compound Areas
 - Satellite Compound Areas

The Legend is identical on all sheets of the Illustrative Construction Layout and therefore not all items specified in the Legend are found on each sheet

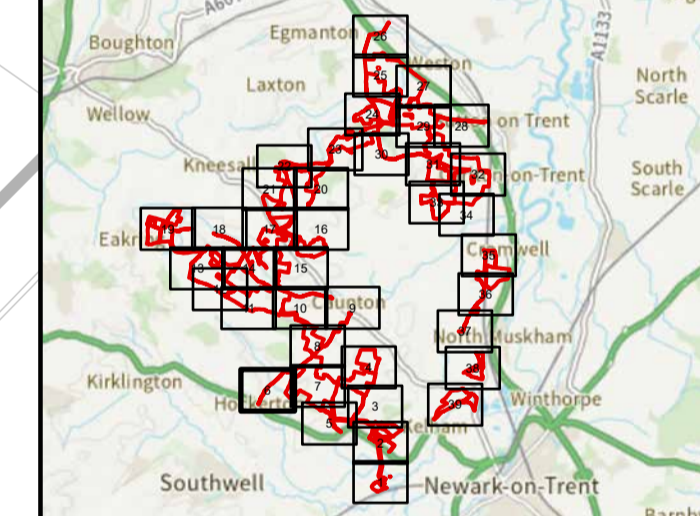

Revision 3	AD	LA	14/04/2026	Rev03
Revision 2	AD	LA	14/01/2026	Rev02
Revision 1	AD	LA	24/06/2025	Rev01
Revision Details	By	Check	Date	Suffix

Applicant: Elements Green Trent Limited

Solar & Biodiversity Park

Project Title:
GREAT NORTH ROAD SOLAR AND BIODIVERSITY PARK

Purpose of Issue:
DCO APPLICATION

Development Consent Order Number:
EN010162

Development Consent Order Drawing Number:
EN010162/APP/6.3.5.5B


Drawing Title:
Illustrative Construction Layout SHEET 6 of 39


Designed: AD	Drawn: AD	Checked: LA	Date: 14/04/2026
-----------------	--------------	----------------	---------------------

Internal Project Number: 026	Suitability: DCO Application
---------------------------------	---------------------------------

Scale @ A1:
1:2,500

N	Rev: Rev03
---	---------------

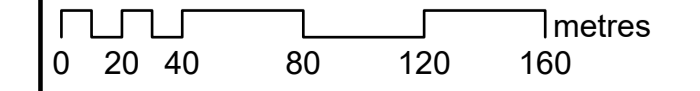

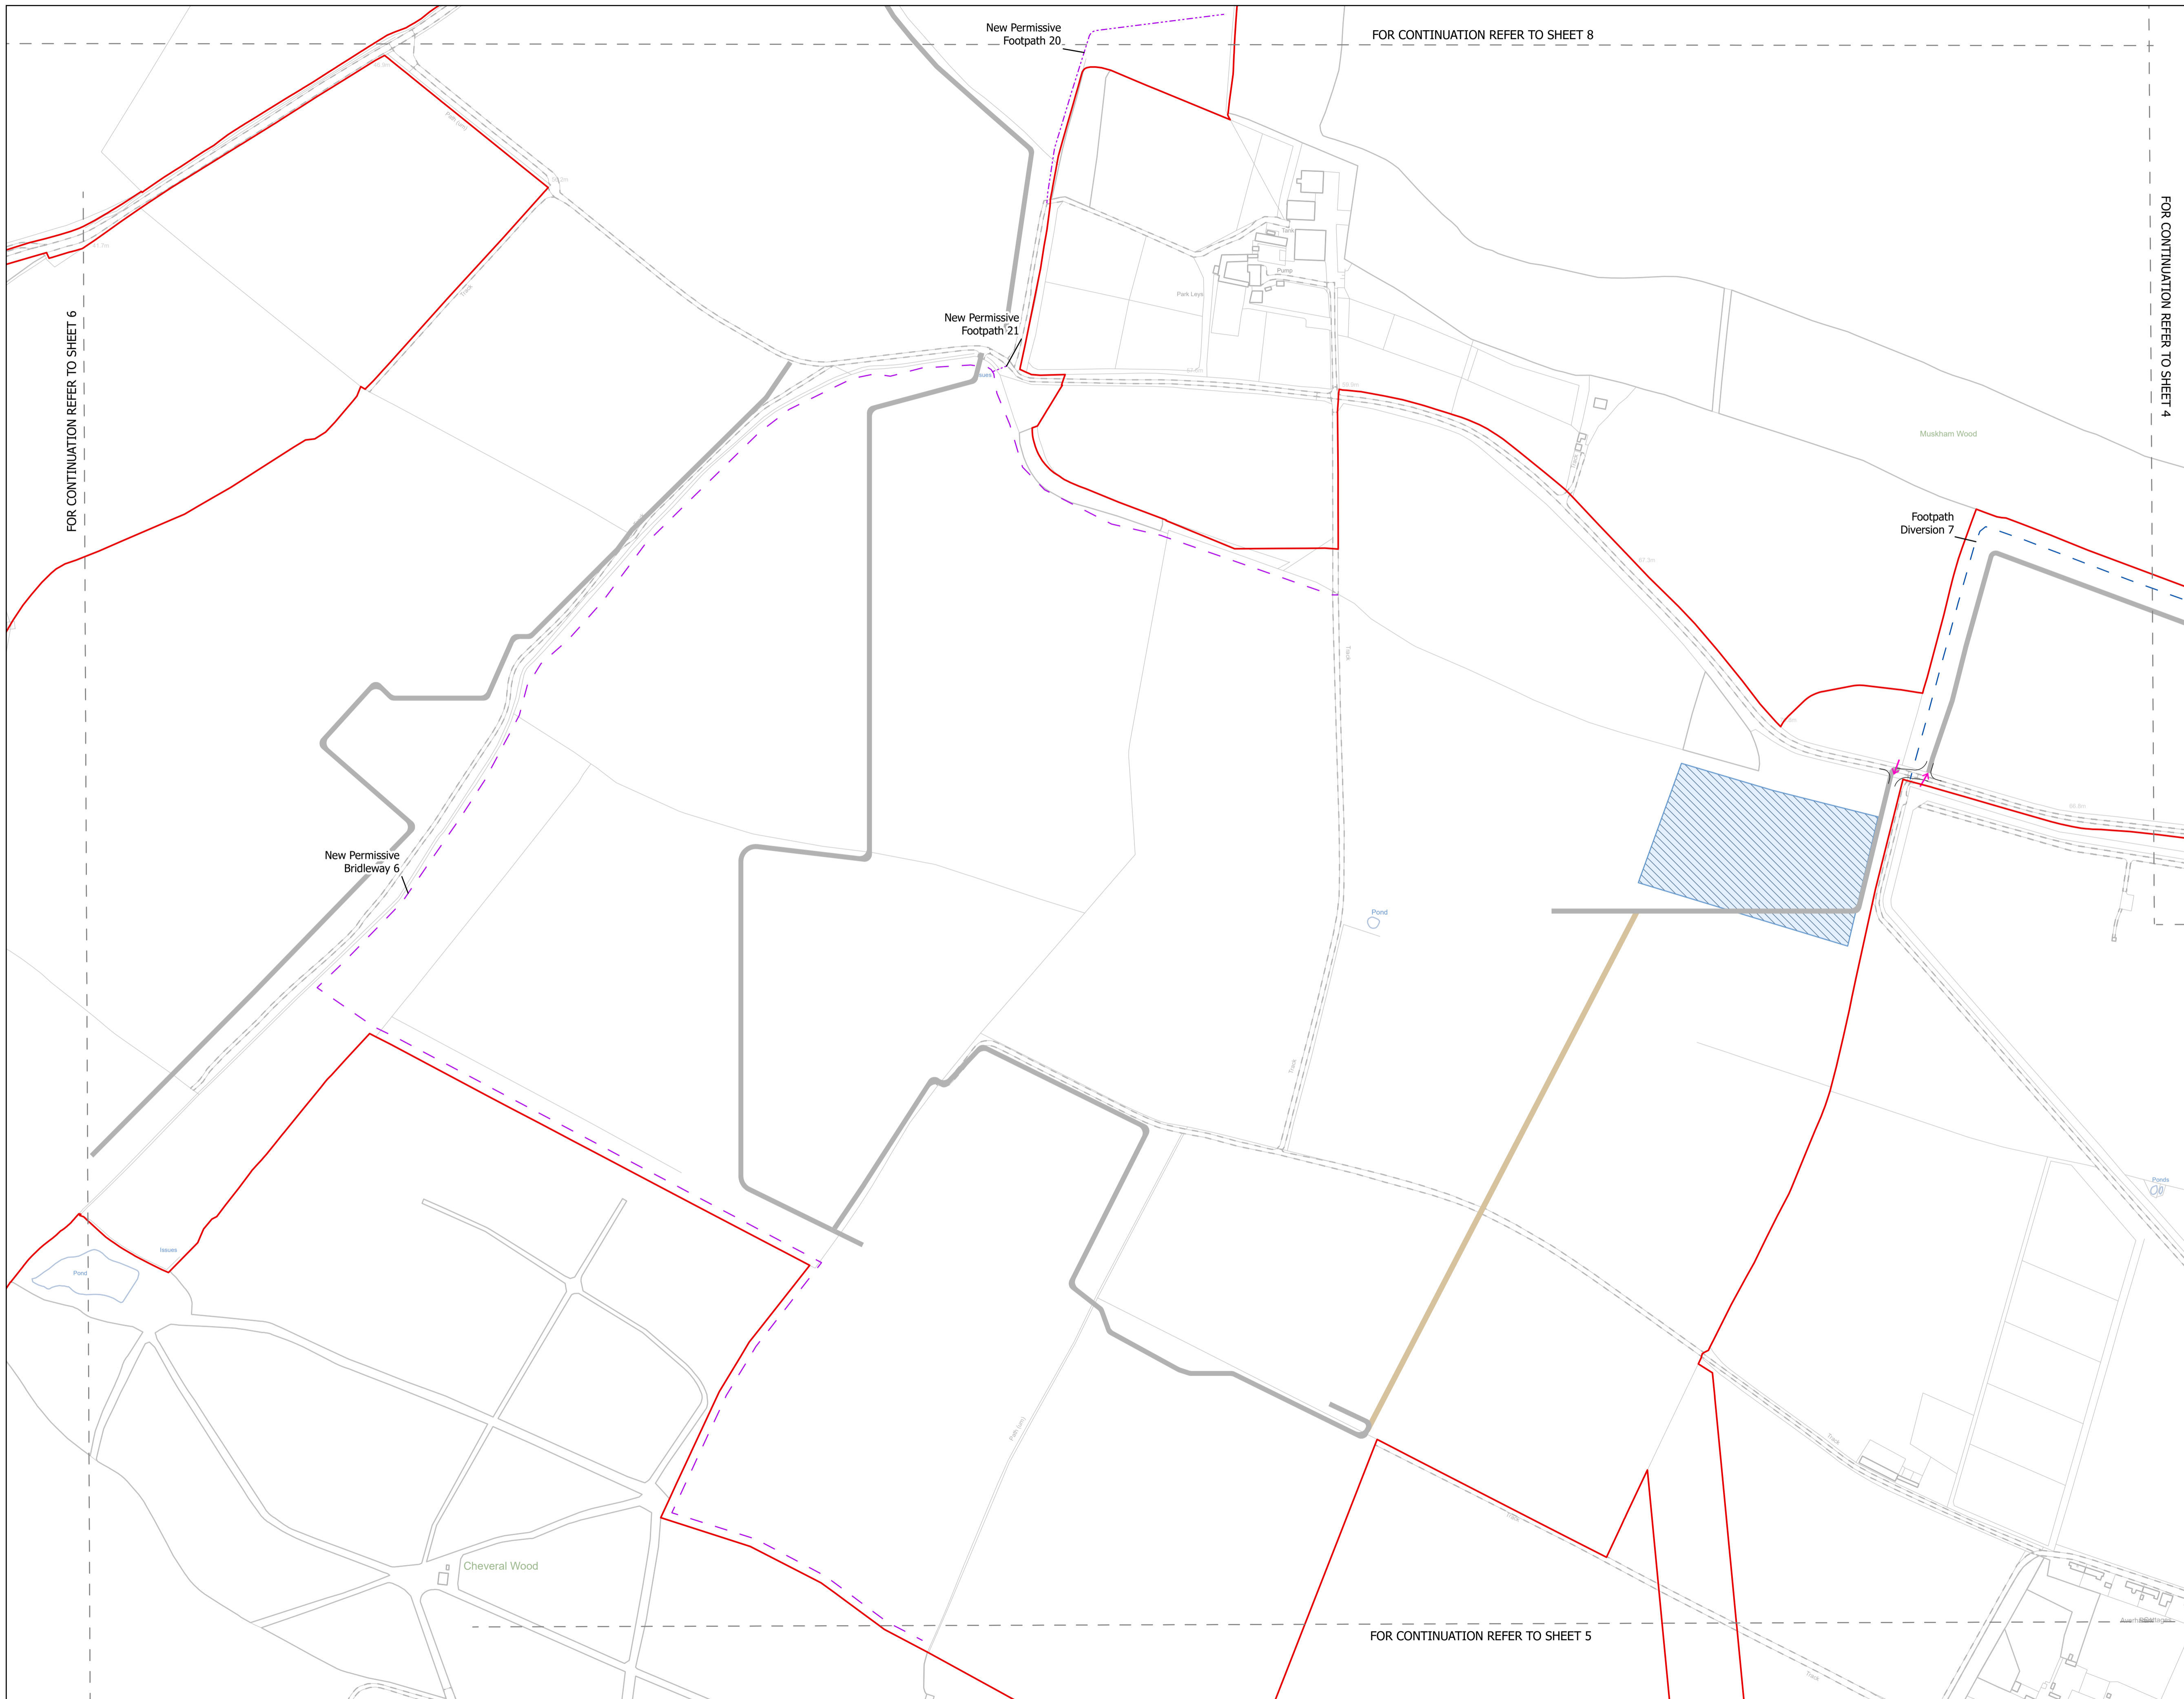

FOR CONTINUATION REFER TO SHEET 6

FOR CONTINUATION REFER TO SHEET 8


FOR CONTINUATION REFER TO SHEET 4

FOR CONTINUATION REFER TO SHEET 5

NOTES
1. ALL DIMENSIONS ARE IN METRES UNLESS STATED OTHERWISE.

- Legend**
- Order Limits
 - ↑ Construction Only Access Point
 - ↑ Maintenance and Construction Access Point
 - ↑ Maintenance Access and Construction Cross Over Point
 - Footpath Closure
 - Footpath Diversion
 - Bridleway Closed For Construction and Decommissioning
 - New Permissive Footpath
 - New Permissive Bridleway
 - Bridleway Diversion for Construction and Decommissioning
 - Access Bellmouth
 - Passing Places
 - HDD Connection Channel
 - HDD Compound Pull-Back Rig
 - HDD Compound Rig Side
 - Internal Tarmac Roads
 - Internal Stone Roads
 - Temporary Construction Roads
 - Main Compound Areas
 - Satellite Compound Areas

The Legend is identical on all sheets of the Illustrative Construction Layout and therefore not all items specified in the Legend are found on each sheet

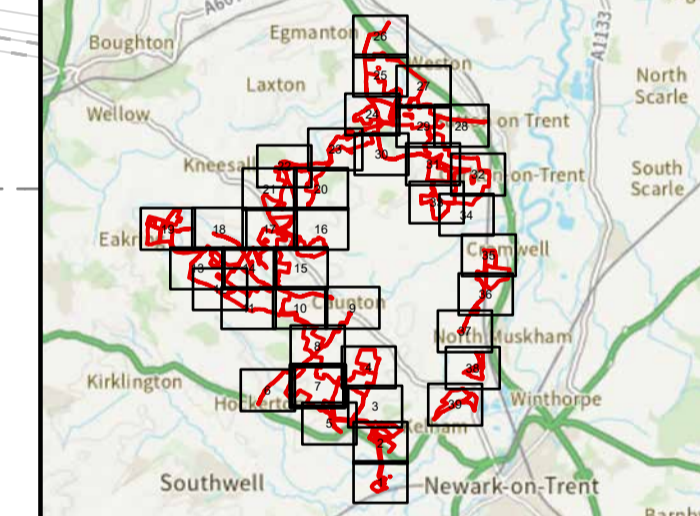

Revision 3	AD	LA	14/04/2026	Rev03
Revision 2	AD	LA	14/01/2026	Rev02
Revision 1	AD	LA	24/06/2025	Rev01
Revision Details	By	Check	Date	Suffix



Project Title:
GREAT NORTH ROAD SOLAR AND BIODIVERSITY PARK

Purpose of Issue:
DCO APPLICATION

Development Consent Order Number:
EN010162


Development Consent Order Drawing Number:
EN010162/APP/6.3.5.5B

Drawing Title:
Illustrative Construction Layout SHEET 7 of 39

Designed: AD	Drawn: AD	Checked: LA	Date: 14/04/2026
Internal Project Number: 026		Suitability: DCO Application	

Scale @ A1:
1:2,500

N	Rev: Rev03
---	---------------

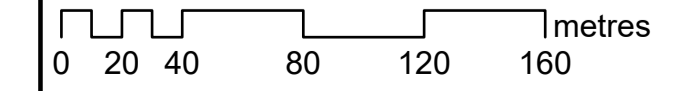

FOR CONTINUATION REFER TO SHEET 10


FOR CONTINUATION REFER TO SHEET 9

NOTES
1. ALL DIMENSIONS ARE IN METRES UNLESS STATED OTHERWISE.


Legend

- Order Limits
- ↑ Construction Only Access Point
- ↑ Maintenance and Construction Access Point
- ↑ Maintenance Access and Construction Cross Over Point
- Footpath Closure
- Footpath Diversion
- Bridleway Closed For Construction and Decommissioning
- New Permissive Footpath
- New Permissive Bridleway
- Bridleway Diversion for Construction and Decommissioning
- Access Bellmouth
- Passing Places
- HDD Connection Channel
- HDD Compound Pull-Back Rig
- HDD Compound Rig Side
- Internal Tarmac Roads
- Internal Stone Roads
- Temporary Construction Roads
- Main Compound Areas
- Satellite Compound Areas

The Legend is identical on all sheets of the Illustrative Construction Layout and therefore not all items specified in the Legend are found on each sheet

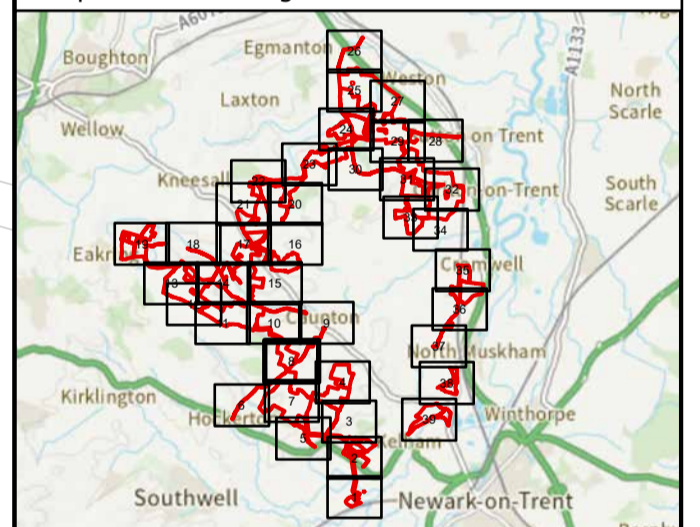

Revision 3	AD	LA	14/04/2026	Rev03
Revision 2	AD	LA	14/01/2026	Rev02
Revision 1	AD	LA	24/06/2025	Rev01
Revision Details	By	Check	Date	Suffix

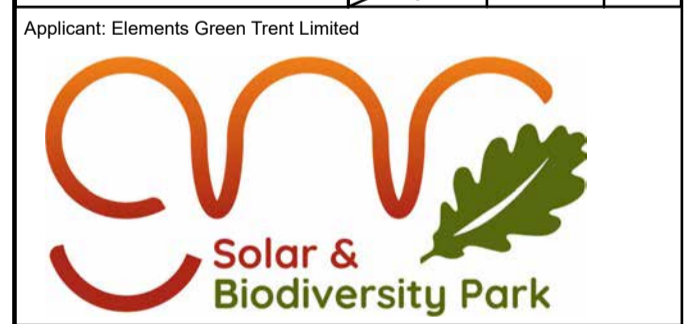

Project Title:
GREAT NORTH ROAD SOLAR AND BIODIVERSITY PARK

Purpose of Issue:
DCO APPLICATION

Development Consent Order Number:
EN010162

Development Consent Order Drawing Number:
EN010162/APP/6.3.5.5B

Drawing Title:
Illustrative Construction Layout SHEET 8 of 39


Designed: AD	Drawn: AD	Checked: LA	Date: 14/04/2026
-----------------	--------------	----------------	---------------------

Internal Project Number:
026

Suitability:
DCO Application

Scale @ A1:
1:2,500


N	Rev: Rev03
---	---------------

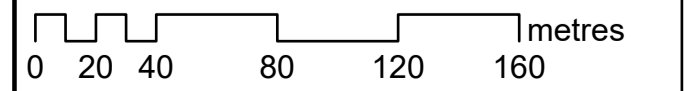

FOR CONTINUATION REFER TO SHEET 4

New Permissive Footpath 20

FOR CONTINUATION REFER TO SHEET 7

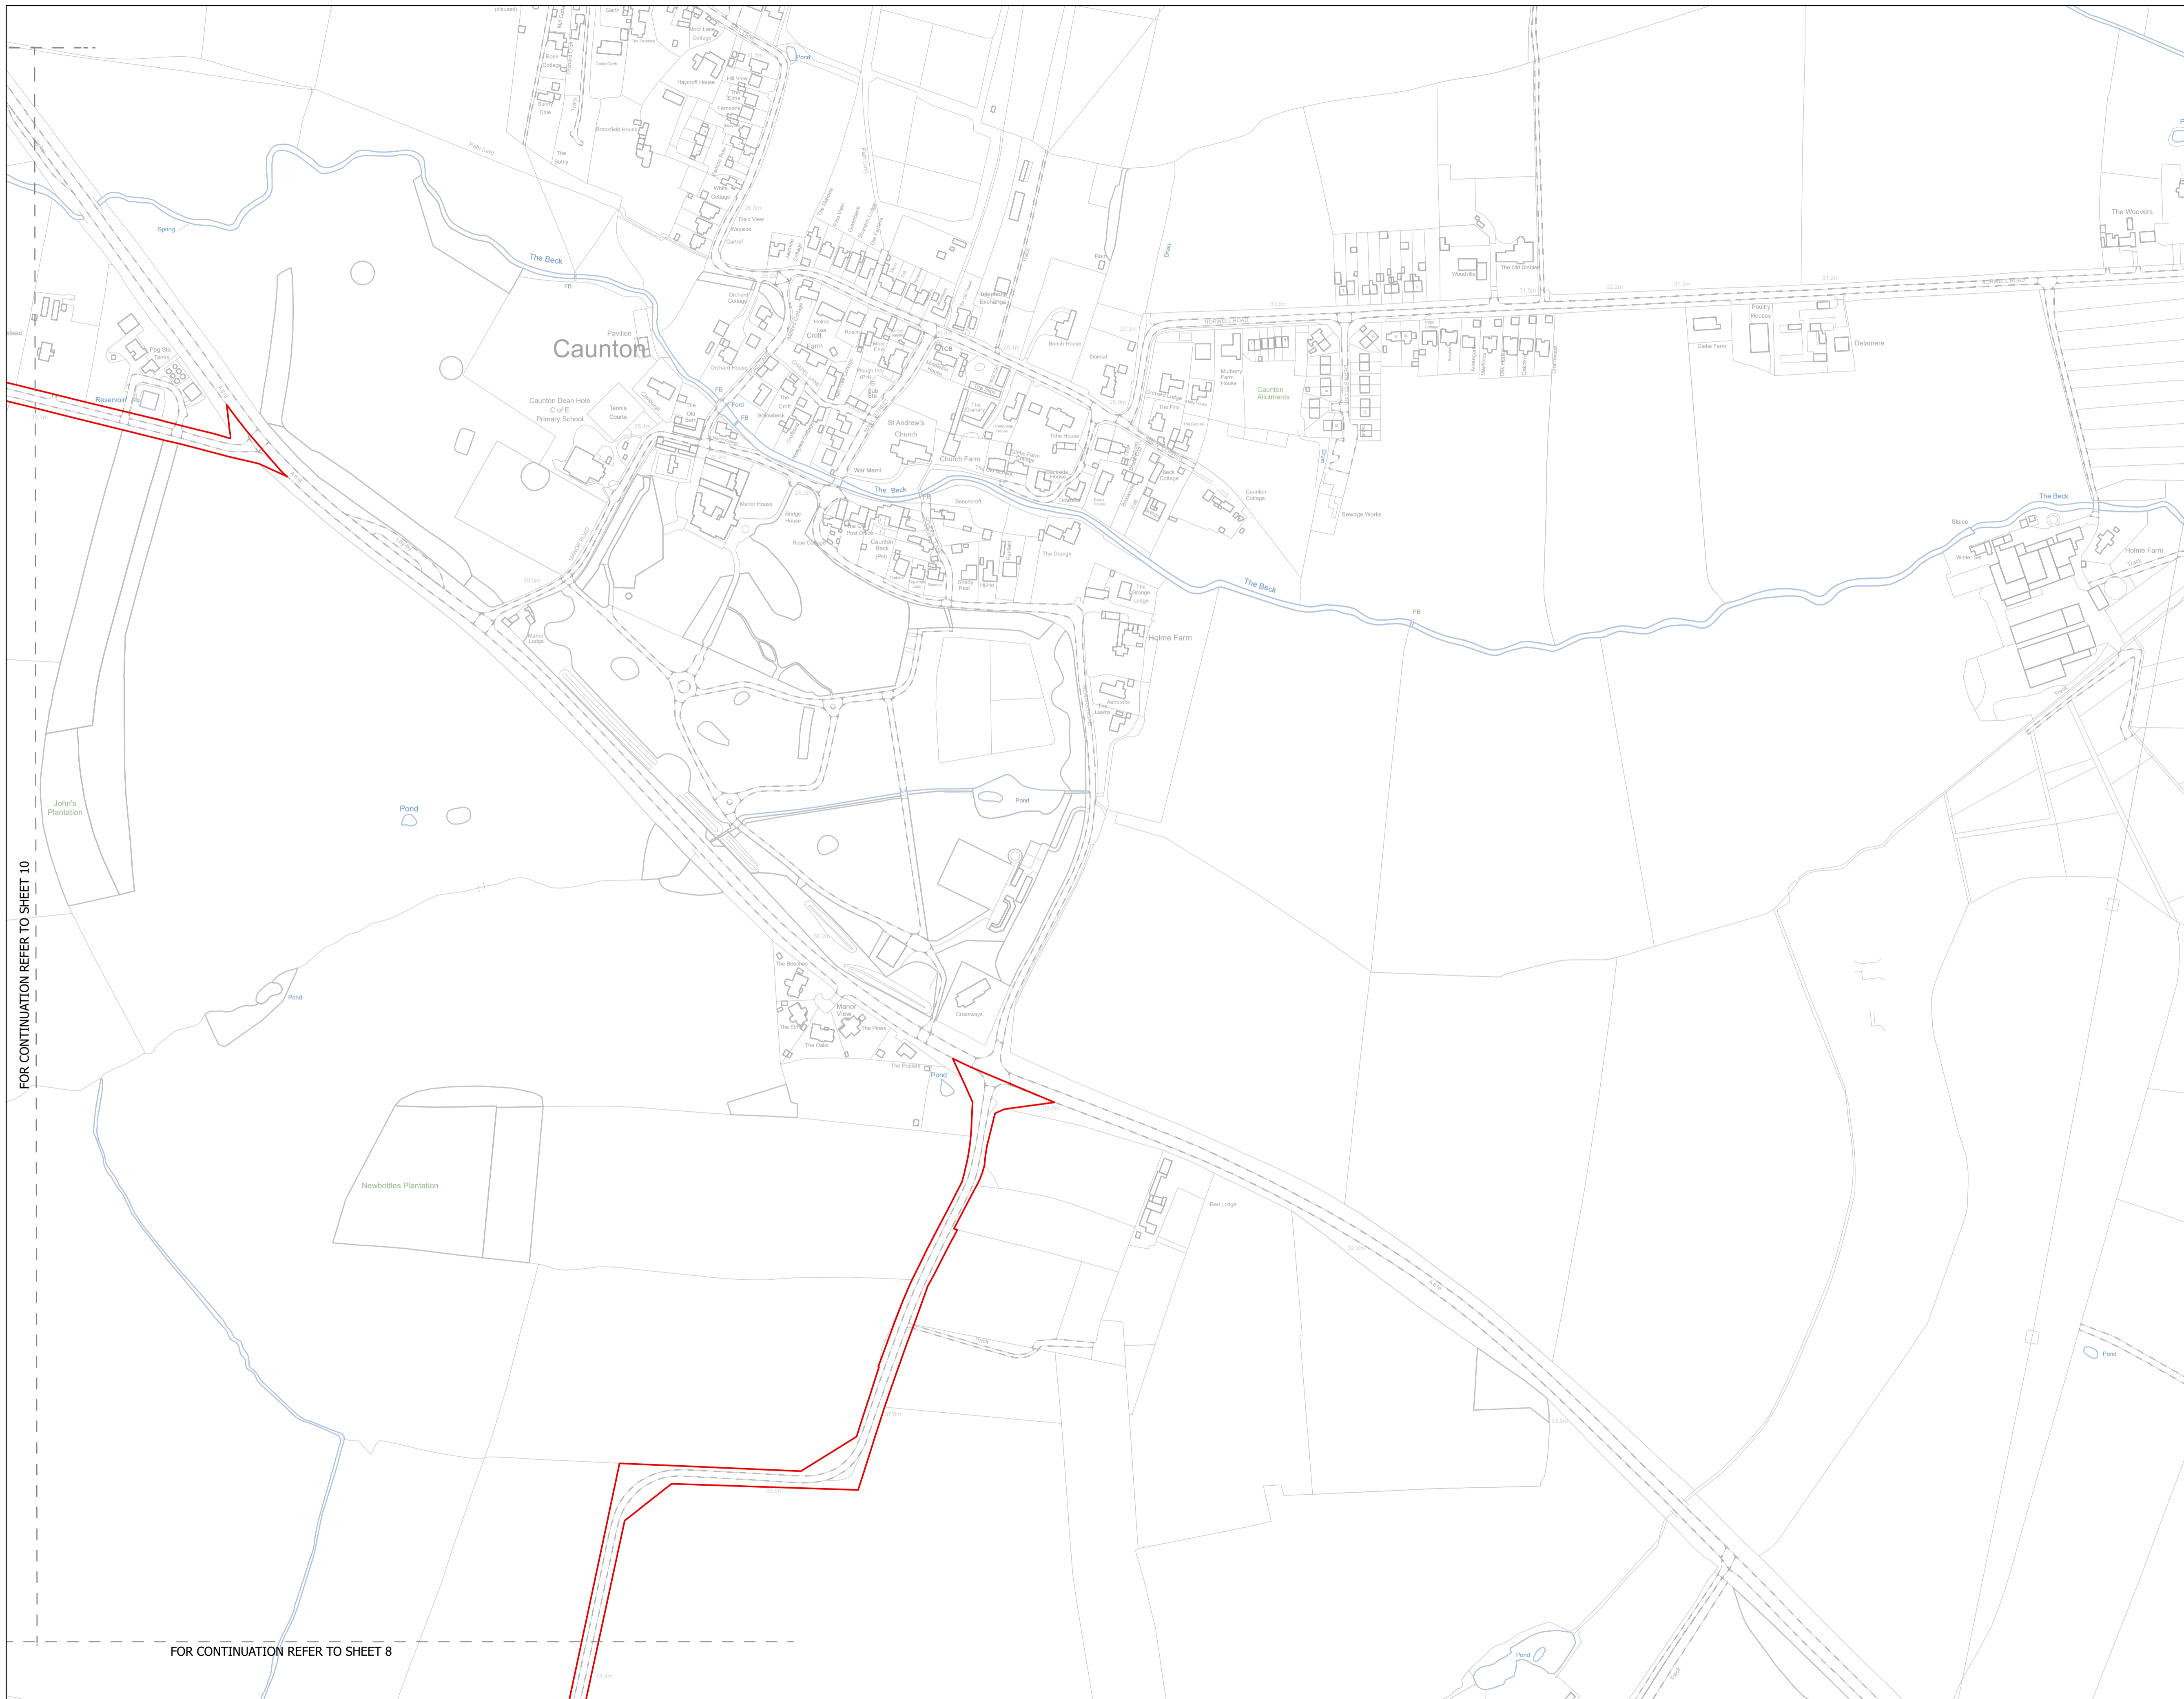

FOR CONTINUATION REFER TO SHEET 10


FOR CONTINUATION REFER TO SHEET 8

NOTES
1. ALL DIMENSIONS ARE IN METRES UNLESS STATED OTHERWISE.

Legend

- Order Limits
- ↑ Construction Only Access Point
- ↑ Maintenance and Construction Access Point
- ↑ Maintenance Access and Construction Cross Over Point
- Footpath Closure
- Footpath Diversion
- Bridleway Closed For Construction and Decommissioning
- New Permissive Footpath
- New Permissive Bridleway
- Bridleway Diversion for Construction and Decommissioning
- Access Bellmouth
- Passing Places
- HDD Connection Channel
- HDD Compound Pull-Back Rig
- HDD Compound Rig Side
- Internal Tarmac Roads
- Internal Stone Roads
- Temporary Construction Roads
- Main Compound Areas
- Satellite Compound Areas

The Legend is identical on all sheets of the Illustrative Construction Layout and therefore not all items specified in the Legend are found on each sheet

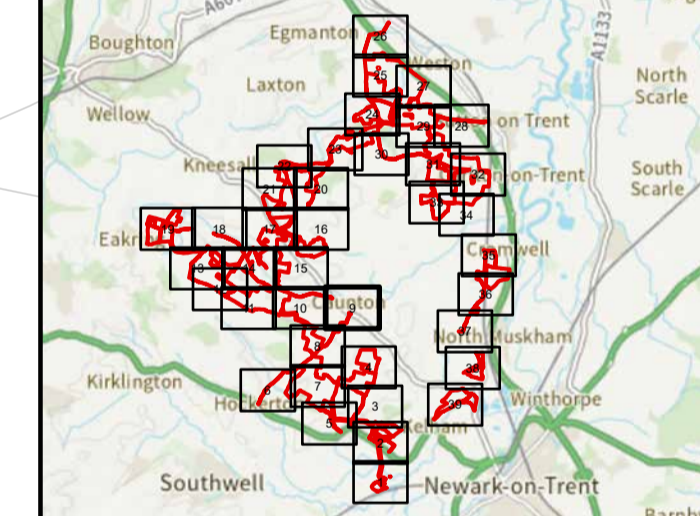

Revision 3	AD	LA	14/04/2026	Rev03
Revision 2	AD	LA	14/01/2026	Rev02
Revision 1	AD	LA	24/06/2025	Rev01
Revision Details	By	Check	Date	Suffix



Project Title:
GREAT NORTH ROAD SOLAR AND BIODIVERSITY PARK

Purpose of Issue:
DCO APPLICATION

Development Consent Order Number:
EN010162


Development Consent Order Drawing Number:
EN010162/APP/6.3.5.5B

Drawing Title:
Illustrative Construction Layout SHEET 9 of 39


Designed: AD	Drawn: AD	Checked: LA	Date: 14/04/2026
Internal Project Number: 026		Suitability: DCO Application	

Scale @ A1:
1:2,500

N	Rev: Rev03
---	---------------

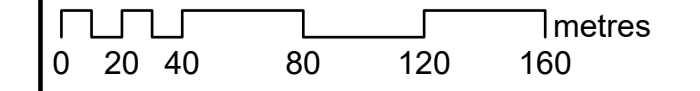


FOR CONTINUATION REFER TO SHEET 15

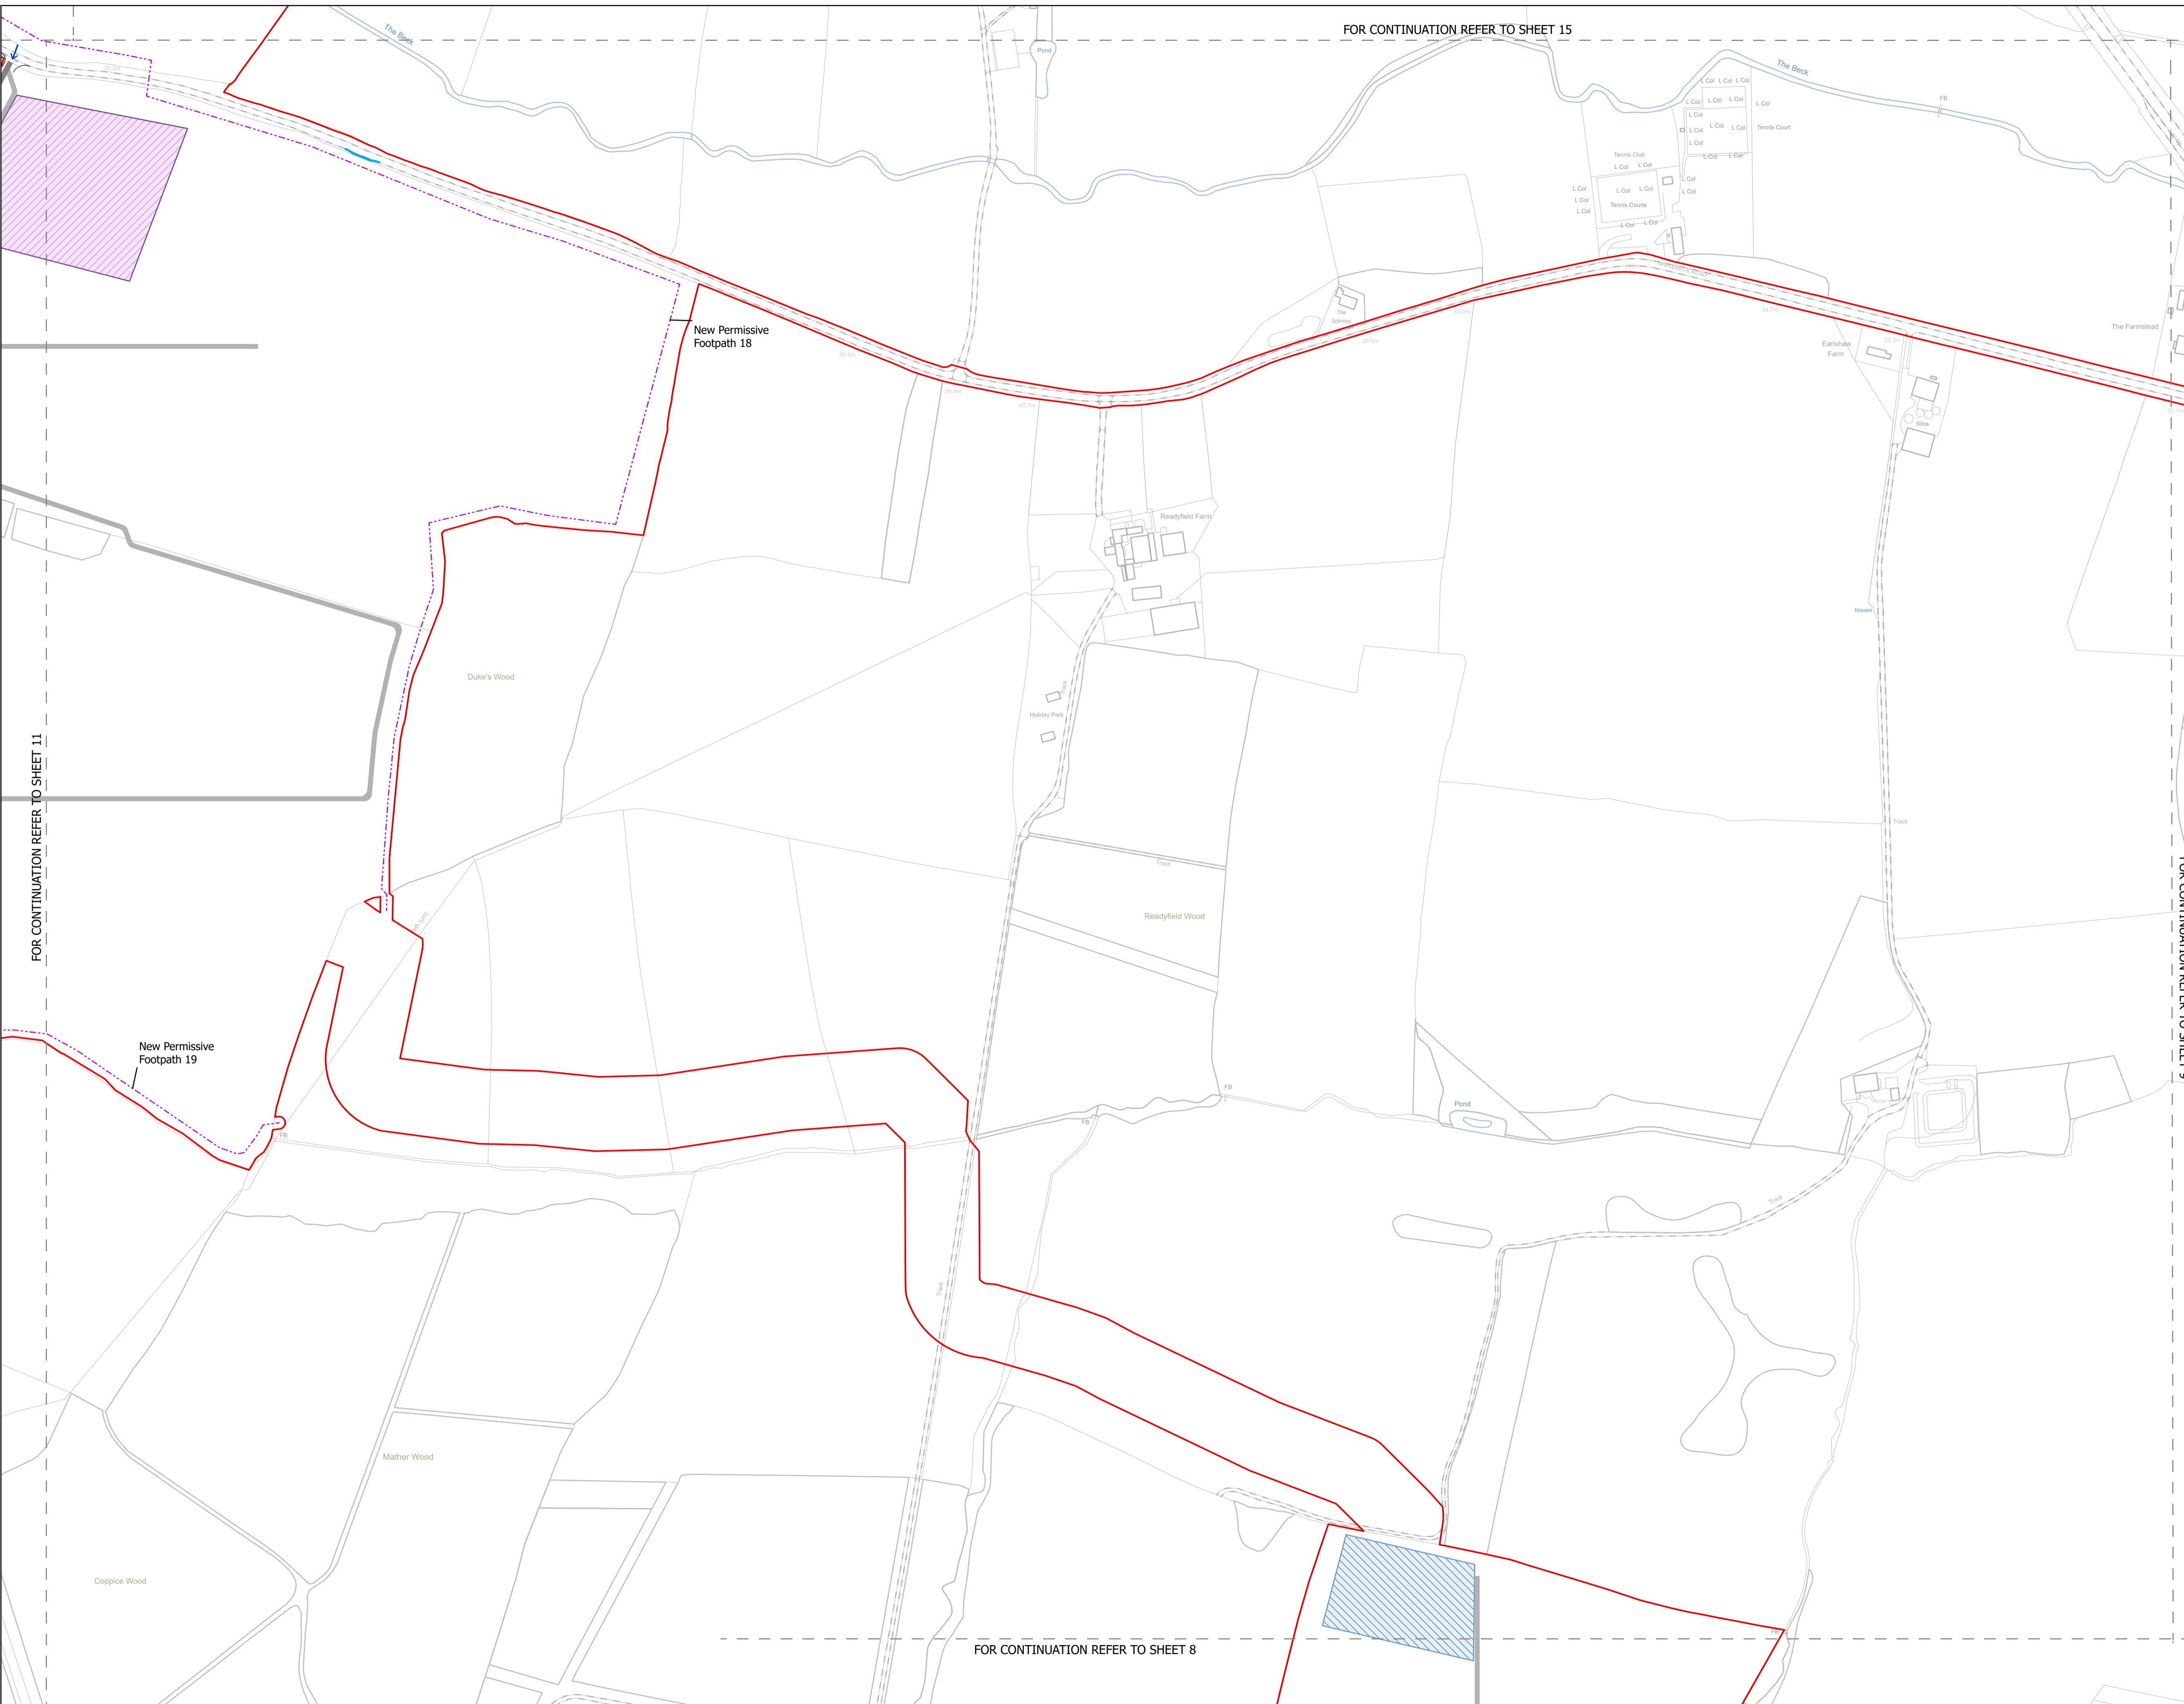

NOTES
1. ALL DIMENSIONS ARE IN METRES UNLESS STATED OTHERWISE.

- Legend**
- Order Limits
 - Construction Only Access Point
 - Maintenance and Construction Access Point
 - Maintenance Access and Construction Cross Over Point
 - Footpath Closure
 - Footpath Diversion
 - Bridleway Closed For Construction and Decommissioning
 - New Permissive Footpath
 - New Permissive Bridleway
 - Bridleway Diversion for Construction and Decommissioning
 - Access Bellmouth
 - Passing Places
 - HDD Connection Channel
 - HDD Compound Pull-Back Rig
 - HDD Compound Rig Side
 - Internal Tarmac Roads
 - Internal Stone Roads
 - Temporary Construction Roads
 - Main Compound Areas
 - Satellite Compound Areas

The Legend is identical on all sheets of the Illustrative Construction Layout and therefore not all items specified in the Legend are found on each sheet

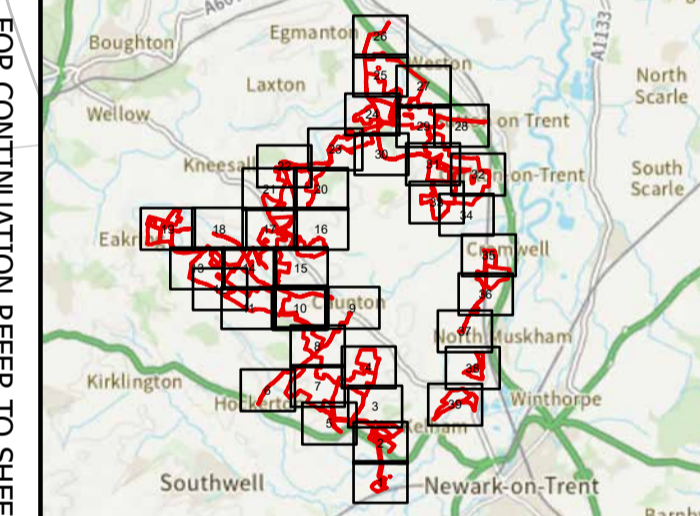

Revision 3	AD	LA	14/04/2026	Rev03
Revision 2	AD	LA	14/01/2026	Rev02
Revision 1	AD	LA	24/06/2025	Rev01
Revision Details	By	Check	Date	Suffix



Project Title:
GREAT NORTH ROAD SOLAR AND BIODIVERSITY PARK

Purpose of Issue:
DCO APPLICATION

Development Consent Order Number:
EN010162


Development Consent Order Drawing Number:
EN010162/APP/6.3.5.5B

Drawing Title:
Illustrative Construction Layout SHEET 10 of 39

Designed: AD	Drawn: AD	Checked: LA	Date: 14/04/2026
Internal Project Number: 026	Suitability: DCO Application		

Scale @ A1:
1:2,500


N	Rev:
	Rev03

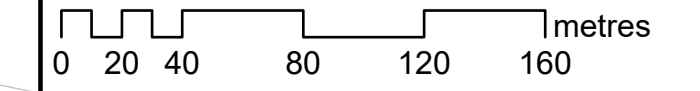

FOR CONTINUATION REFER TO SHEET 8

FOR CONTINUATION REFER TO SHEET 11

FOR CONTINUATION REFER TO SHEET 9

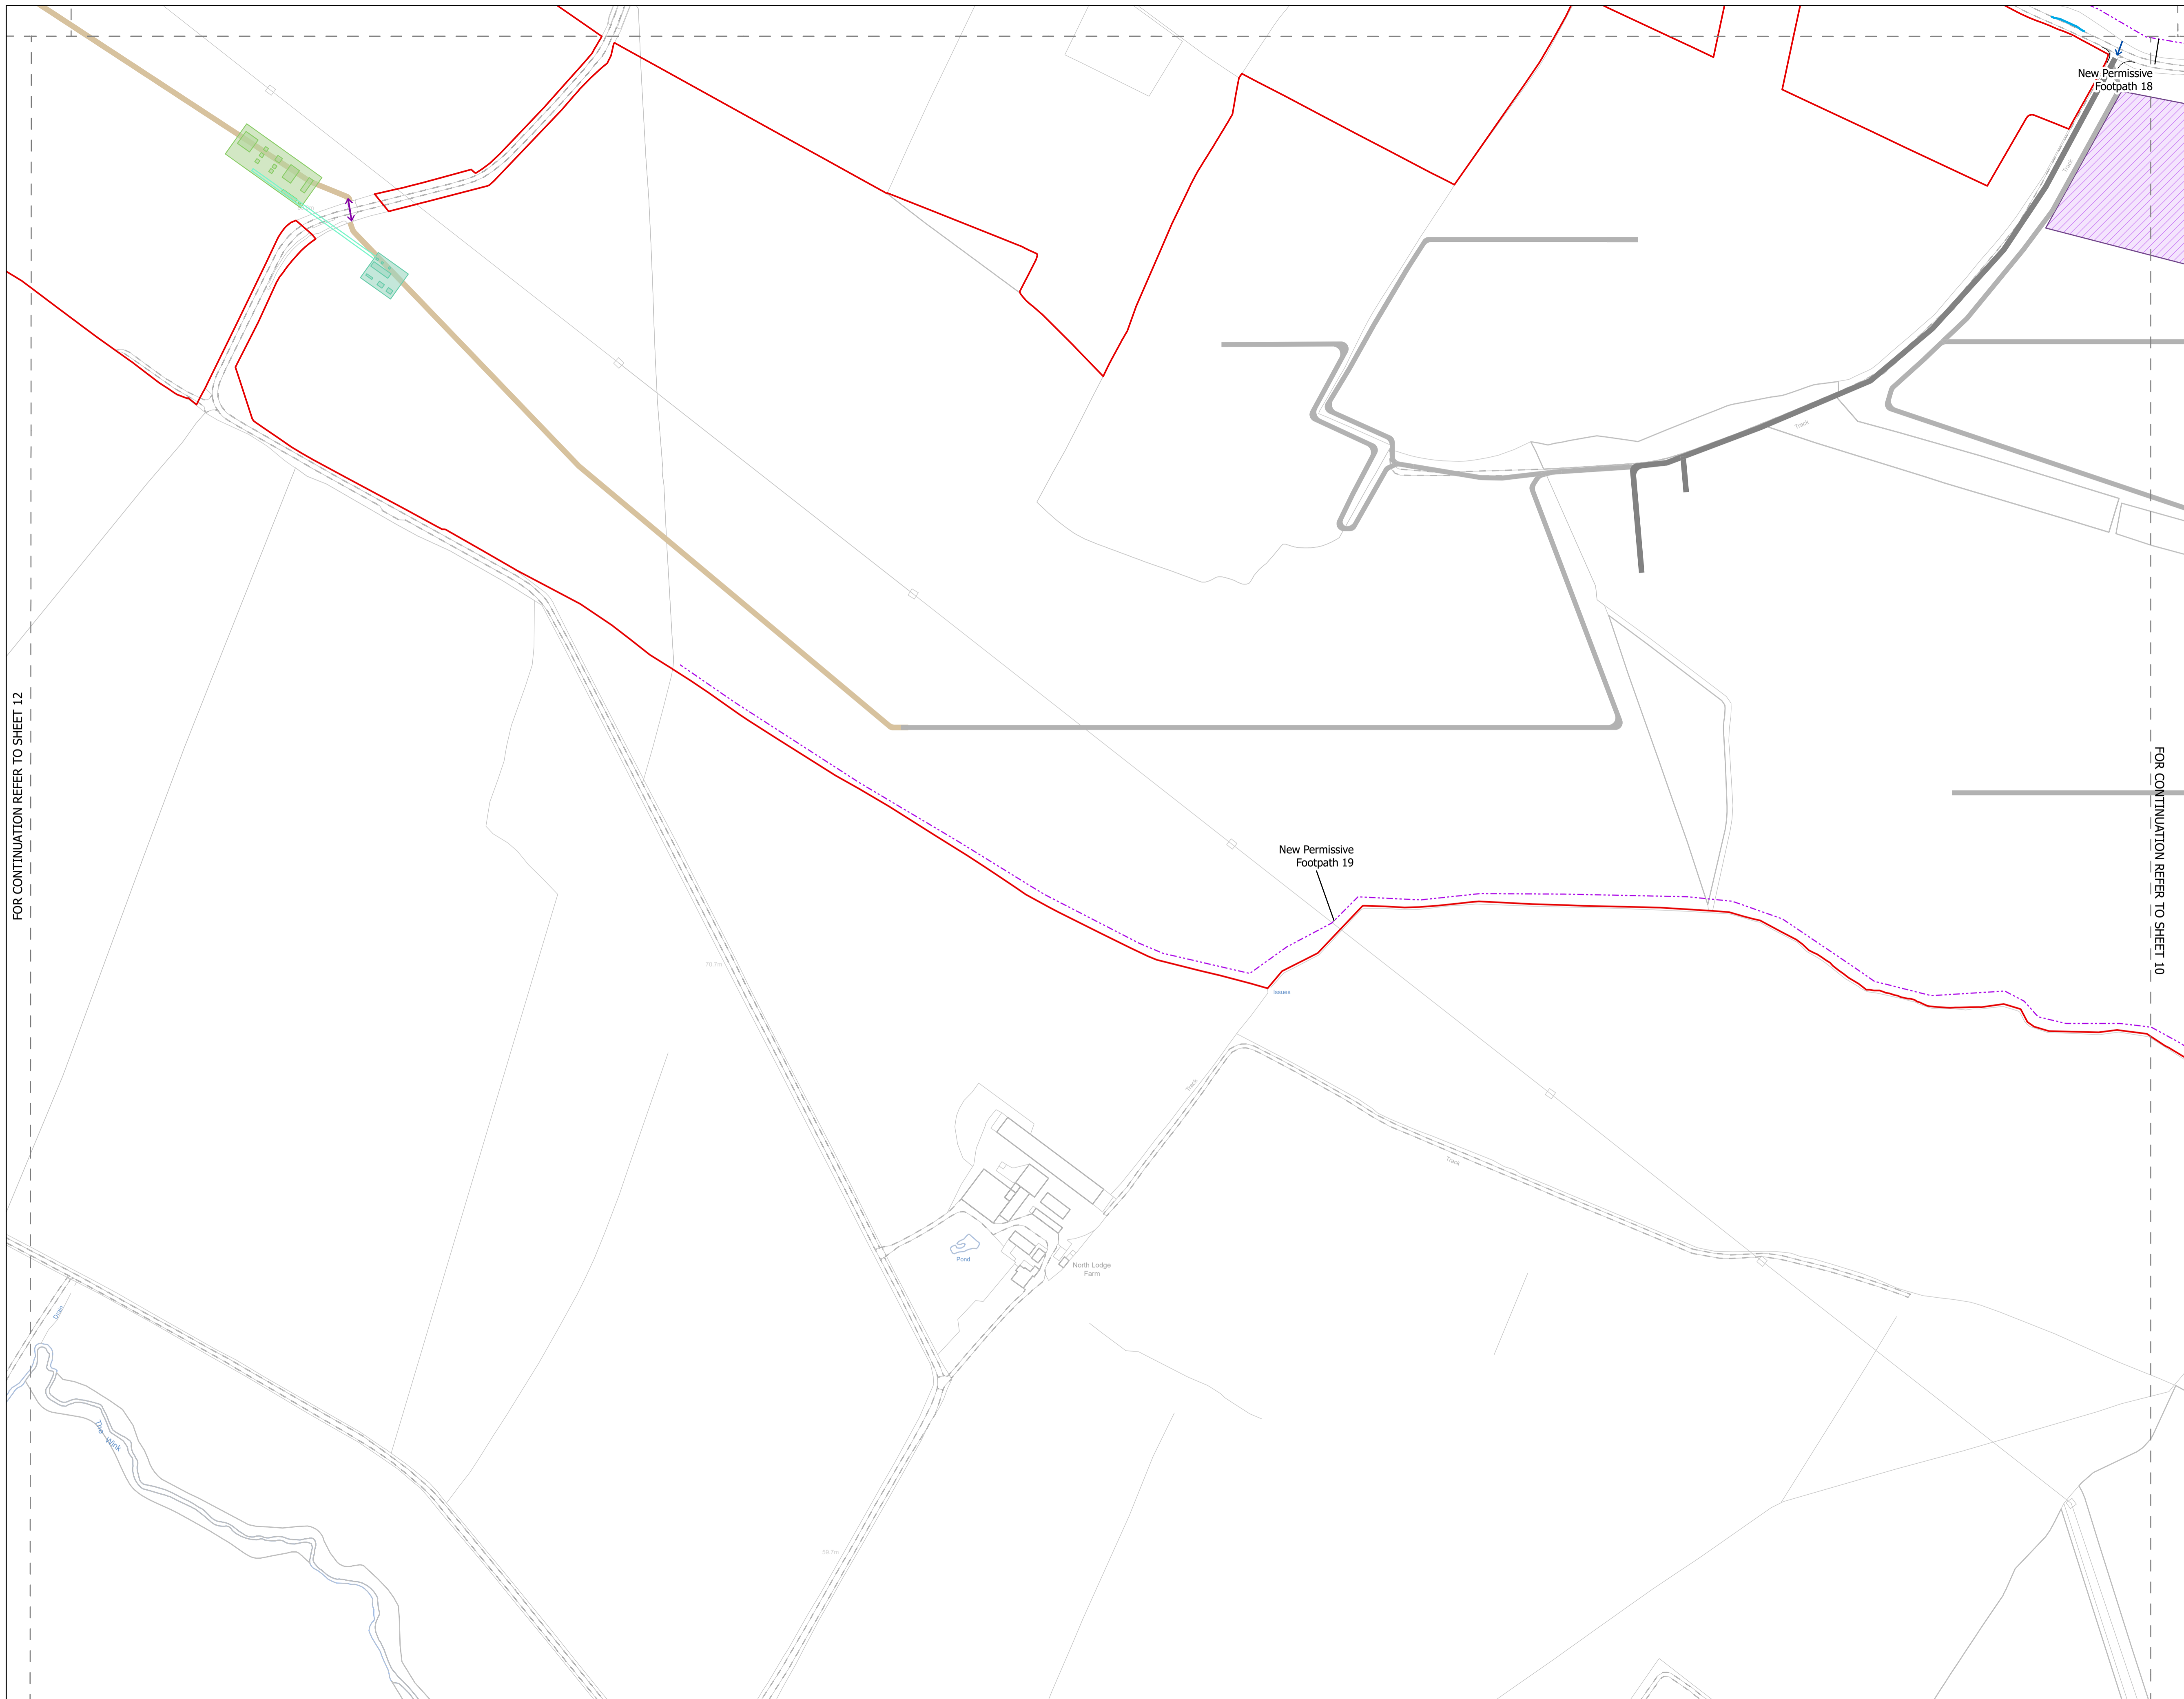

FOR CONTINUATION REFER TO SHEET 12


FOR CONTINUATION REFER TO SHEET 10

NOTES
1. ALL DIMENSIONS ARE IN METRES UNLESS STATED OTHERWISE.

Legend

- Order Limits
- ↑ Construction Only Access Point
- ↑ Maintenance and Construction Access Point
- ↑ Maintenance Access and Construction Cross Over Point
- Footpath Closure
- Footpath Diversion
- Bridleway Closed For Construction and Decommissioning
- New Permissive Footpath
- New Permissive Bridleway
- Bridleway Diversion for Construction and Decommissioning
- Access Bellmouth
- Passing Places
- HDD Connection Channel
- HDD Compound Pull-Back Rig
- HDD Compound Rig Side
- Internal Tarmac Roads
- Internal Stone Roads
- Temporary Construction Roads
- Main Compound Areas
- Satellite Compound Areas

The Legend is identical on all sheets of the Illustrative Construction Layout and therefore not all items specified in the Legend are found on each sheet

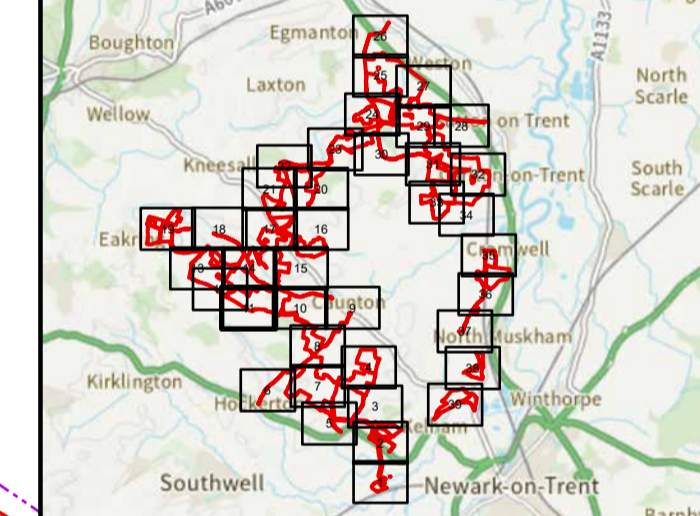

Revision	By	Check	Date	Suffix
Revision 3	AD	LA	14/04/2026	Rev03
Revision 2	AD	LA	14/01/2026	Rev02
Revision 1	AD	LA	24/06/2025	Rev01

Applicant: Elements Green Trent Limited



Project Title:
GREAT NORTH ROAD SOLAR AND BIODIVERSITY PARK

Purpose of Issue:
DCO APPLICATION

Development Consent Order Number:
EN010162

Development Consent Order Drawing Number:
EN010162/APP/6.3.5.5B

Drawing Title:
Illustrative Construction Layout SHEET 11 of 39

Designed:	Drawn:	Checked:	Date:
AD	AD	LA	14/04/2026


Internal Project Number:
026

Suitability:
DCO Application

Scale @ A1:
1:2,500

N	Rev: Rev03
---	---------------




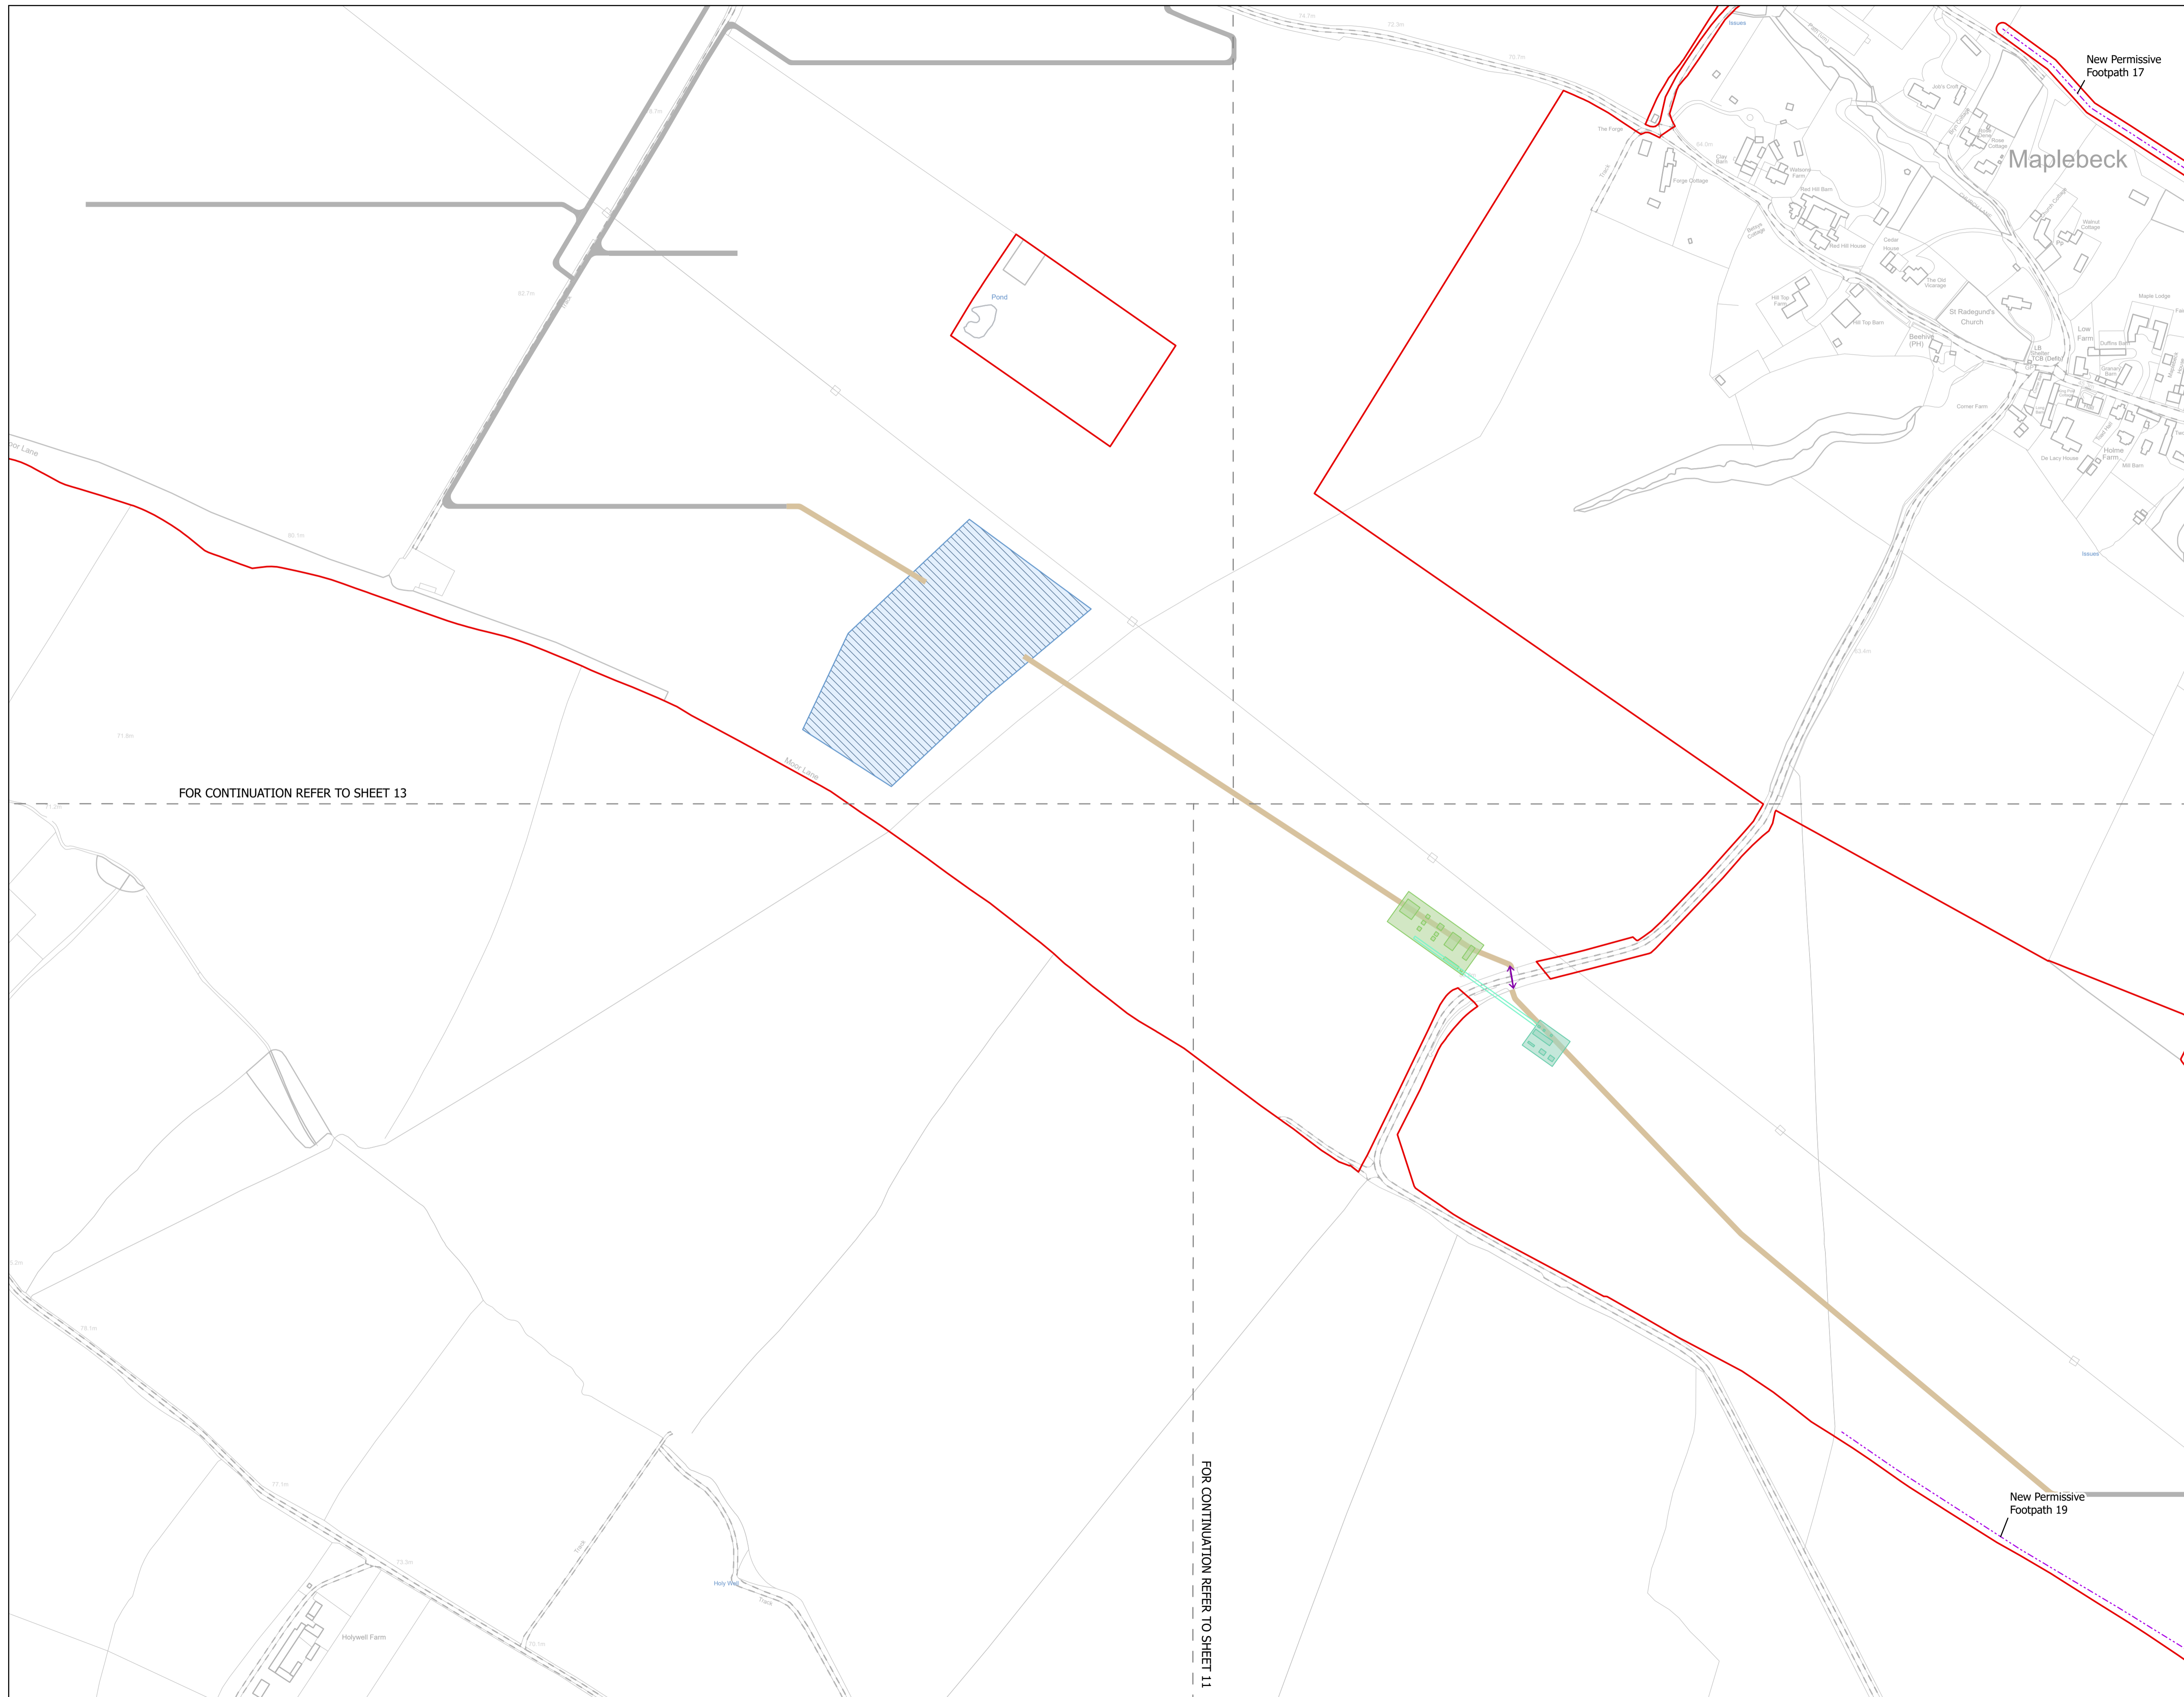

NOTES
1. ALL DIMENSIONS ARE IN METRES UNLESS STATED OTHERWISE.

- Legend**
- Order Limits
 - ↑ Construction Only Access Point
 - ↑ Maintenance and Construction Access Point
 - ↑ Maintenance Access and Construction Cross Over Point
 - Footpath Closure
 - Footpath Diversion
 - Bridleway Closed For Construction and Decommissioning
 - New Permissive Footpath
 - New Permissive Bridleway
 - Bridleway Diversion for Construction and Decommissioning
 - Access Bellmouth
 - Passing Places
 - HDD Connection Channel
 - HDD Compound Pull-Back Rig
 - HDD Compound Rig Side
 - Internal Tarmac Roads
 - Internal Stone Roads
 - Temporary Construction Roads
 - Main Compound Areas
 - Satellite Compound Areas

The Legend is identical on all sheets of the Illustrative Construction Layout and therefore not all items specified in the Legend are found on each sheet

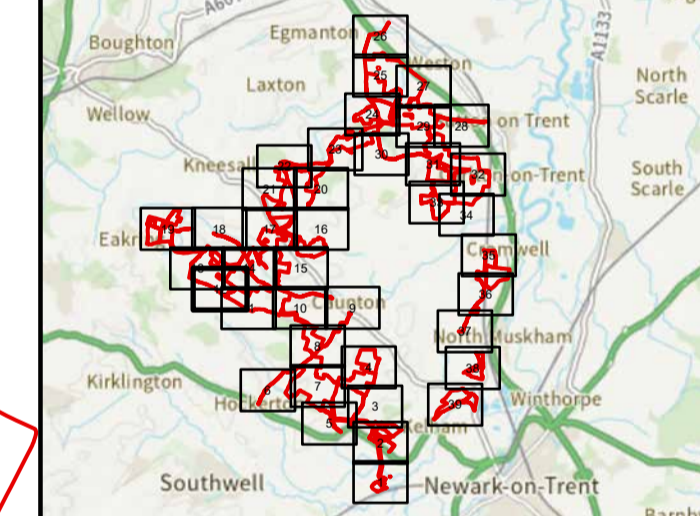

Revision 3	AD	LA	14/04/2026	Rev03
Revision 2	AD	LA	14/01/2026	Rev02
Revision 1	AD	LA	24/06/2025	Rev01
Revision Details	By	Check	Date	Suffix



Project Title:
GREAT NORTH ROAD SOLAR AND BIODIVERSITY PARK

Purpose of Issue:
DCO APPLICATION

Development Consent Order Number:
EN010162

Development Consent Order Drawing Number:
EN010162/APP/6.3.5.5B

Drawing Title:
Illustrative Construction Layout SHEET 12 of 39


Designed: AD	Drawn: AD	Checked: LA	Date: 14/04/2026
-----------------	--------------	----------------	---------------------

Internal Project Number:
026

Suitability:
DCO Application


Scale @ A1:
1:2,500

N	Rev: Rev03
---	---------------

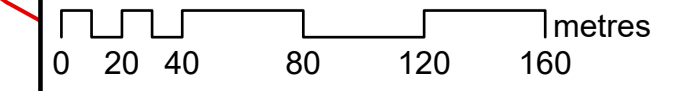

FOR CONTINUATION REFER TO SHEET 13

FOR CONTINUATION REFER TO SHEET 11

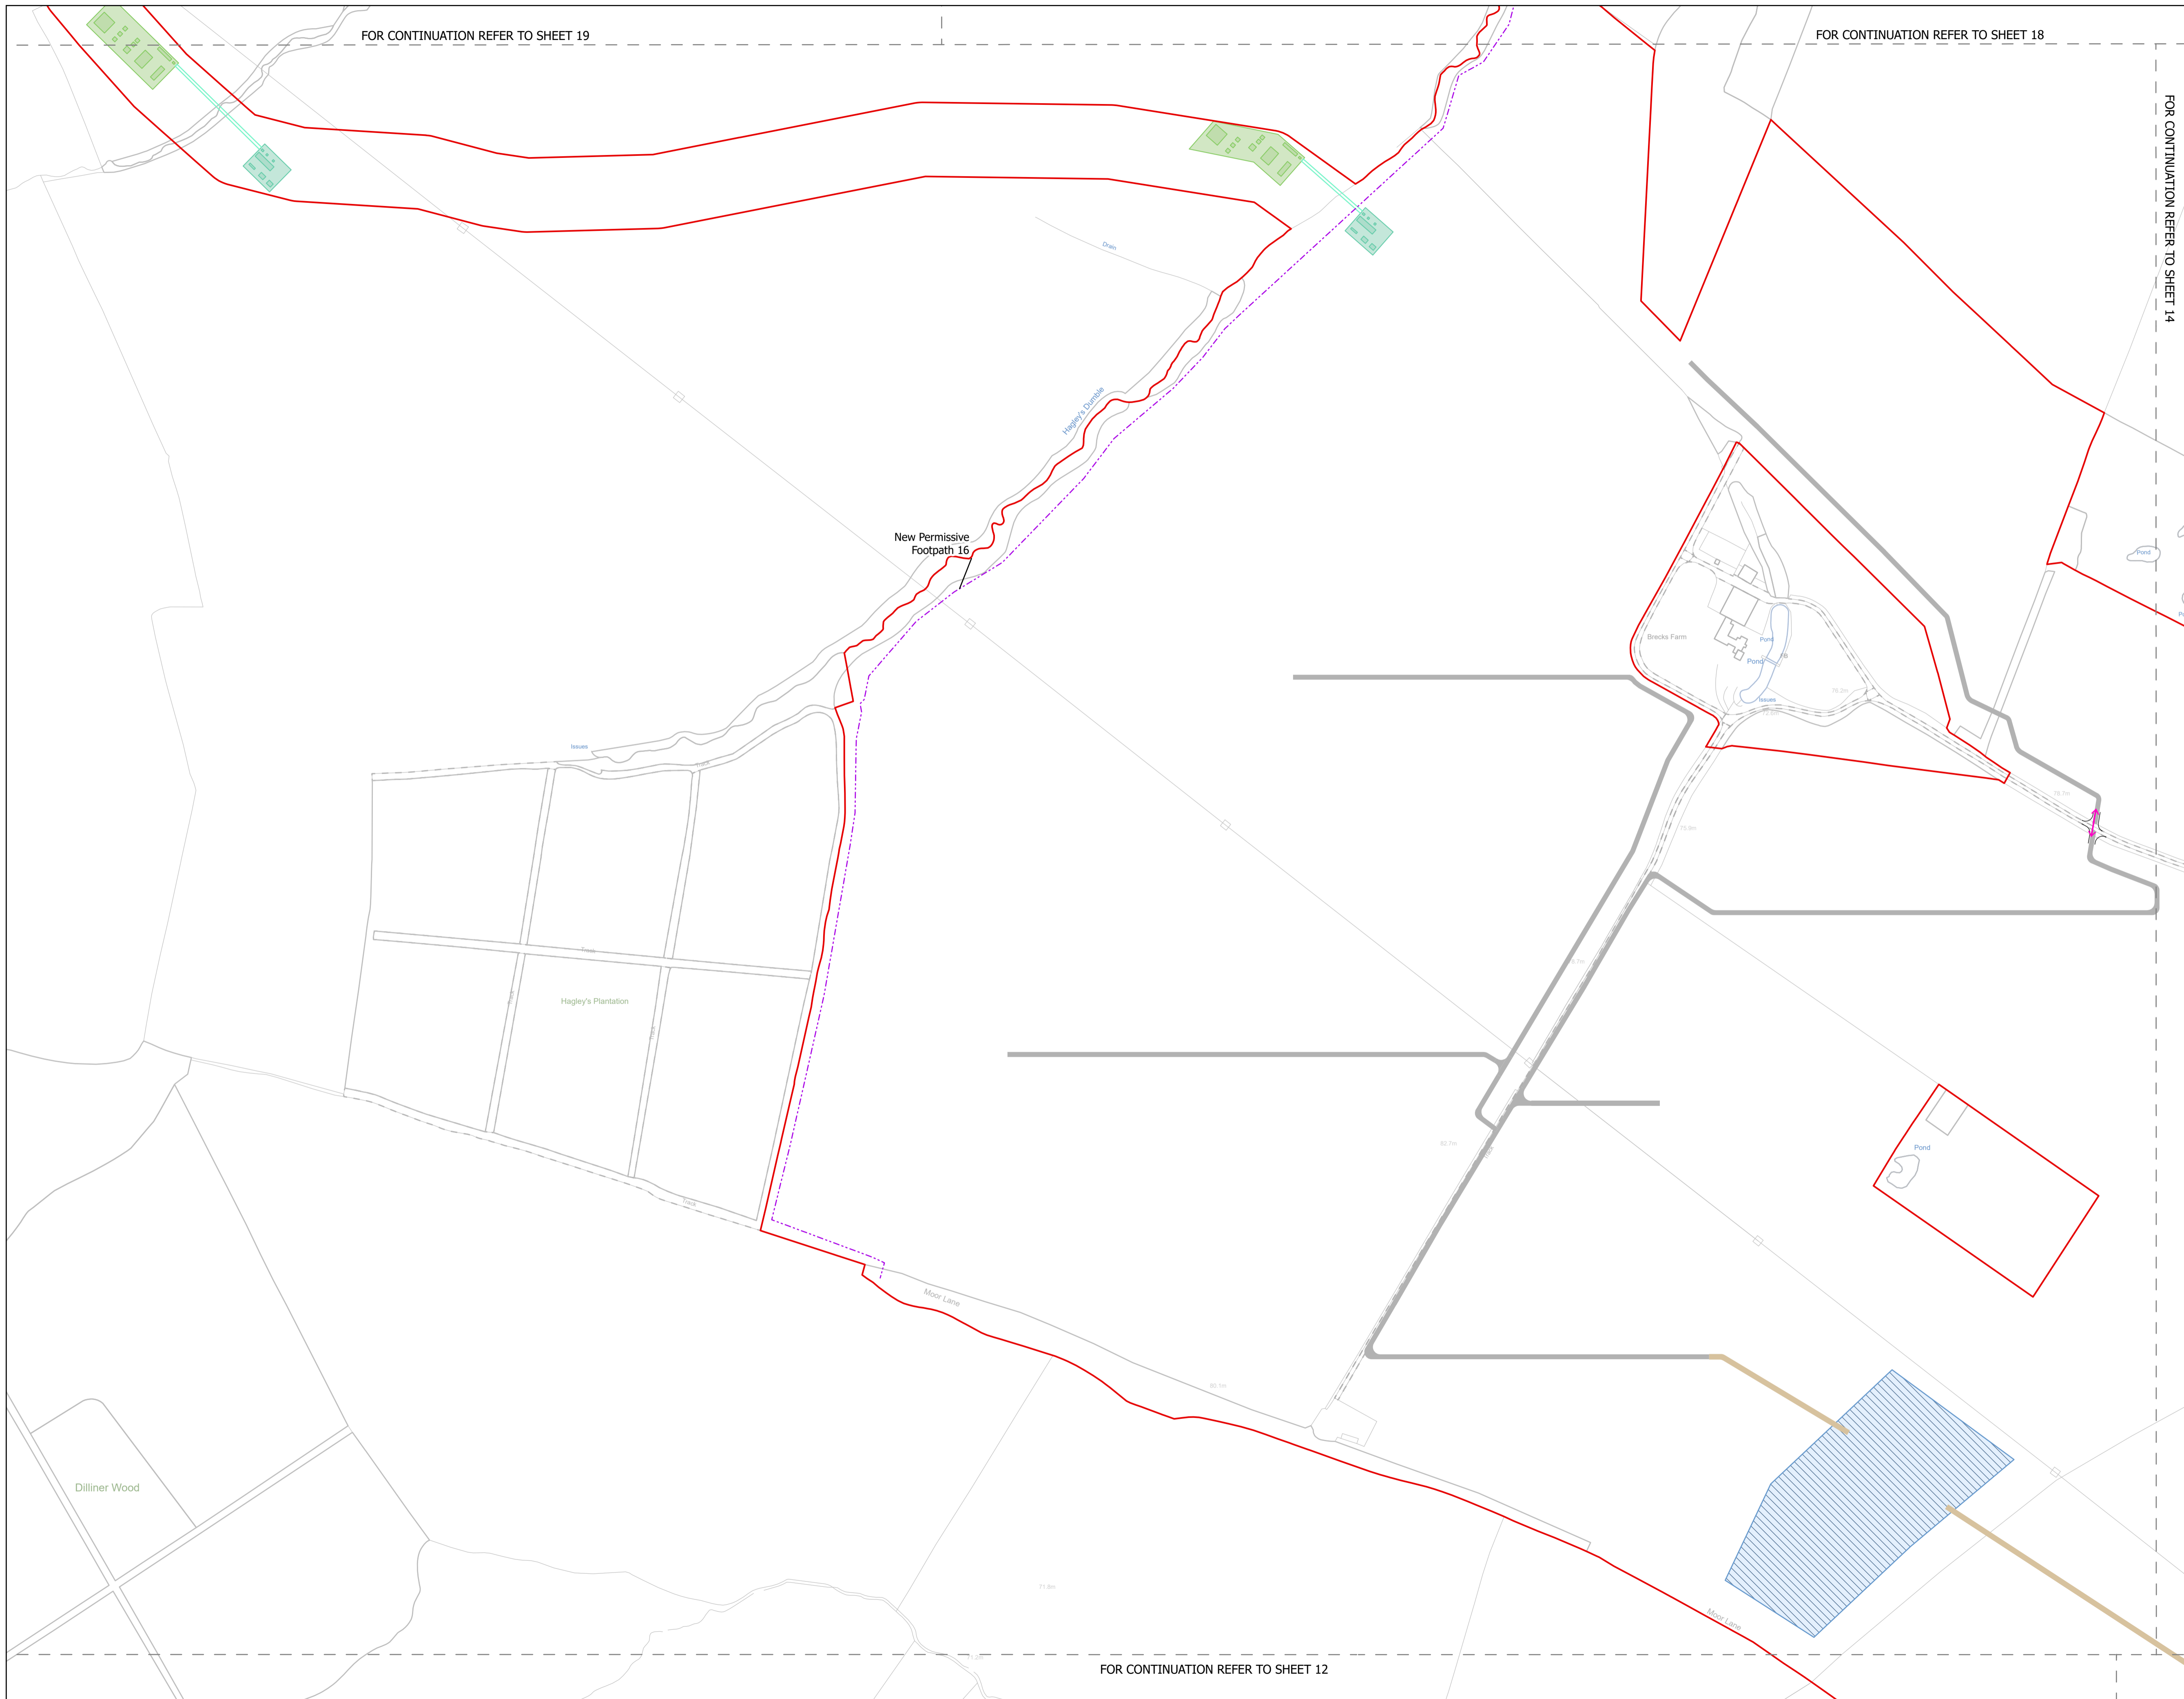

FOR CONTINUATION REFER TO SHEET 19


FOR CONTINUATION REFER TO SHEET 18

FOR CONTINUATION REFER TO SHEET 14

NOTES
1. ALL DIMENSIONS ARE IN METRES UNLESS STATED OTHERWISE.

- Legend**
- Order Limits
 - ↑ Construction Only Access Point
 - ↑ Maintenance and Construction Access Point
 - ↑ Maintenance Access and Construction Cross Over Point
 - Footpath Closure
 - Footpath Diversion
 - Bridleway Closed For Construction and Decommissioning
 - - - New Permissive Footpath
 - - - New Permissive Bridleway
 - Bridleway Diversion for Construction and Decommissioning
 - Access Bellmouth
 - Passing Places
 - HDD Connection Channel
 - HDD Compound Pull-Back Rig
 - HDD Compound Rig Side
 - Internal Tarmac Roads
 - Internal Stone Roads
 - Temporary Construction Roads
 - Main Compound Areas
 - Satellite Compound Areas

The Legend is identical on all sheets of the Illustrative Construction Layout and therefore not all items specified in the Legend are found on each sheet

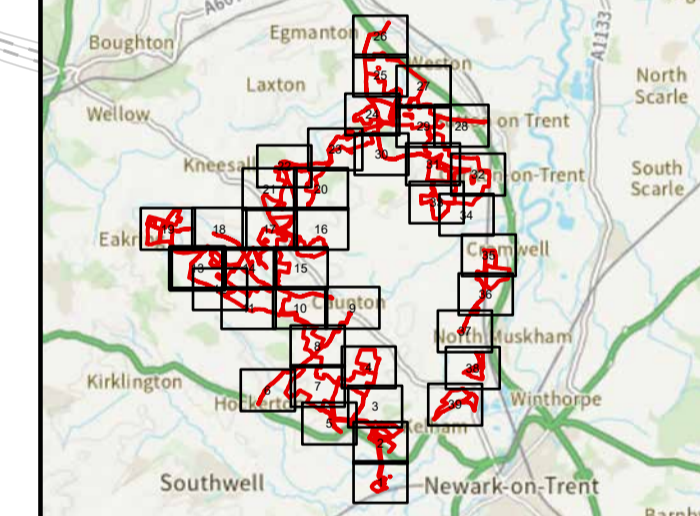

Revision 3	AD	LA	14/04/2026	Rev03
Revision 2	AD	LA	14/01/2026	Rev02
Revision 1	AD	LA	24/06/2025	Rev01
Revision Details	By	Check	Date	Suffix



Project Title:
GREAT NORTH ROAD SOLAR AND BIODIVERSITY PARK

Purpose of Issue:
DCO APPLICATION

Development Consent Order Number:
EN010162


Development Consent Order Drawing Number:
EN010162/APP/6.3.5.5B

Drawing Title:
Illustrative Construction Layout SHEET 13 of 39

Designed: AD	Drawn: AD	Checked: LA	Date: 14/04/2026
Internal Project Number: 026		Suitability: DCO Application	

Scale @ A1:
1:2,500

N	Rev: Rev03
---	---------------

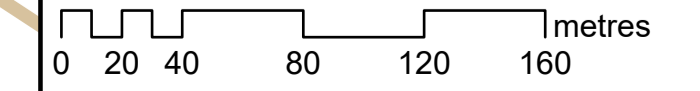

FOR CONTINUATION REFER TO SHEET 12

FOR CONTINUATION REFER TO SHEET 18


FOR CONTINUATION REFER TO SHEET 17

NOTES
1. ALL DIMENSIONS ARE IN METRES UNLESS STATED OTHERWISE.

Legend

- Order Limits
- ↑ Construction Only Access Point
- ↑ Maintenance and Construction Access Point
- ↑ Maintenance Access and Construction Cross Over Point
- Footpath Closure
- Footpath Diversion
- Bridleway Closed For Construction and Decommissioning
- New Permissive Footpath
- New Permissive Bridleway
- Bridleway Diversion For Construction and Decommissioning
- Access Bellmouth
- Passing Places
- HDD Connection Channel
- HDD Compound Pull-Back Rig
- HDD Compound Rig Side
- Internal Tarmac Roads
- Internal Stone Roads
- Temporary Construction Roads
- Main Compound Areas
- Satellite Compound Areas

The Legend is identical on all sheets of the Illustrative Construction Layout and therefore not all items specified in the Legend are found on each sheet

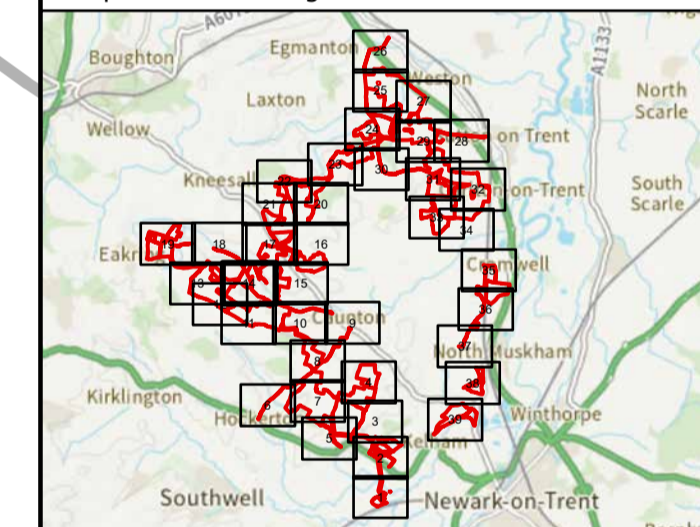

Revision 3	AD	LA	14/04/2026	Rev03
Revision 2	AD	LA	14/01/2026	Rev02
Revision 1	AD	LA	24/06/2025	Rev01
Revision Details	By	Check	Date	Suffix

Applicant: Elements Green Trent Limited

Project Title:
GREAT NORTH ROAD SOLAR AND BIODIVERSITY PARK

Purpose of Issue:
DCO APPLICATION

Development Consent Order Number:
EN010162


Development Consent Order Drawing Number:
EN010162/APP/6.3.5.5B

Drawing Title:
Illustrative Construction Layout SHEET 14 of 39

Designed: AD	Drawn: AD	Checked: LA	Date: 14/04/2026
Internal Project Number: 026	Suitability: DCO Application		

Scale @ A1:
1:2,500


North arrow pointing up. Revision: **Rev03**

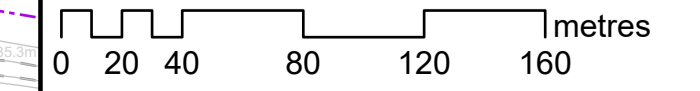


FOR CONTINUATION REFER TO SHEET 13

FOR CONTINUATION REFER TO SHEET 15

FOR CONTINUATION REFER TO SHEET 12

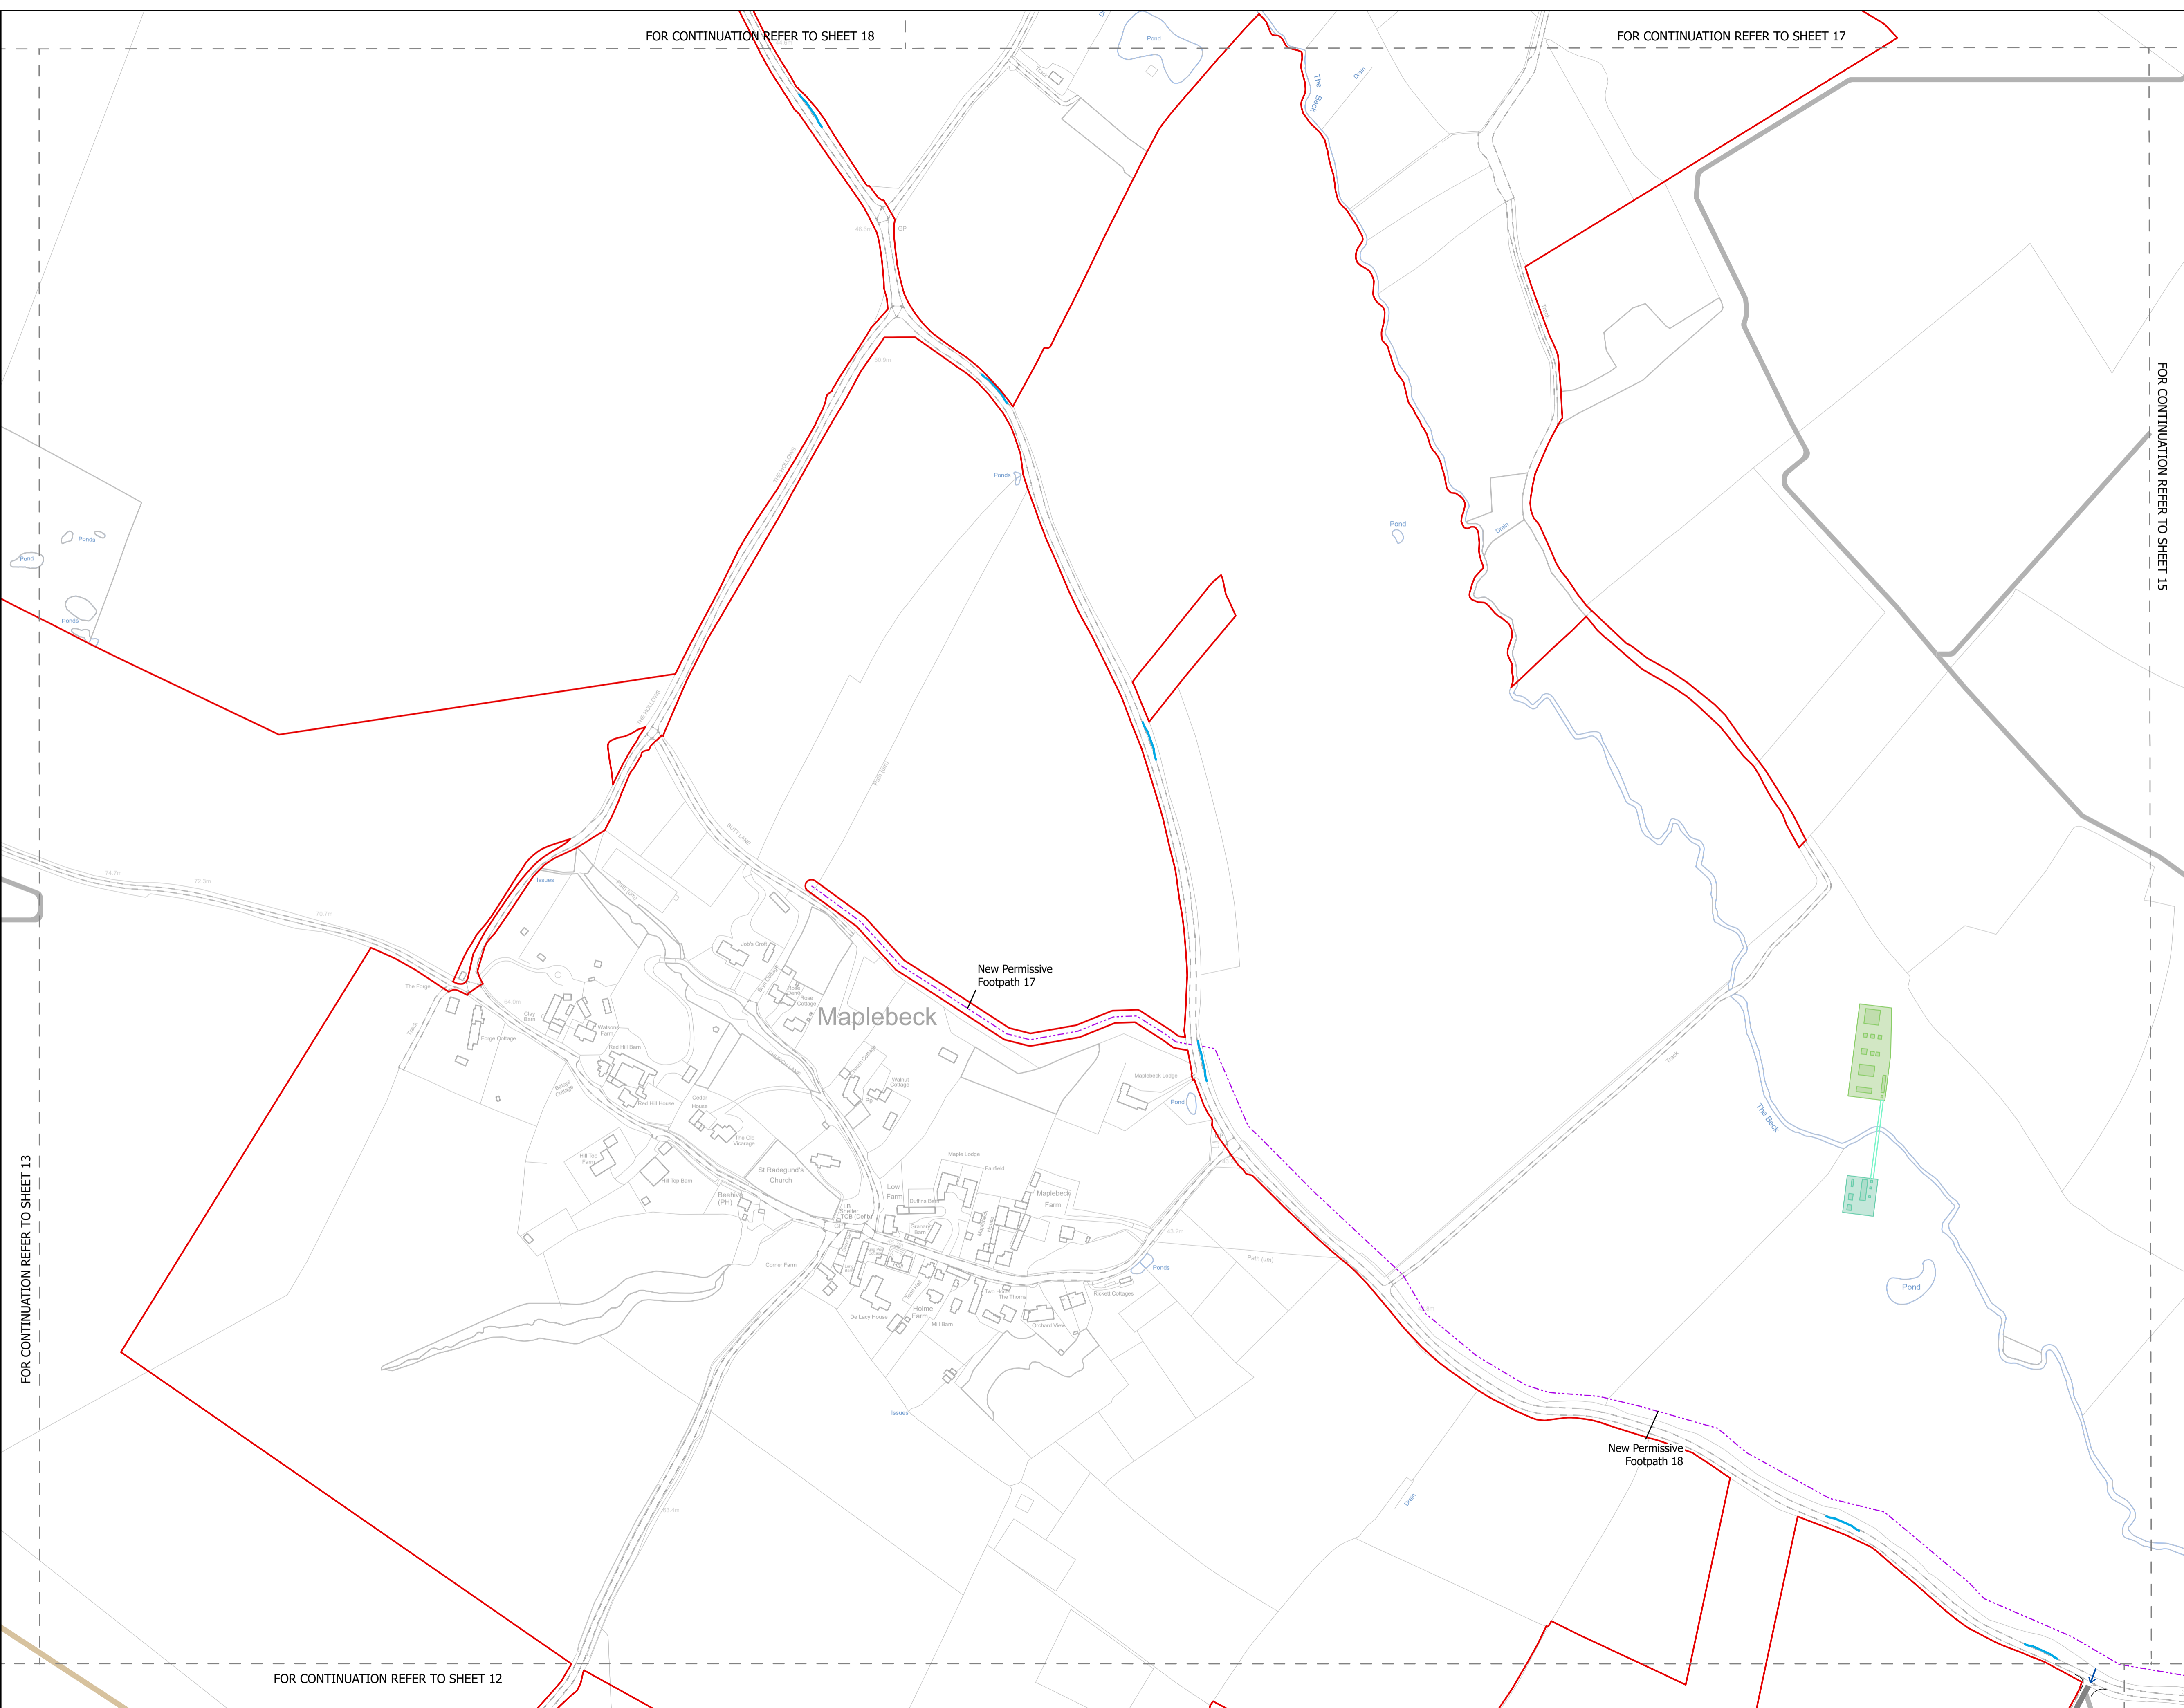

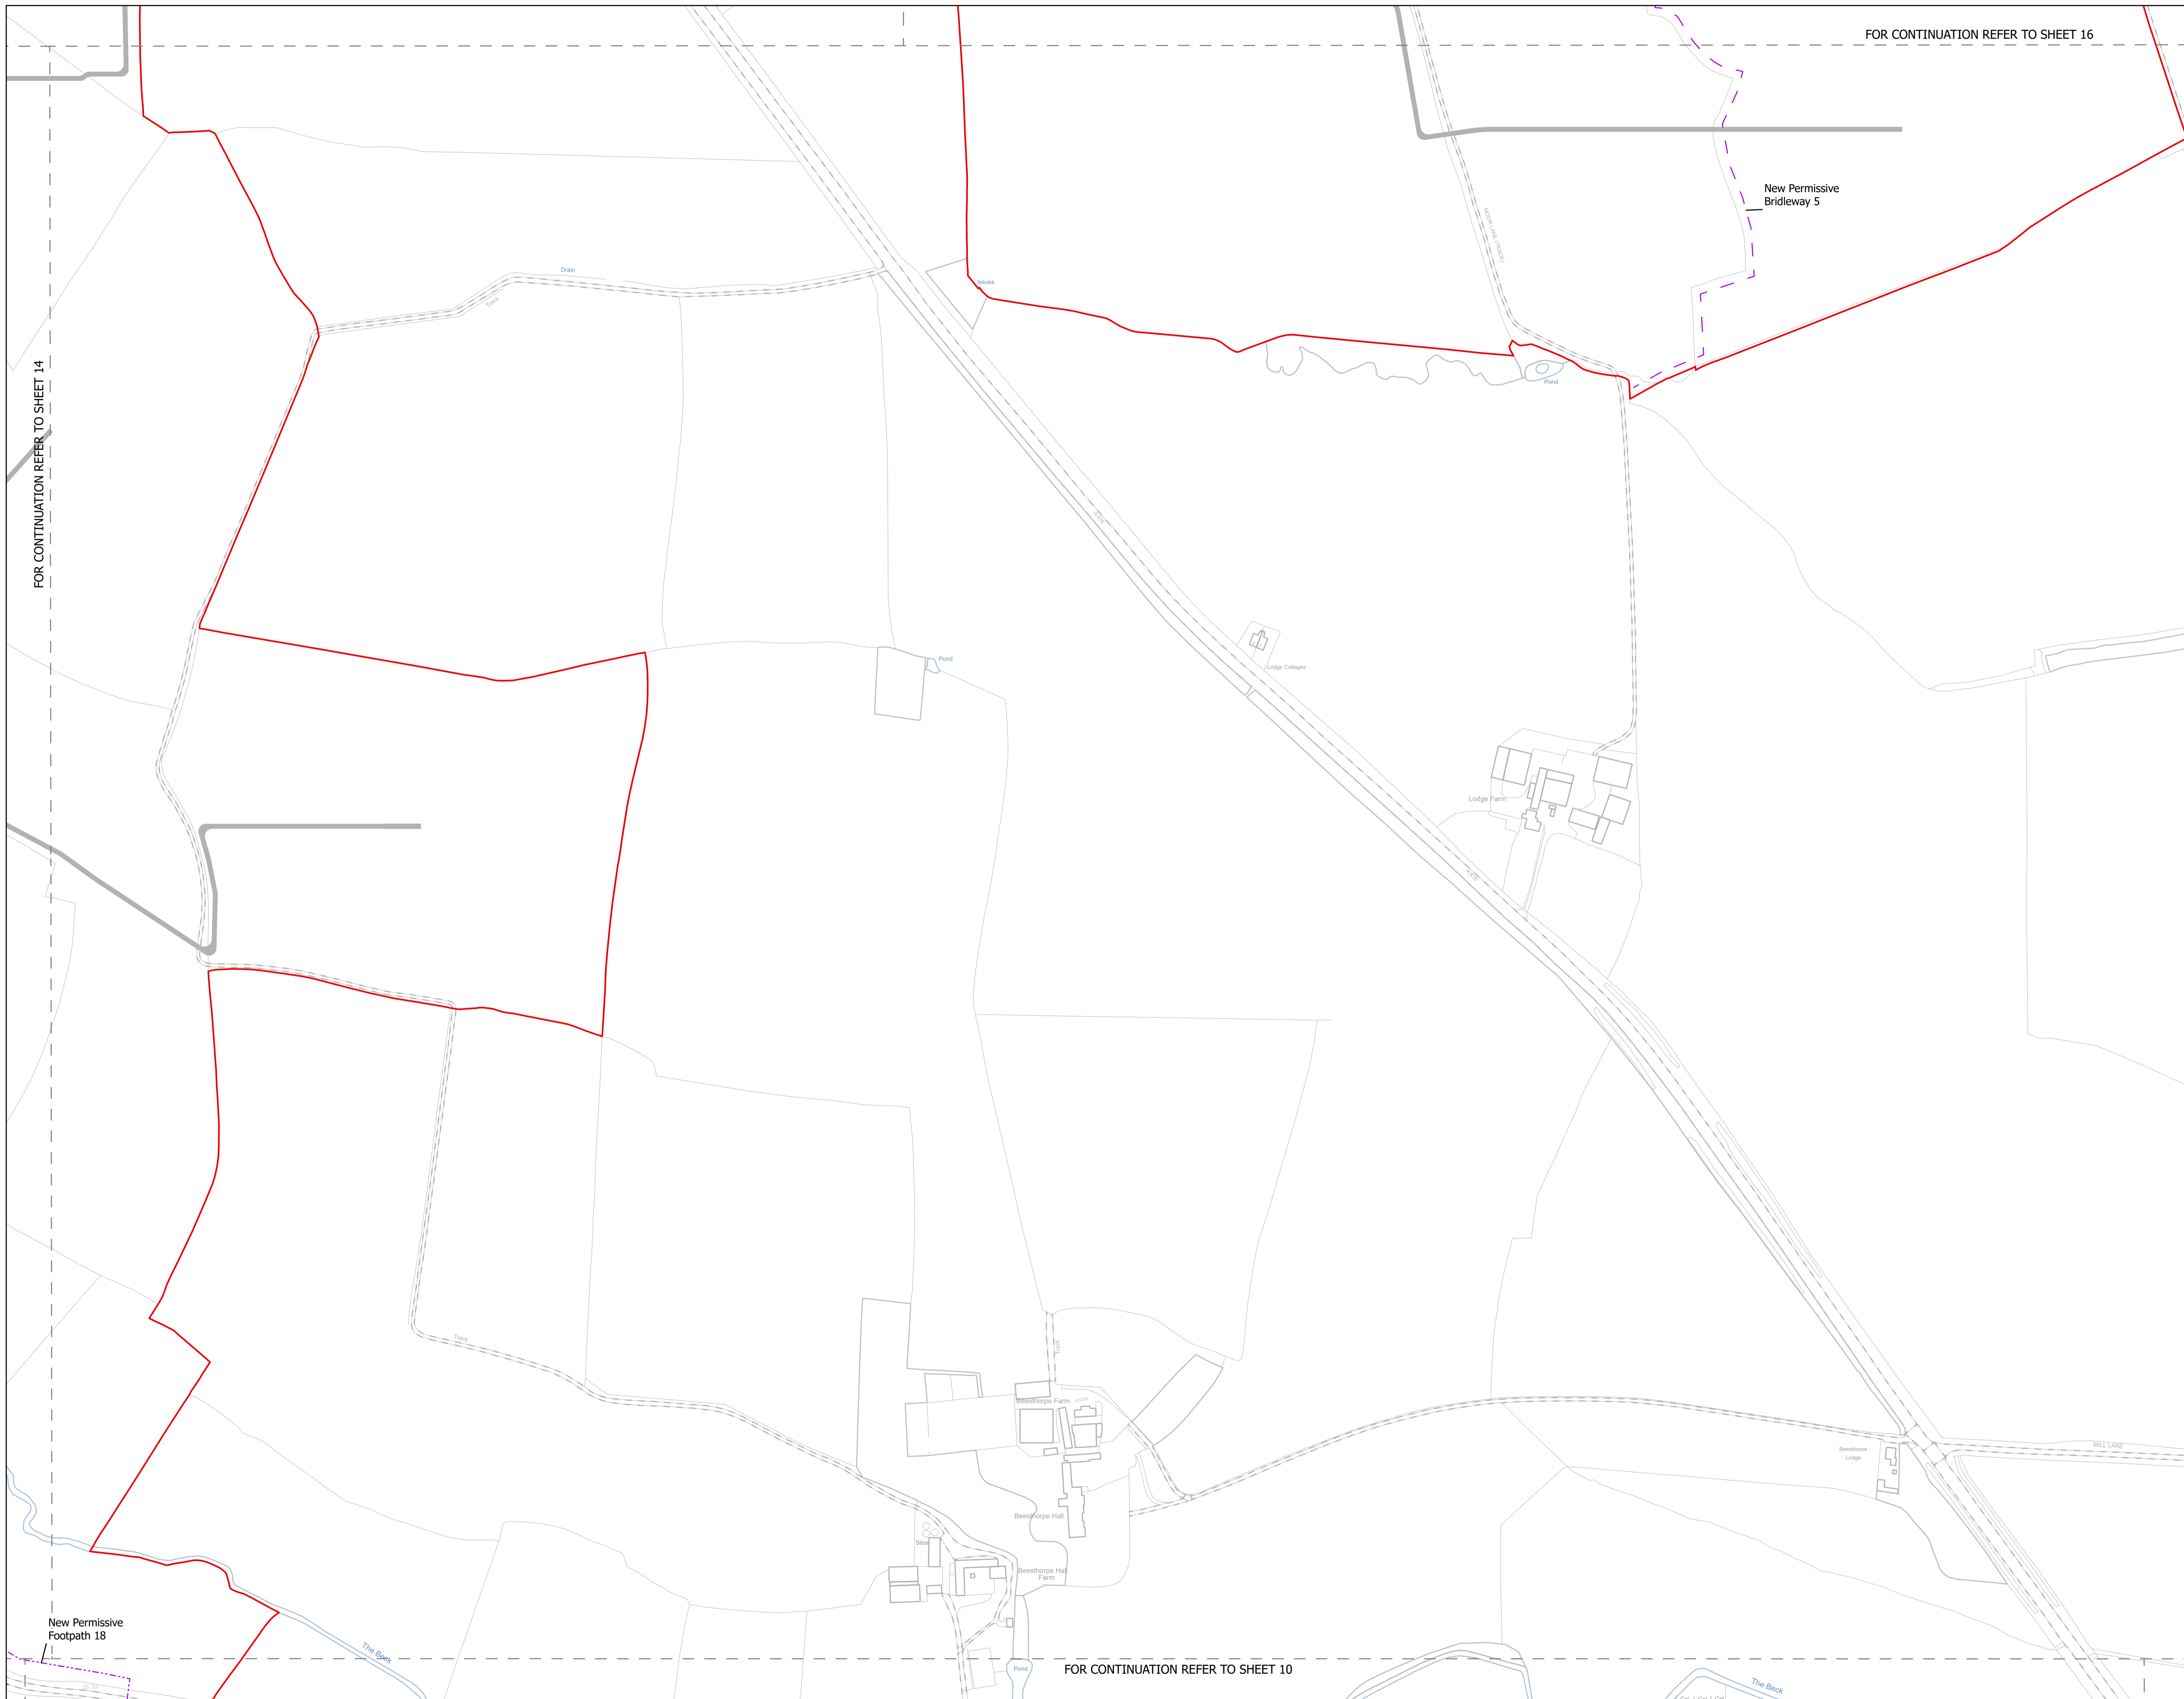

FOR CONTINUATION REFER TO SHEET 16


FOR CONTINUATION REFER TO SHEET 14

FOR CONTINUATION REFER TO SHEET 10

NOTES
1. ALL DIMENSIONS ARE IN METRES UNLESS STATED OTHERWISE.

- Legend**
- Order Limits
 - ↑ Construction Only Access Point
 - ↑ Maintenance and Construction Access Point
 - ↑ Maintenance Access and Construction Cross Over Point
 - Footpath Closure
 - Footpath Diversion
 - - Bridleway Closed For Construction and Decommissioning
 - - - New Permissive Footpath
 - - - New Permissive Bridleway
 - Bridleway Diversion for Construction and Decommissioning
 - Access Bellmouth
 - Passing Places
 - HDD Connection Channel
 - HDD Compound Pull-Back Rig
 - HDD Compound Rig Side
 - Internal Tarmac Roads
 - Internal Stone Roads
 - Temporary Construction Roads
 - Main Compound Areas
 - Satellite Compound Areas

The Legend is identical on all sheets of the Illustrative Construction Layout and therefore not all items specified in the Legend are found on each sheet

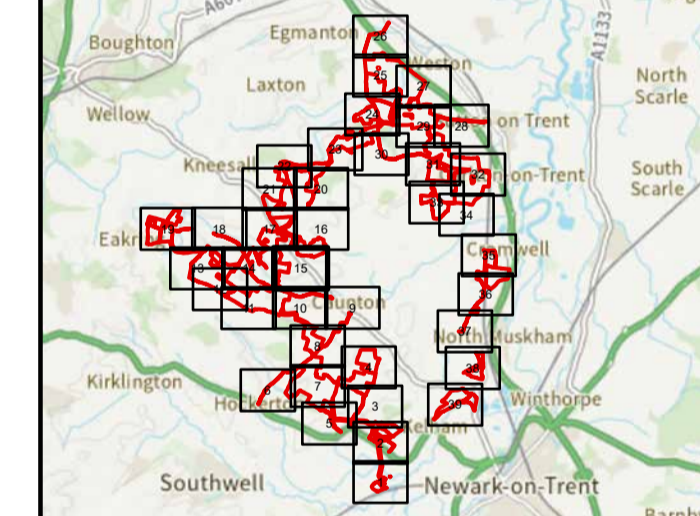

Revision 3	AD	LA	14/04/2026	Rev03
Revision 2	AD	LA	14/01/2026	Rev02
Revision 1	AD	LA	24/06/2025	Rev01
Revision Details	By	Check	Date	Suffix

Applicant: Elements Green Trent Limited

Solar & Biodiversity Park

Project Title:
GREAT NORTH ROAD SOLAR AND BIODIVERSITY PARK

Purpose of Issue:
DCO APPLICATION

Development Consent Order Number:
EN010162

Development Consent Order Drawing Number:
EN010162/APP/6.3.5.5B


Drawing Title:
Illustrative Construction Layout SHEET 15 of 39


Designed: AD	Drawn: AD	Checked: LA	Date: 14/04/2026
Internal Project Number: 026		Suitability: DCO Application	

Scale @ A1:
1:2,500

N

Rev:
Rev03

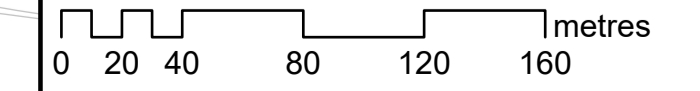


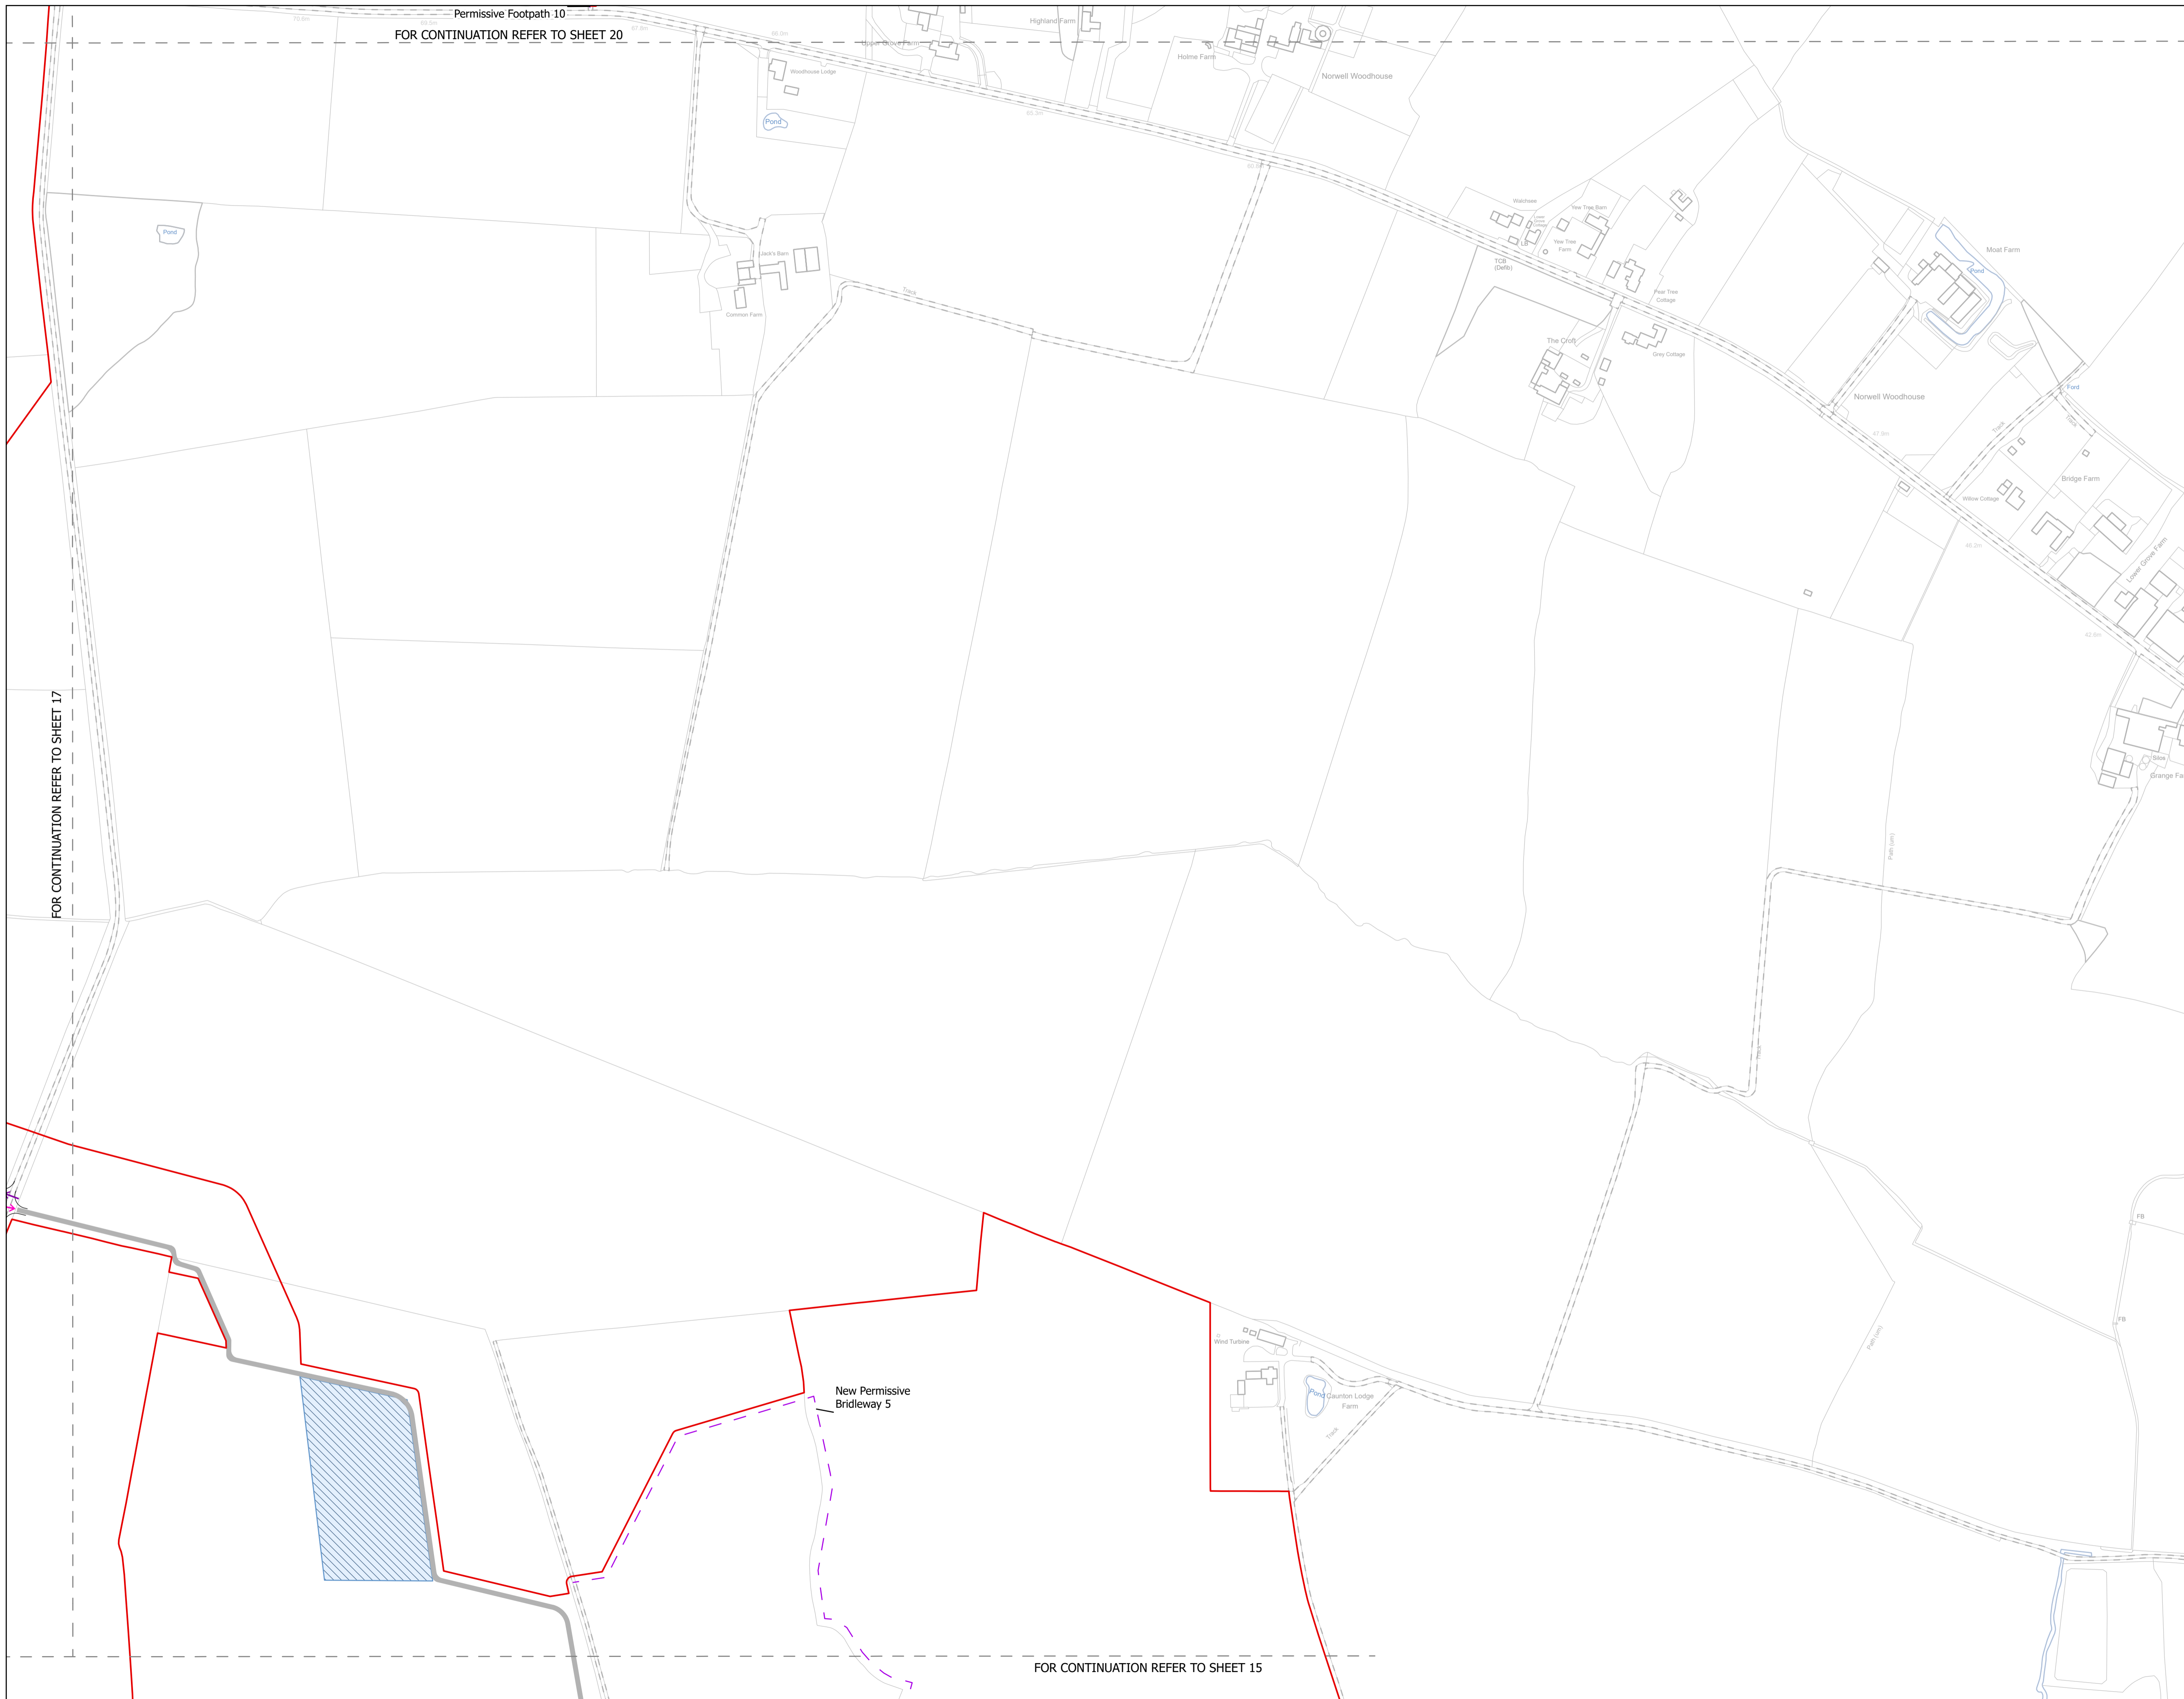

NOTES
1. ALL DIMENSIONS ARE IN METRES UNLESS STATED OTHERWISE.

- Legend**
- Order Limits
 - ↑ Construction Only Access Point
 - ↑ Maintenance and Construction Access Point
 - ↑ Maintenance Access and Construction Cross Over Point
 - Footpath Closure
 - Footpath Diversion
 - Bridleway Closed For Construction and Decommissioning
 - New Permissive Footpath
 - New Permissive Bridleway
 - Bridleway Diversion for Construction and Decommissioning
 - Access Bellmouth
 - Passing Places
 - HDD Connection Channel
 - HDD Compound Pull-Back Rig
 - HDD Compound Rig Side
 - Internal Tarmac Roads
 - Internal Stone Roads
 - Temporary Construction Roads
 - Main Compound Areas
 - Satellite Compound Areas

The Legend is identical on all sheets of the Illustrative Construction Layout and therefore not all items specified in the Legend are found on each sheet

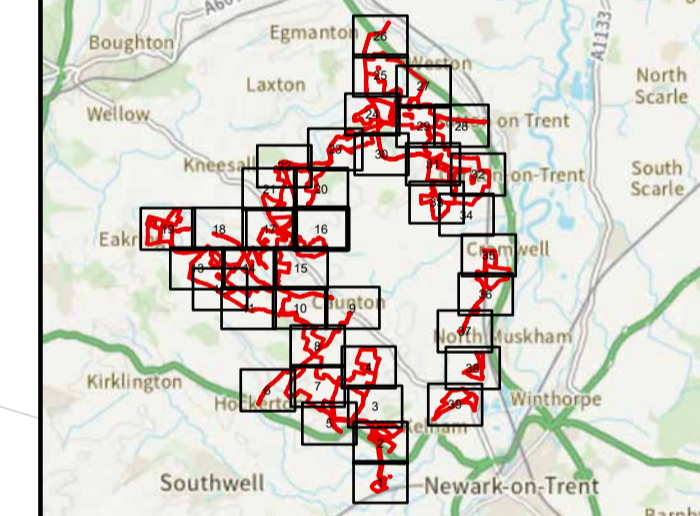

Revision 3	AD	LA	14/04/2026	Rev03
Revision 2	AD	LA	14/01/2026	Rev02
Revision 1	AD	LA	24/06/2025	Rev01
Revision Details	By	Check	Date	Suffix



Project Title:
GREAT NORTH ROAD SOLAR AND BIODIVERSITY PARK

Purpose of Issue:
DCO APPLICATION

Development Consent Order Number:
EN010162


Development Consent Order Drawing Number:
EN010162/APP/6.3.5.5B


Drawing Title:
Illustrative Construction Layout SHEET 16 of 39

Designed: AD	Drawn: AD	Checked: LA	Date: 14/04/2026
Internal Project Number: 026		Suitability: DCO Application	

Scale @ A1:
1:2,500

N	Rev: Rev03
---	---------------

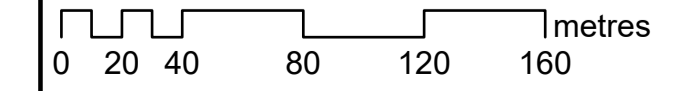


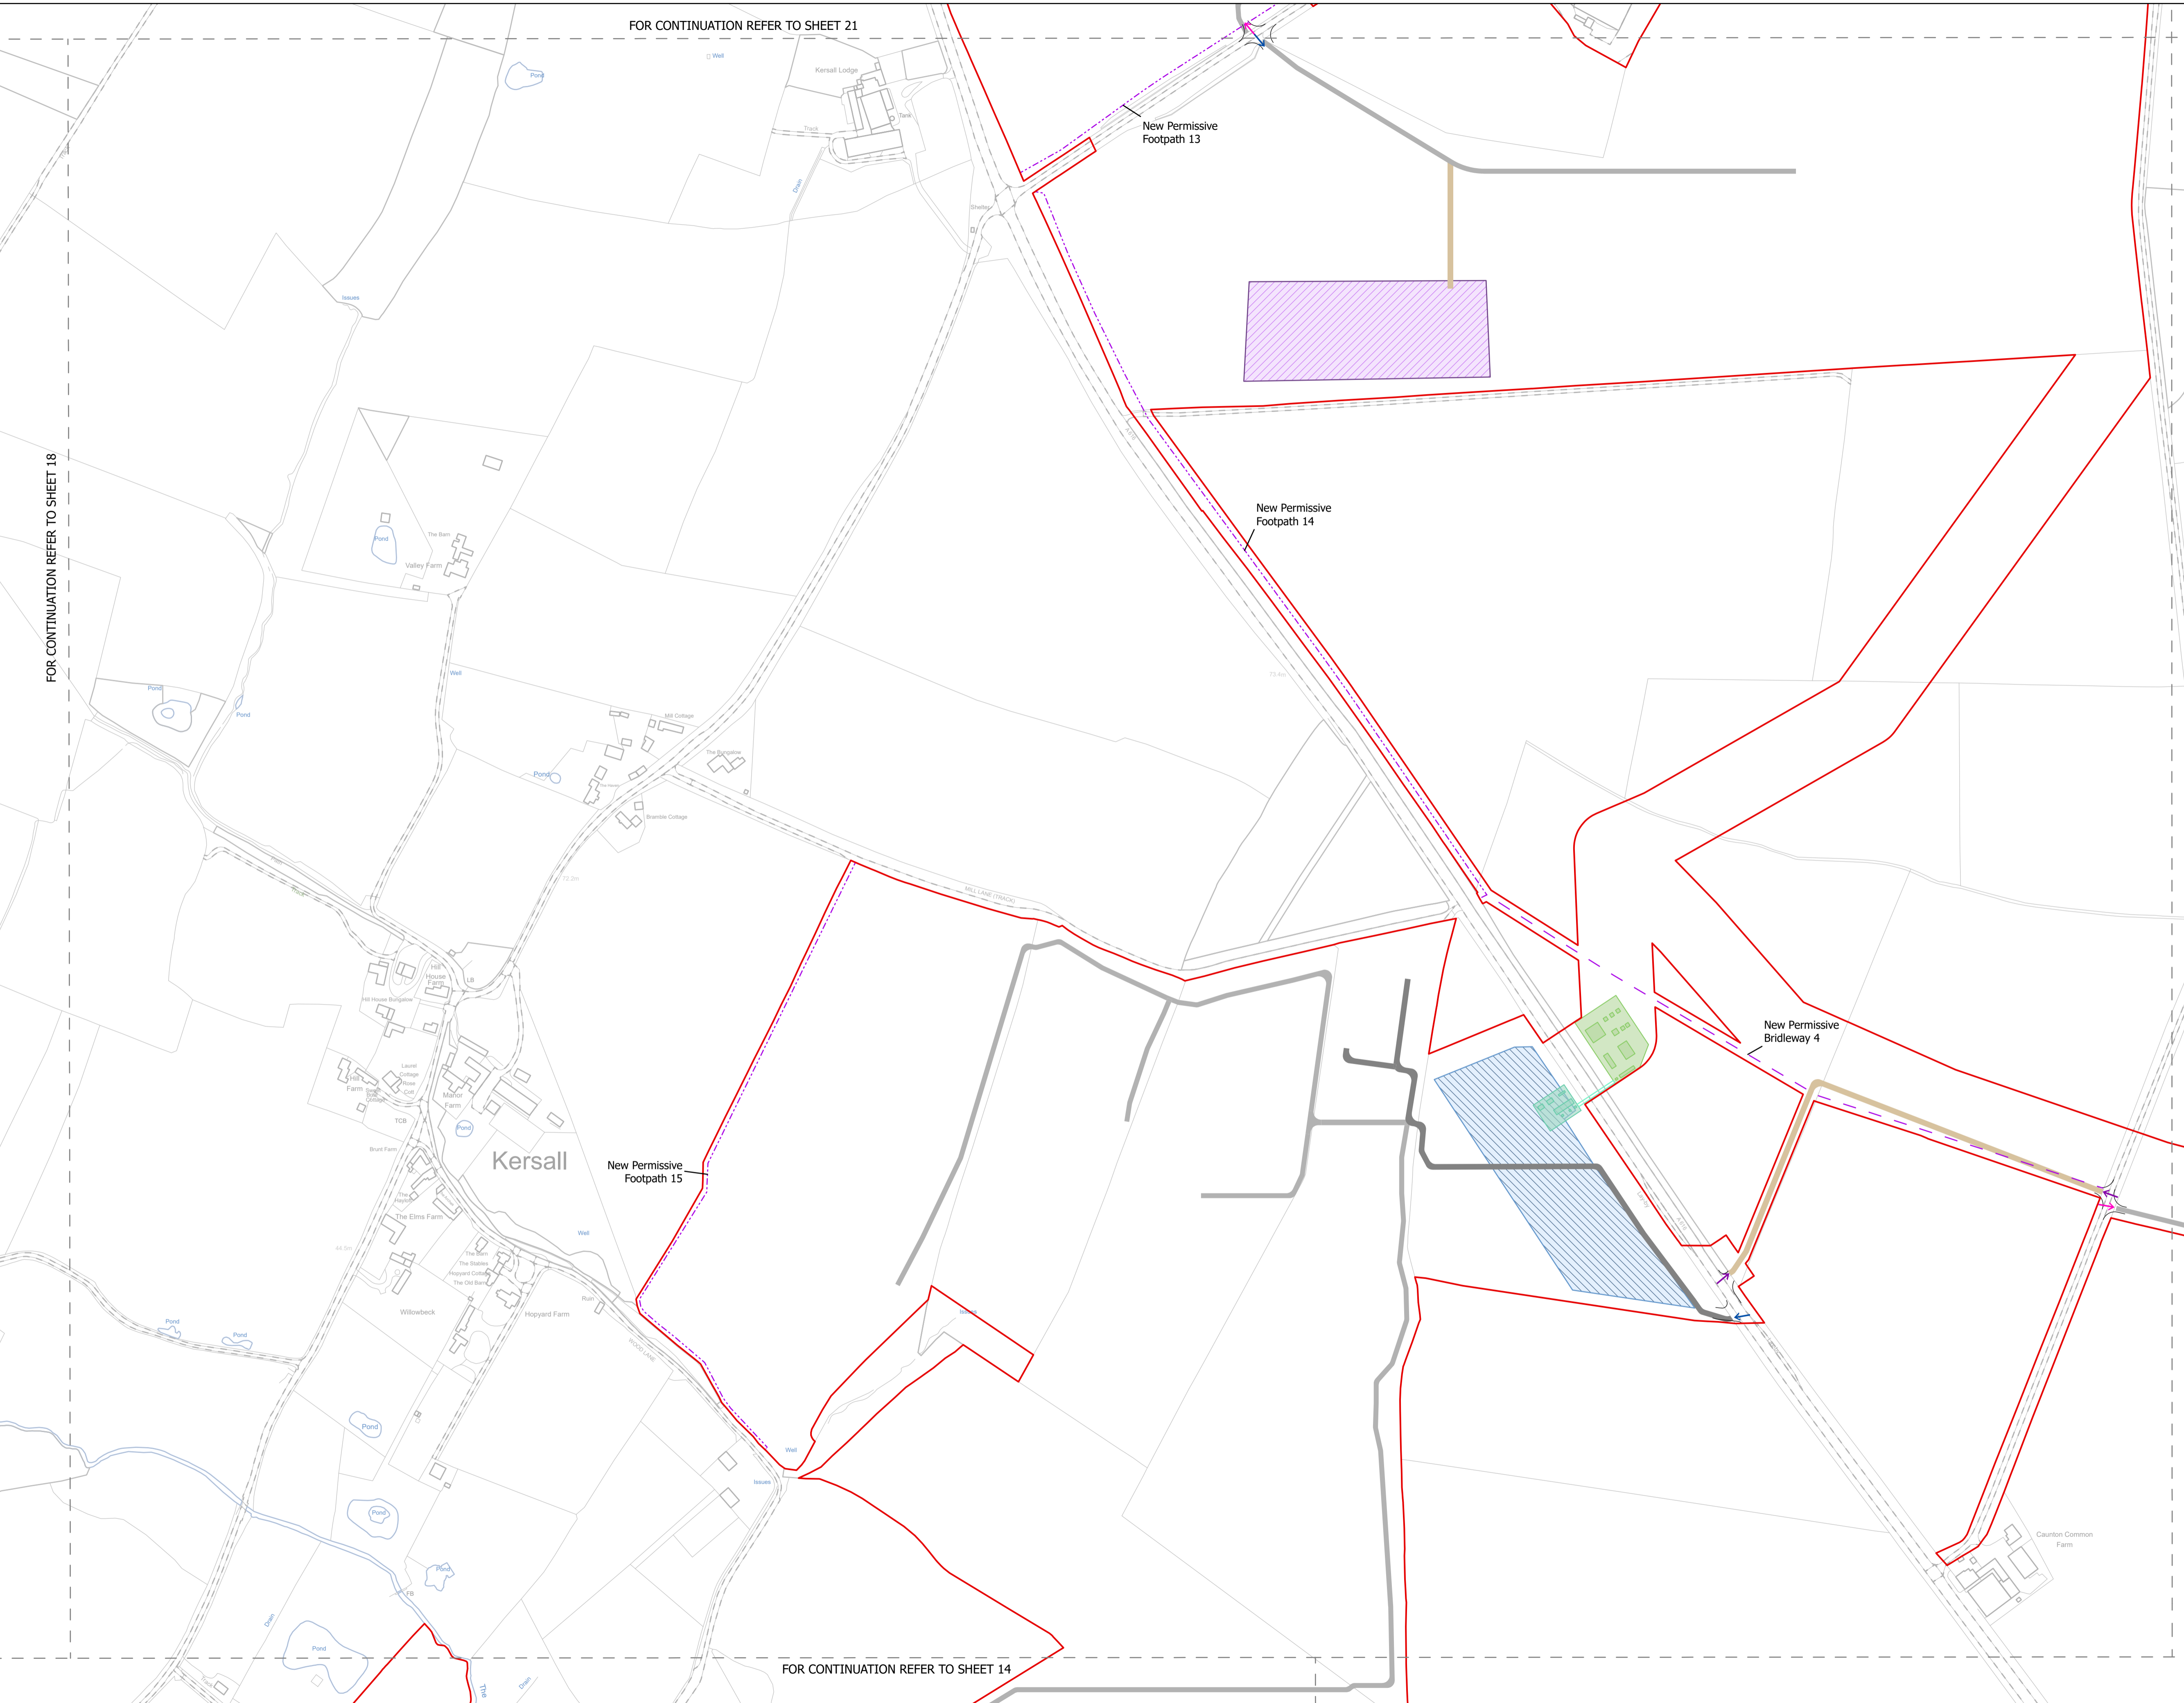

NOTES
1. ALL DIMENSIONS ARE IN METRES UNLESS STATED OTHERWISE.

- Legend**
- Order Limits
 - ↑ Construction Only Access Point
 - ↑ Maintenance and Construction Access Point
 - ↑ Maintenance Access and Construction Cross Over Point
 - Footpath Closure
 - Footpath Diversion
 - Bridleway Closed For Construction and Decommissioning
 - New Permissive Footpath
 - New Permissive Bridleway
 - Bridleway Diversion for Construction and Decommissioning
 - Access Bellmouth
 - Passing Places
 - HDD Connection Channel
 - HDD Compound Pull-Back Rig
 - HDD Compound Rig Side
 - Internal Tarmac Roads
 - Internal Stone Roads
 - Temporary Construction Roads
 - Main Compound Areas
 - Satellite Compound Areas

The Legend is identical on all sheets of the Illustrative Construction Layout and therefore not all items specified in the Legend are found on each sheet

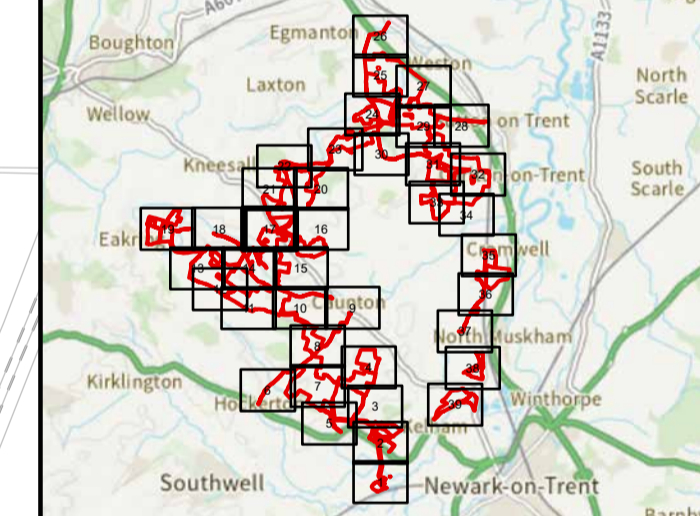

Revision 3	AD	LA	14/04/2026	Rev03
Revision 2	AD	LA	14/01/2026	Rev02
Revision 1	AD	LA	24/06/2025	Rev01
Revision Details	By	Check	Date	Suffix

Applicant: Elements Green Trent Limited

Solar & Biodiversity Park

Project Title:
GREAT NORTH ROAD SOLAR AND BIODIVERSITY PARK

Purpose of Issue:
DCO APPLICATION

Development Consent Order Number:
EN010162

Development Consent Order Drawing Number:
EN010162/APP/6.3.5.5B


Drawing Title:
Illustrative Construction Layout SHEET 17 of 39

Designed: AD	Drawn: AD	Checked: LA	Date: 14/04/2026
Internal Project Number: 026	Suitability: DCO Application		

Scale @ A1:
1:2,500

North arrow pointing up.

Rev: **Rev03**

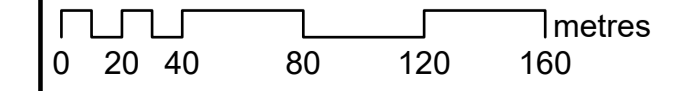




NOTES
1. ALL DIMENSIONS ARE IN METRES UNLESS STATED OTHERWISE.

- Legend**
- Order Limits
 - ↑ Construction Only Access Point
 - ↑ Maintenance and Construction Access Point
 - ↑ Maintenance Access and Construction Cross Over Point
 - Footpath Closure
 - Footpath Diversion
 - - - Bridleway Closed For Construction and Decommissioning
 - - - New Permissive Footpath
 - - - New Permissive Bridleway
 - Bridleway Diversion for Construction and Decommissioning
 - Access Bellmouth
 - Passing Places
 - HDD Connection Channel
 - HDD Compound Pull-Back Rig
 - HDD Compound Rig Side
 - Internal Tarmac Roads
 - Internal Stone Roads
 - Temporary Construction Roads
 - Main Compound Areas
 - Satellite Compound Areas

The Legend is identical on all sheets of the Illustrative Construction Layout and therefore not all items specified in the Legend are found on each sheet

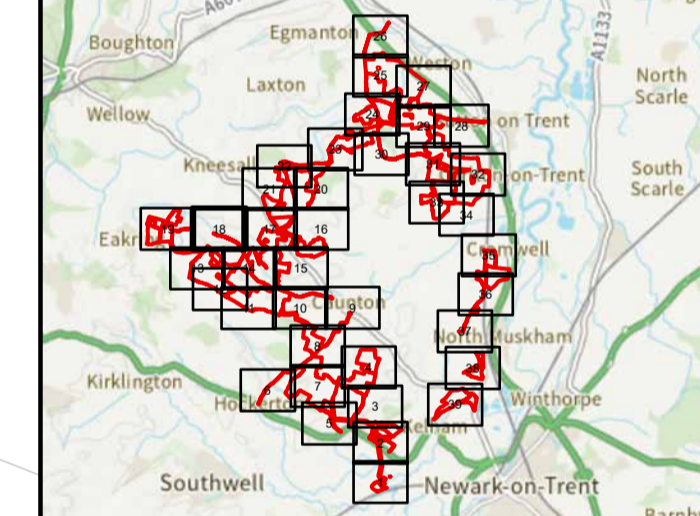

Revision 3	AD	LA	14/04/2026	Rev03
Revision 2	AD	LA	14/01/2026	Rev02
Revision 1	AD	LA	24/06/2025	Rev01
Revision Details	By	Check	Date	Suffix



Project Title:
GREAT NORTH ROAD SOLAR AND BIODIVERSITY PARK

Purpose of Issue:
DCO APPLICATION

Development Consent Order Number:
EN010162


Development Consent Order Drawing Number:
EN010162/APP/6.3.5.5B

Drawing Title:
Illustrative Construction Layout SHEET 18 of 39

Designed: AD	Drawn: AD	Checked: LA	Date: 14/04/2026
Internal Project Number: 026	Suitability: DCO Application		

Scale @ A1:
1:2,500

N	Rev: Rev03
---	---------------

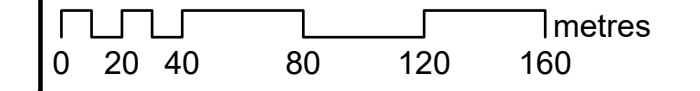


FOR CONTINUATION REFER TO SHEET 19

FOR CONTINUATION REFER TO SHEET 17

FOR CONTINUATION REFER TO SHEET 13


FOR CONTINUATION REFER TO SHEET 14

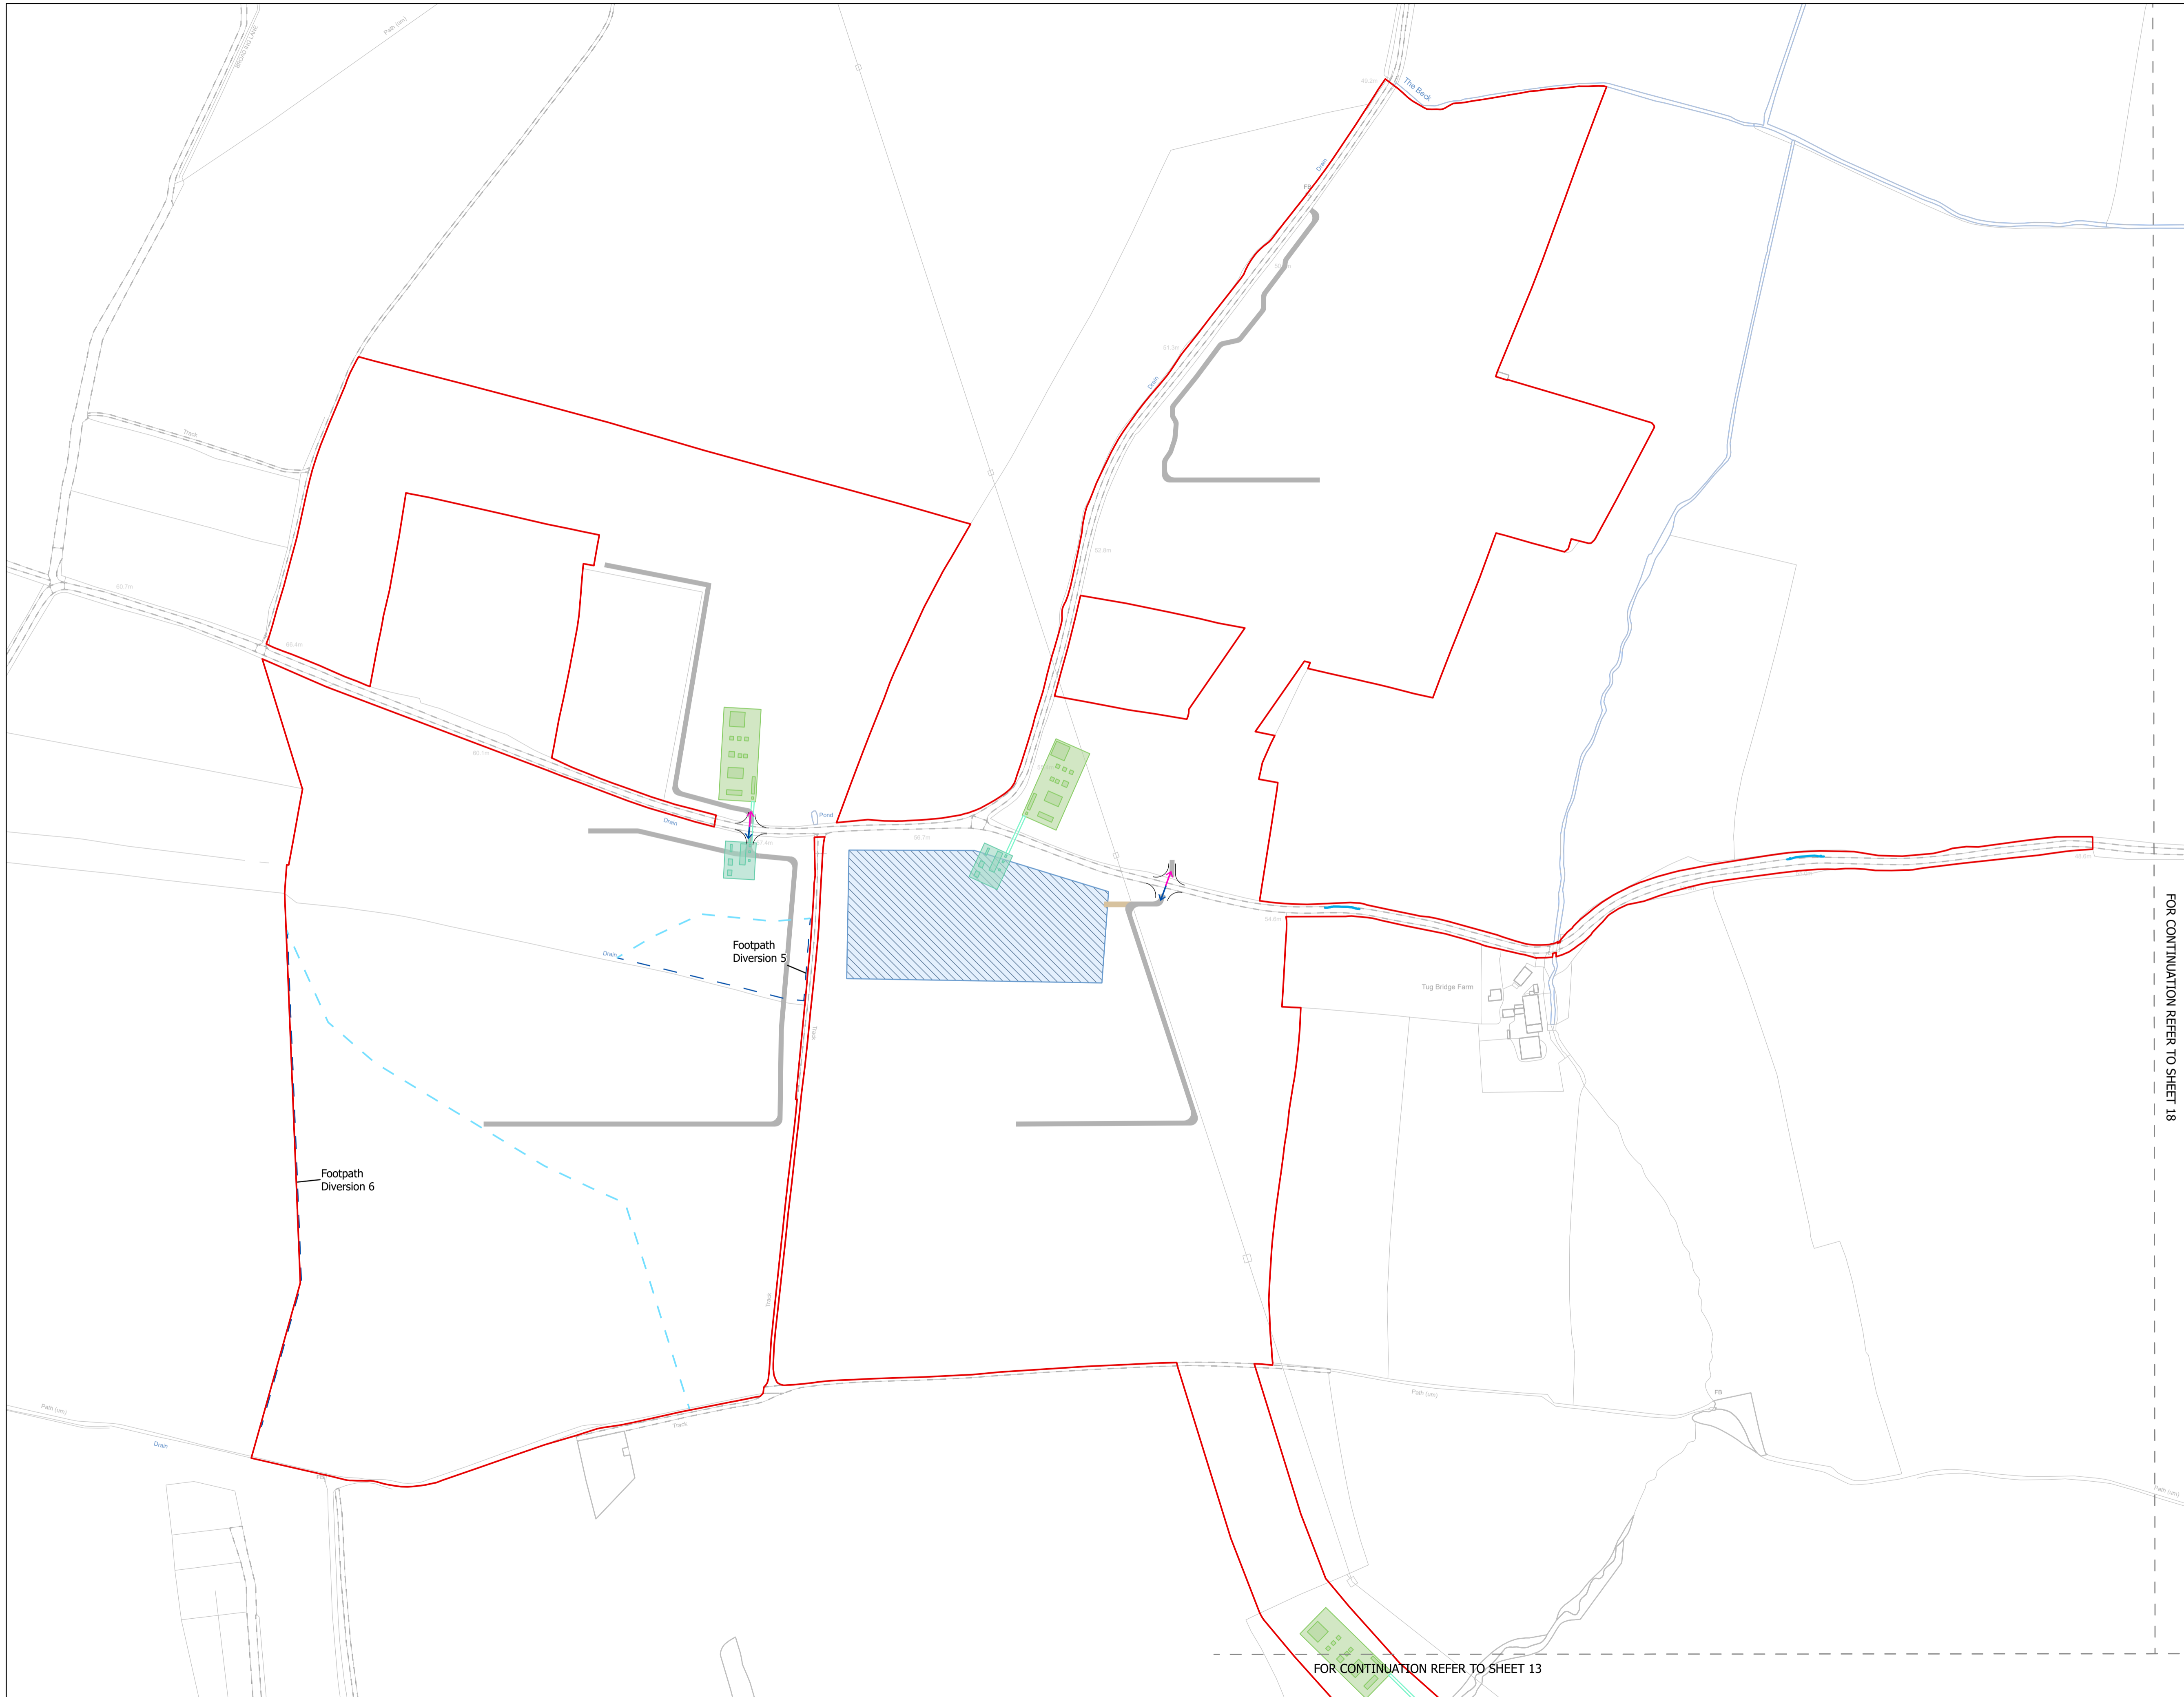

NOTES
1. ALL DIMENSIONS ARE IN METRES UNLESS STATED OTHERWISE.

- Legend**
- Order Limits
 - ↑ Construction Only Access Point
 - ↑ Maintenance and Construction Access Point
 - ↑ Maintenance Access and Construction Cross Over Point
 - Footpath Closure
 - Footpath Diversion
 - Bridleway Closed For Construction and Decommissioning
 - New Permissive Footpath
 - New Permissive Bridleway
 - Bridleway Diversion for Construction and Decommissioning
 - Access Bellmouth
 - Passing Places
 - HDD Connection Channel
 - HDD Compound Pull-Back Rig
 - HDD Compound Rig Side
 - Internal Tarmac Roads
 - Internal Stone Roads
 - Temporary Construction Roads
 - Main Compound Areas
 - Satellite Compound Areas

The Legend is identical on all sheets of the Illustrative Construction Layout and therefore not all items specified in the Legend are found on each sheet

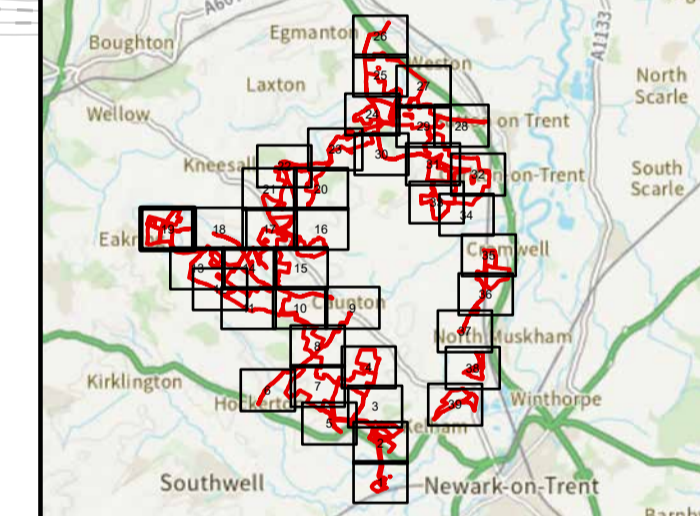

Revision	By	Check	Date	Rev
Revision 3	AD	LA	14/04/2026	Rev03
Revision 2	AD	LA	14/01/2026	Rev02
Revision 1	AD	LA	24/06/2025	Rev01

Applicant: Elements Green Trent Limited



Project Title:
GREAT NORTH ROAD SOLAR AND BIODIVERSITY PARK

Purpose of Issue:
DCO APPLICATION


Development Consent Order Number:
EN010162

Development Consent Order Drawing Number:
EN010162/APP/6.3.5.5B

Drawing Title:
Illustrative Construction Layout SHEET 19 of 39

Designed: AD	Drawn: AD	Checked: LA	Date: 14/04/2026
Internal Project Number: 026		Suitability: DCO Application	

Scale @ A1: 1:2,500	Rev: Rev03
------------------------	---------------

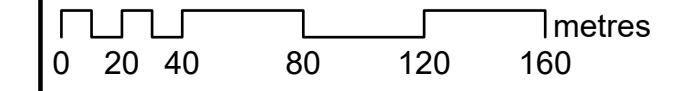


FOR CONTINUATION REFER TO SHEET 18

FOR CONTINUATION REFER TO SHEET 13

FOR CONTINUATION REFER TO SHEET 23

FOR CONTINUATION REFER TO SHEET 21

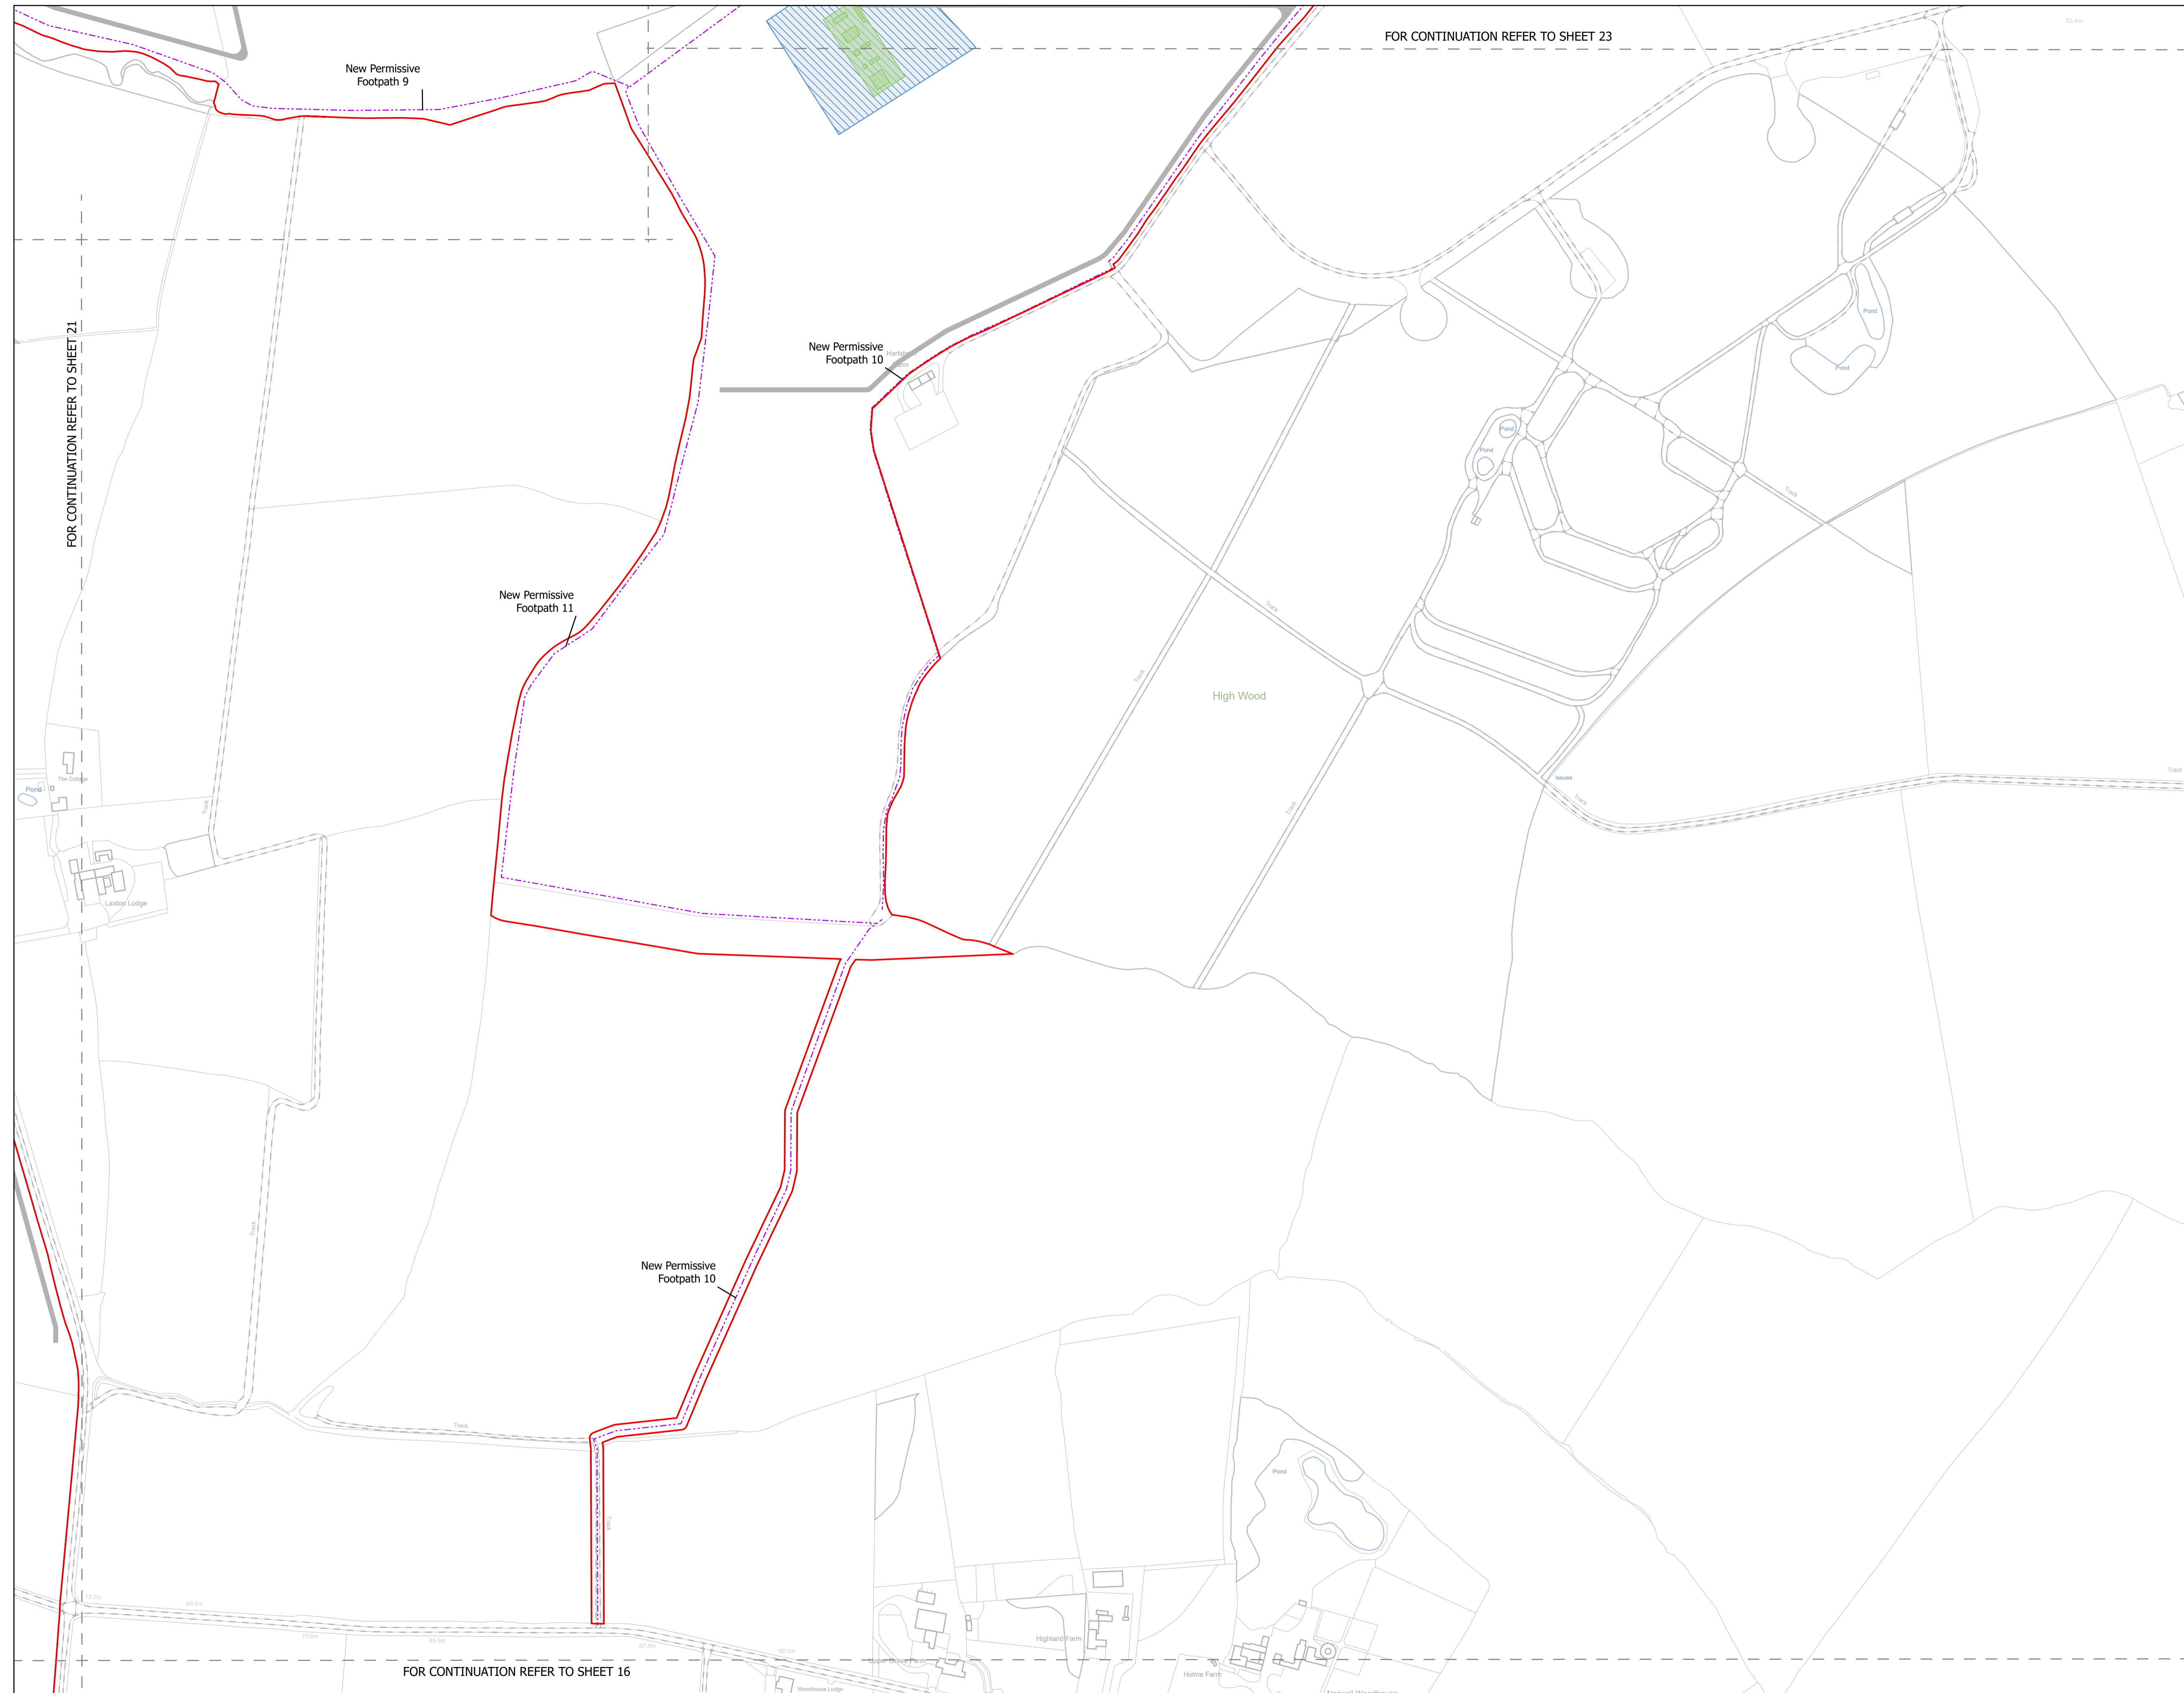


FOR CONTINUATION REFER TO SHEET 16

NOTES
1. ALL DIMENSIONS ARE IN METRES UNLESS STATED OTHERWISE.

Legend

- Order Limits
- ↑ Construction Only Access Point
- ↑ Maintenance and Construction Access Point
- ↑ Maintenance Access and Construction Cross Over Point
- Footpath Closure
- Footpath Diversion
- Bridleway Closed For Construction and Decommissioning
- New Permissive Footpath
- New Permissive Bridleway
- Bridleway Diversion for Construction and Decommissioning
- Access Bellmouth
- Passing Places
- HDD Connection Channel
- HDD Compound Pull-Back Rig
- HDD Compound Rig Side
- Internal Tarmac Roads
- Internal Stone Roads
- Temporary Construction Roads
- Main Compound Areas
- Satellite Compound Areas

The Legend is identical on all sheets of the Illustrative Construction Layout and therefore not all items specified in the Legend are found on each sheet

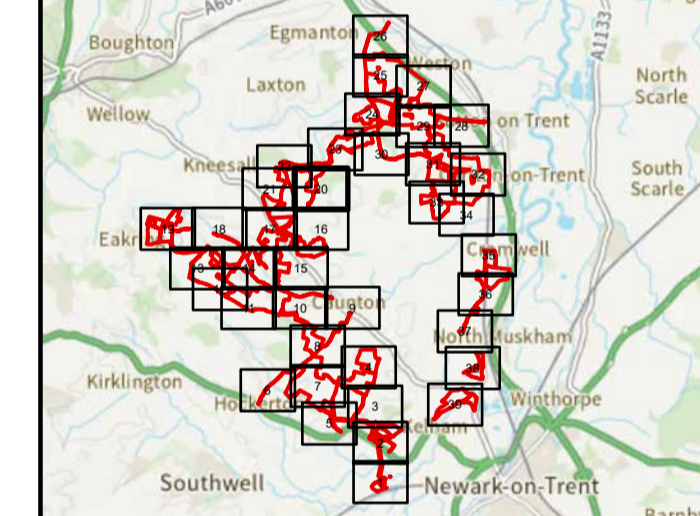

Revision 3	AD	LA	14/04/2026	Rev03
Revision 2	AD	LA	14/01/2026	Rev02
Revision 1	AD	LA	24/06/2025	Rev01
Revision Details	By	Check	Date	Suffix



Project Title:
GREAT NORTH ROAD SOLAR AND BIODIVERSITY PARK

Purpose of Issue:
DCO APPLICATION

Development Consent Order Number:
EN010162


Development Consent Order Drawing Number:
EN010162/APP/6.3.5.5B


Drawing Title:
Illustrative Construction Layout SHEET 20 of 39

Designed: AD	Drawn: AD	Checked: LA	Date: 14/04/2026
Internal Project Number: 026		Suitability: DCO Application	

Scale @ A1:
1:2,500

N	Rev: Rev03
---	---------------

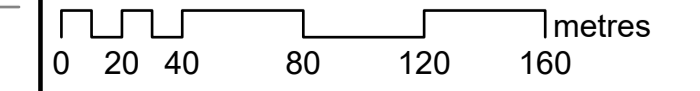

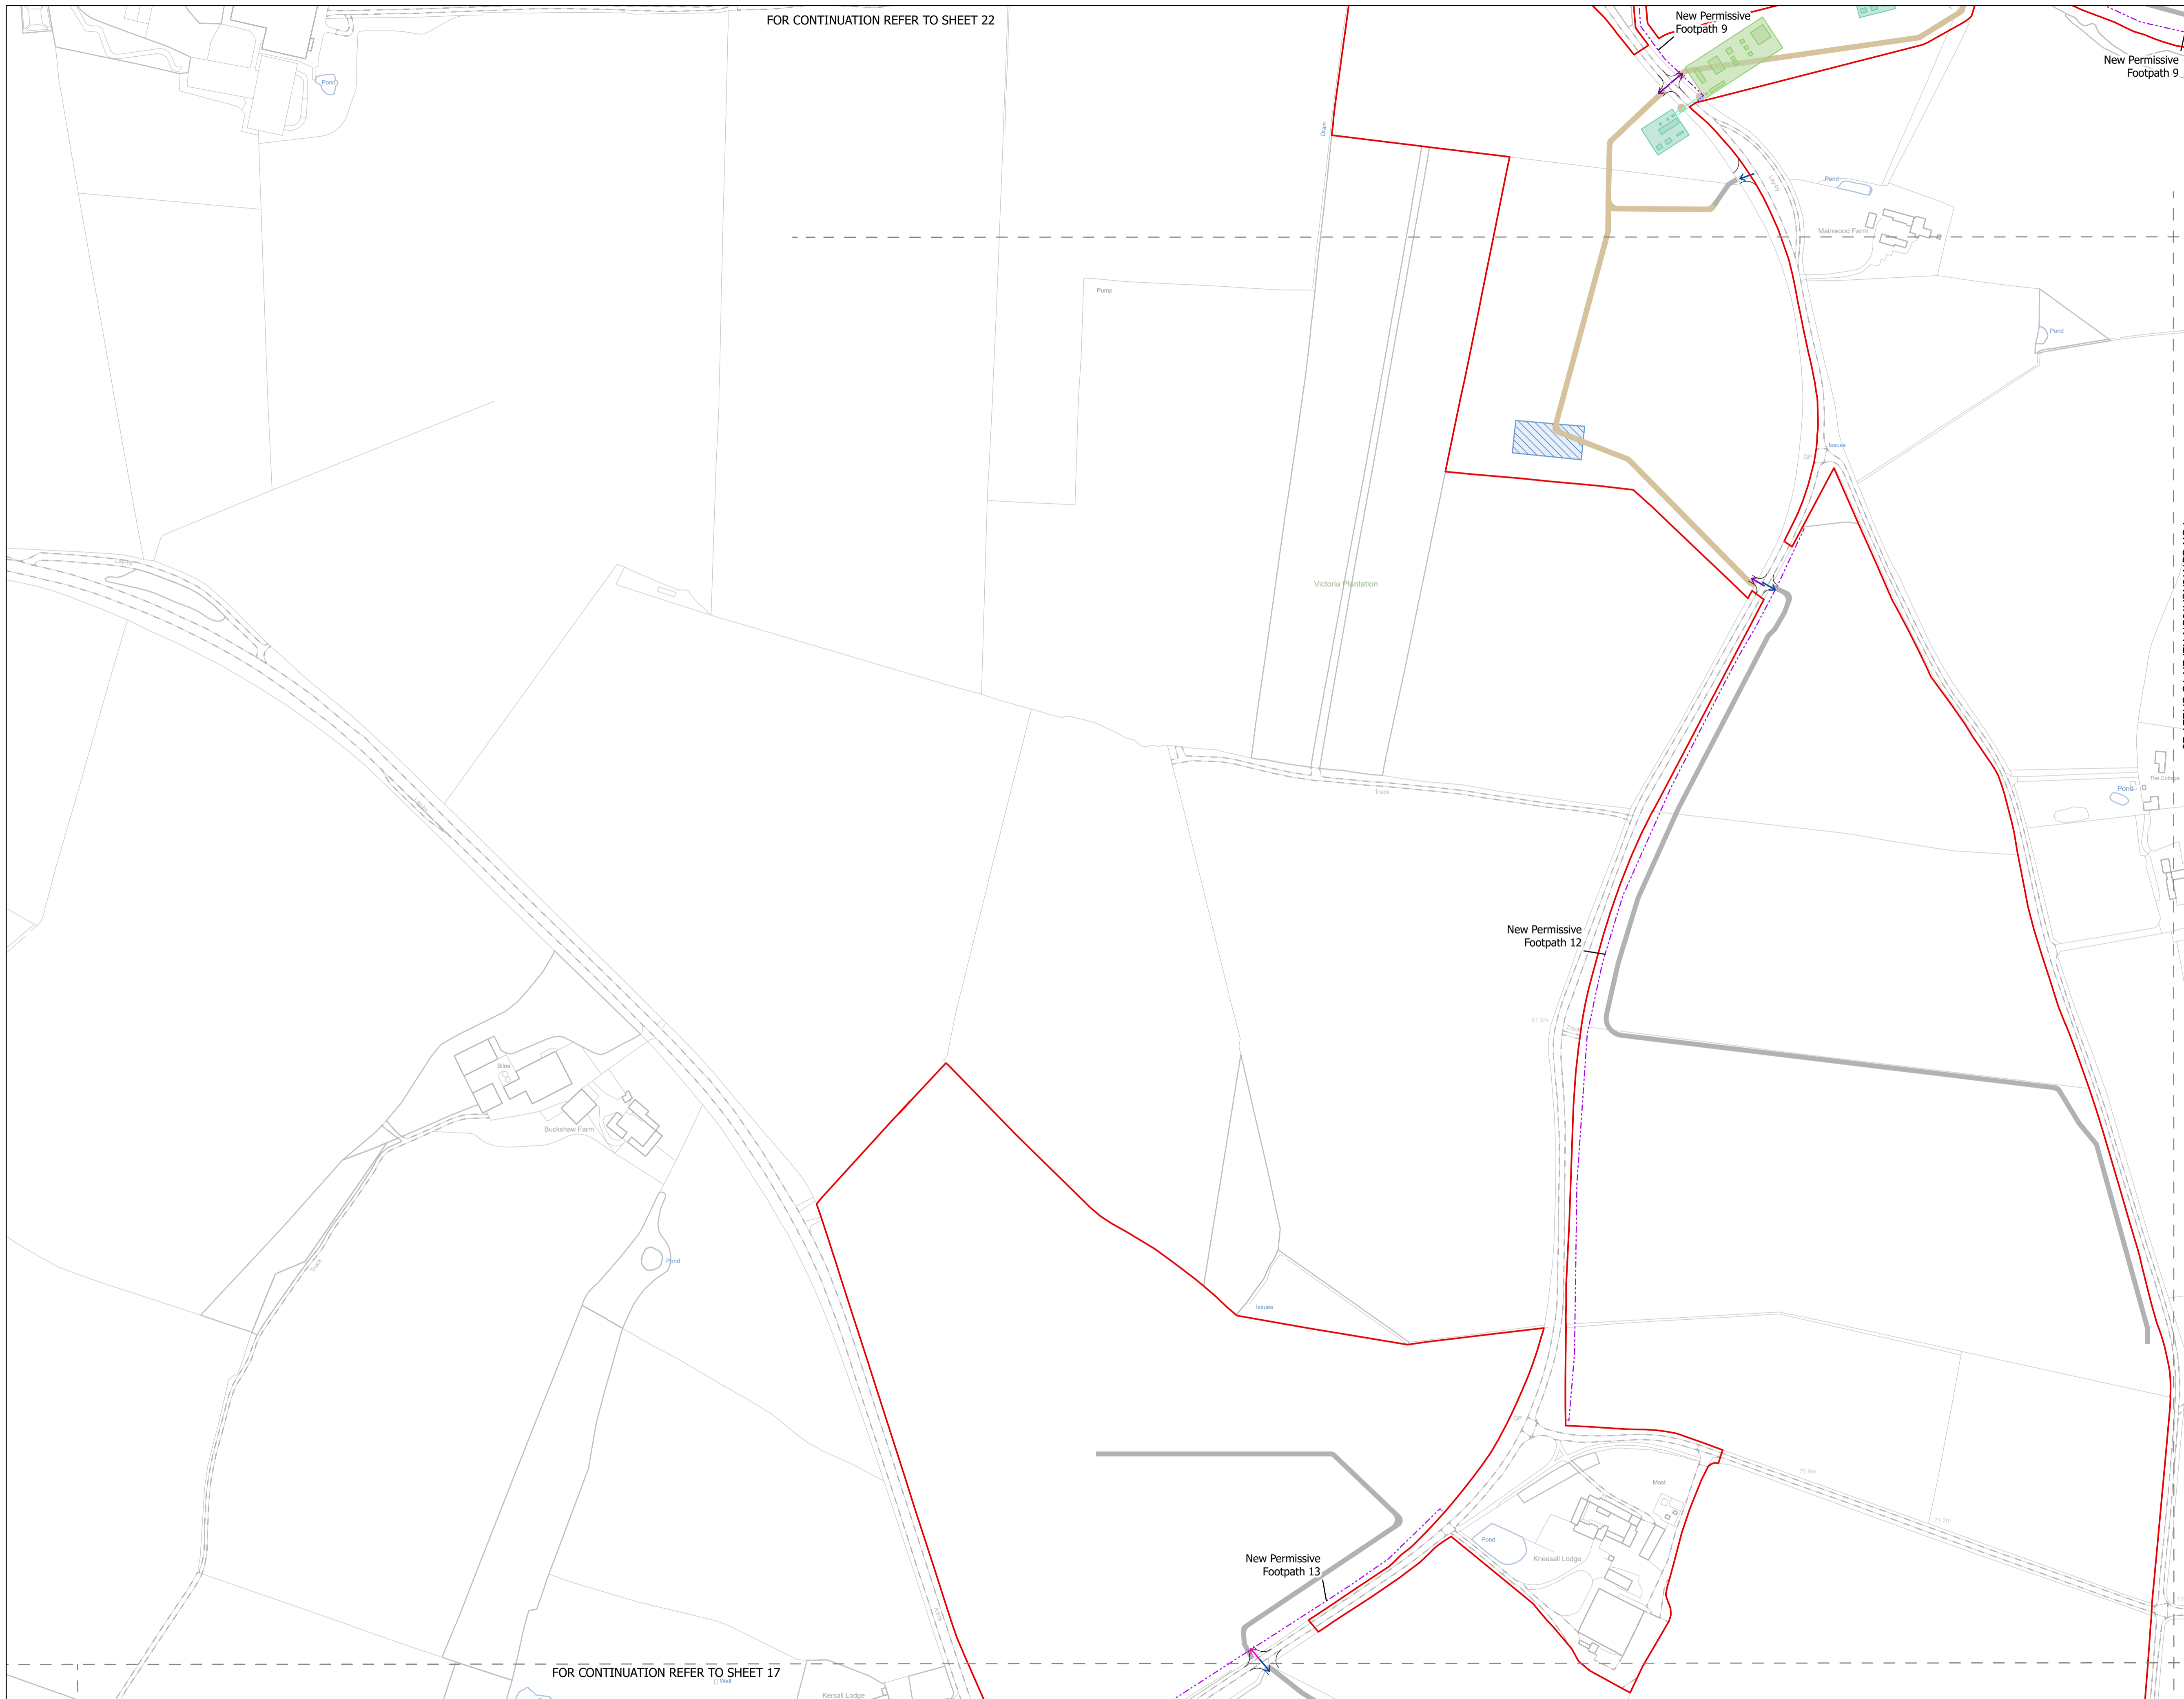

FOR CONTINUATION REFER TO SHEET 22


FOR CONTINUATION REFER TO SHEET 17

NOTES
1. ALL DIMENSIONS ARE IN METRES UNLESS STATED OTHERWISE.

Legend

- Order Limits
- ↑ Construction Only Access Point
- ↑ Maintenance and Construction Access Point
- ↑ Maintenance Access and Construction Cross Over Point
- Footpath Closure
- Footpath Diversion
- Bridleway Closed For Construction and Decommissioning
- New Permissive Footpath
- New Permissive Bridleway
- Bridleway Diversion for Construction and Decommissioning
- Access Bellmouth
- Passing Places
- HDD Connection Channel
- HDD Compound Pull-Back Rig
- HDD Compound Rig Side
- Internal Tarmac Roads
- Internal Stone Roads
- Temporary Construction Roads
- Main Compound Areas
- Satellite Compound Areas

The Legend is identical on all sheets of the Illustrative Construction Layout and therefore not all items specified in the Legend are found on each sheet

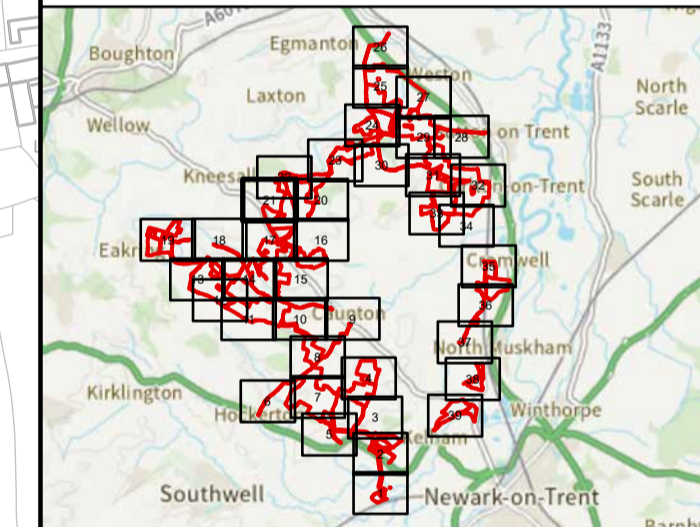

Revision 3	AD	LA	14/04/2026	Rev03
Revision 2	AD	LA	14/01/2026	Rev02
Revision 1	AD	LA	24/06/2025	Rev01
Revision Details	By	Check	Date	Suffix

Applicant: Elements Green Trent Limited

Solar & Biodiversity Park

Project Title:
GREAT NORTH ROAD SOLAR AND BIODIVERSITY PARK

Purpose of Issue:
DCO APPLICATION

Development Consent Order Number:
EN010162

Development Consent Order Drawing Number:
EN010162/APP/6.3.5.5B

Drawing Title:
Illustrative Construction Layout SHEET 21 of 39


Designed: AD	Drawn: AD	Checked: LA	Date: 14/04/2026
-----------------	--------------	----------------	---------------------

Internal Project Number:
026

Suitability:
DCO Application

Scale @ A1:
1:2,500

N	Rev: Rev03
---	---------------

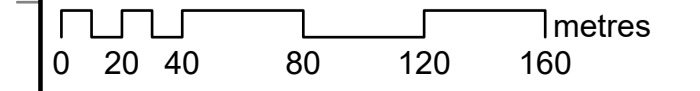




FOR CONTINUATION REFER TO SHEET 23

NOTES
1. ALL DIMENSIONS ARE IN METRES UNLESS STATED OTHERWISE.

- Legend**
- Order Limits
 - ↑ Construction Only Access Point
 - ↑ Maintenance and Construction Access Point
 - ↑ Maintenance Access and Construction Cross Over Point
 - Footpath Closure
 - Footpath Diversion
 - Bridleway Closed For Construction and Decommissioning
 - New Permissive Footpath
 - New Permissive Bridleway
 - Bridleway Diversion for Construction and Decommissioning
 - Access Bellmouth
 - Passing Places
 - HDD Connection Channel
 - HDD Compound Pull-Back Rig
 - HDD Compound Rig Side
 - Internal Tarmac Roads
 - Internal Stone Roads
 - Temporary Construction Roads
 - Main Compound Areas
 - Satellite Compound Areas

The Legend is identical on all sheets of the Illustrative Construction Layout and therefore not all items specified in the Legend are found on each sheet

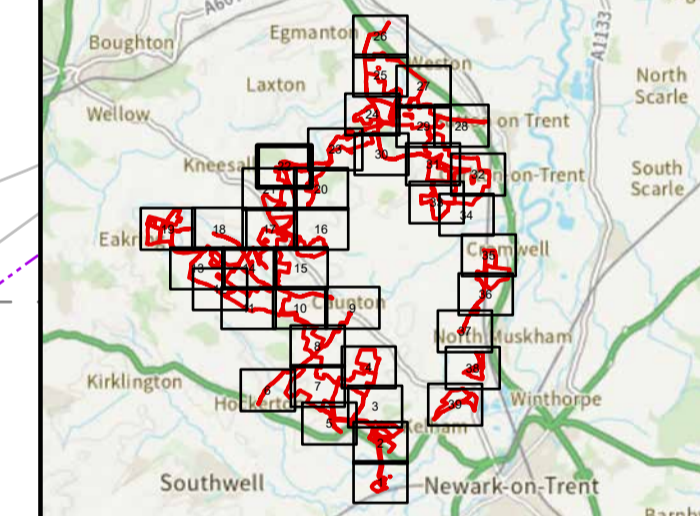

Revision 3	AD	LA	14/04/2026	Rev03
Revision 2	AD	LA	14/01/2026	Rev02
Revision 1	AD	LA	24/06/2025	Rev01
Revision Details	By	Check	Date	Suffix

Applicant: Elements Green Trent Limited



Project Title:
GREAT NORTH ROAD SOLAR AND BIODIVERSITY PARK

Purpose of Issue:
DCO APPLICATION

Development Consent Order Number:
EN010162


Development Consent Order Drawing Number:
EN010162/APP/6.3.5.5B


Drawing Title:
Illustrative Construction Layout SHEET 22 of 39

Designed: AD	Drawn: AD	Checked: LA	Date: 14/04/2026
Internal Project Number: 026	Suitability: DCO Application		

Scale @ A1:
1:2,500

N	Rev: Rev03
---	---------------

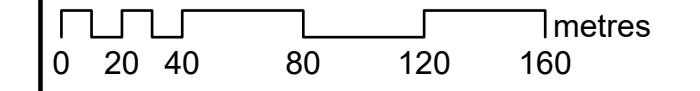


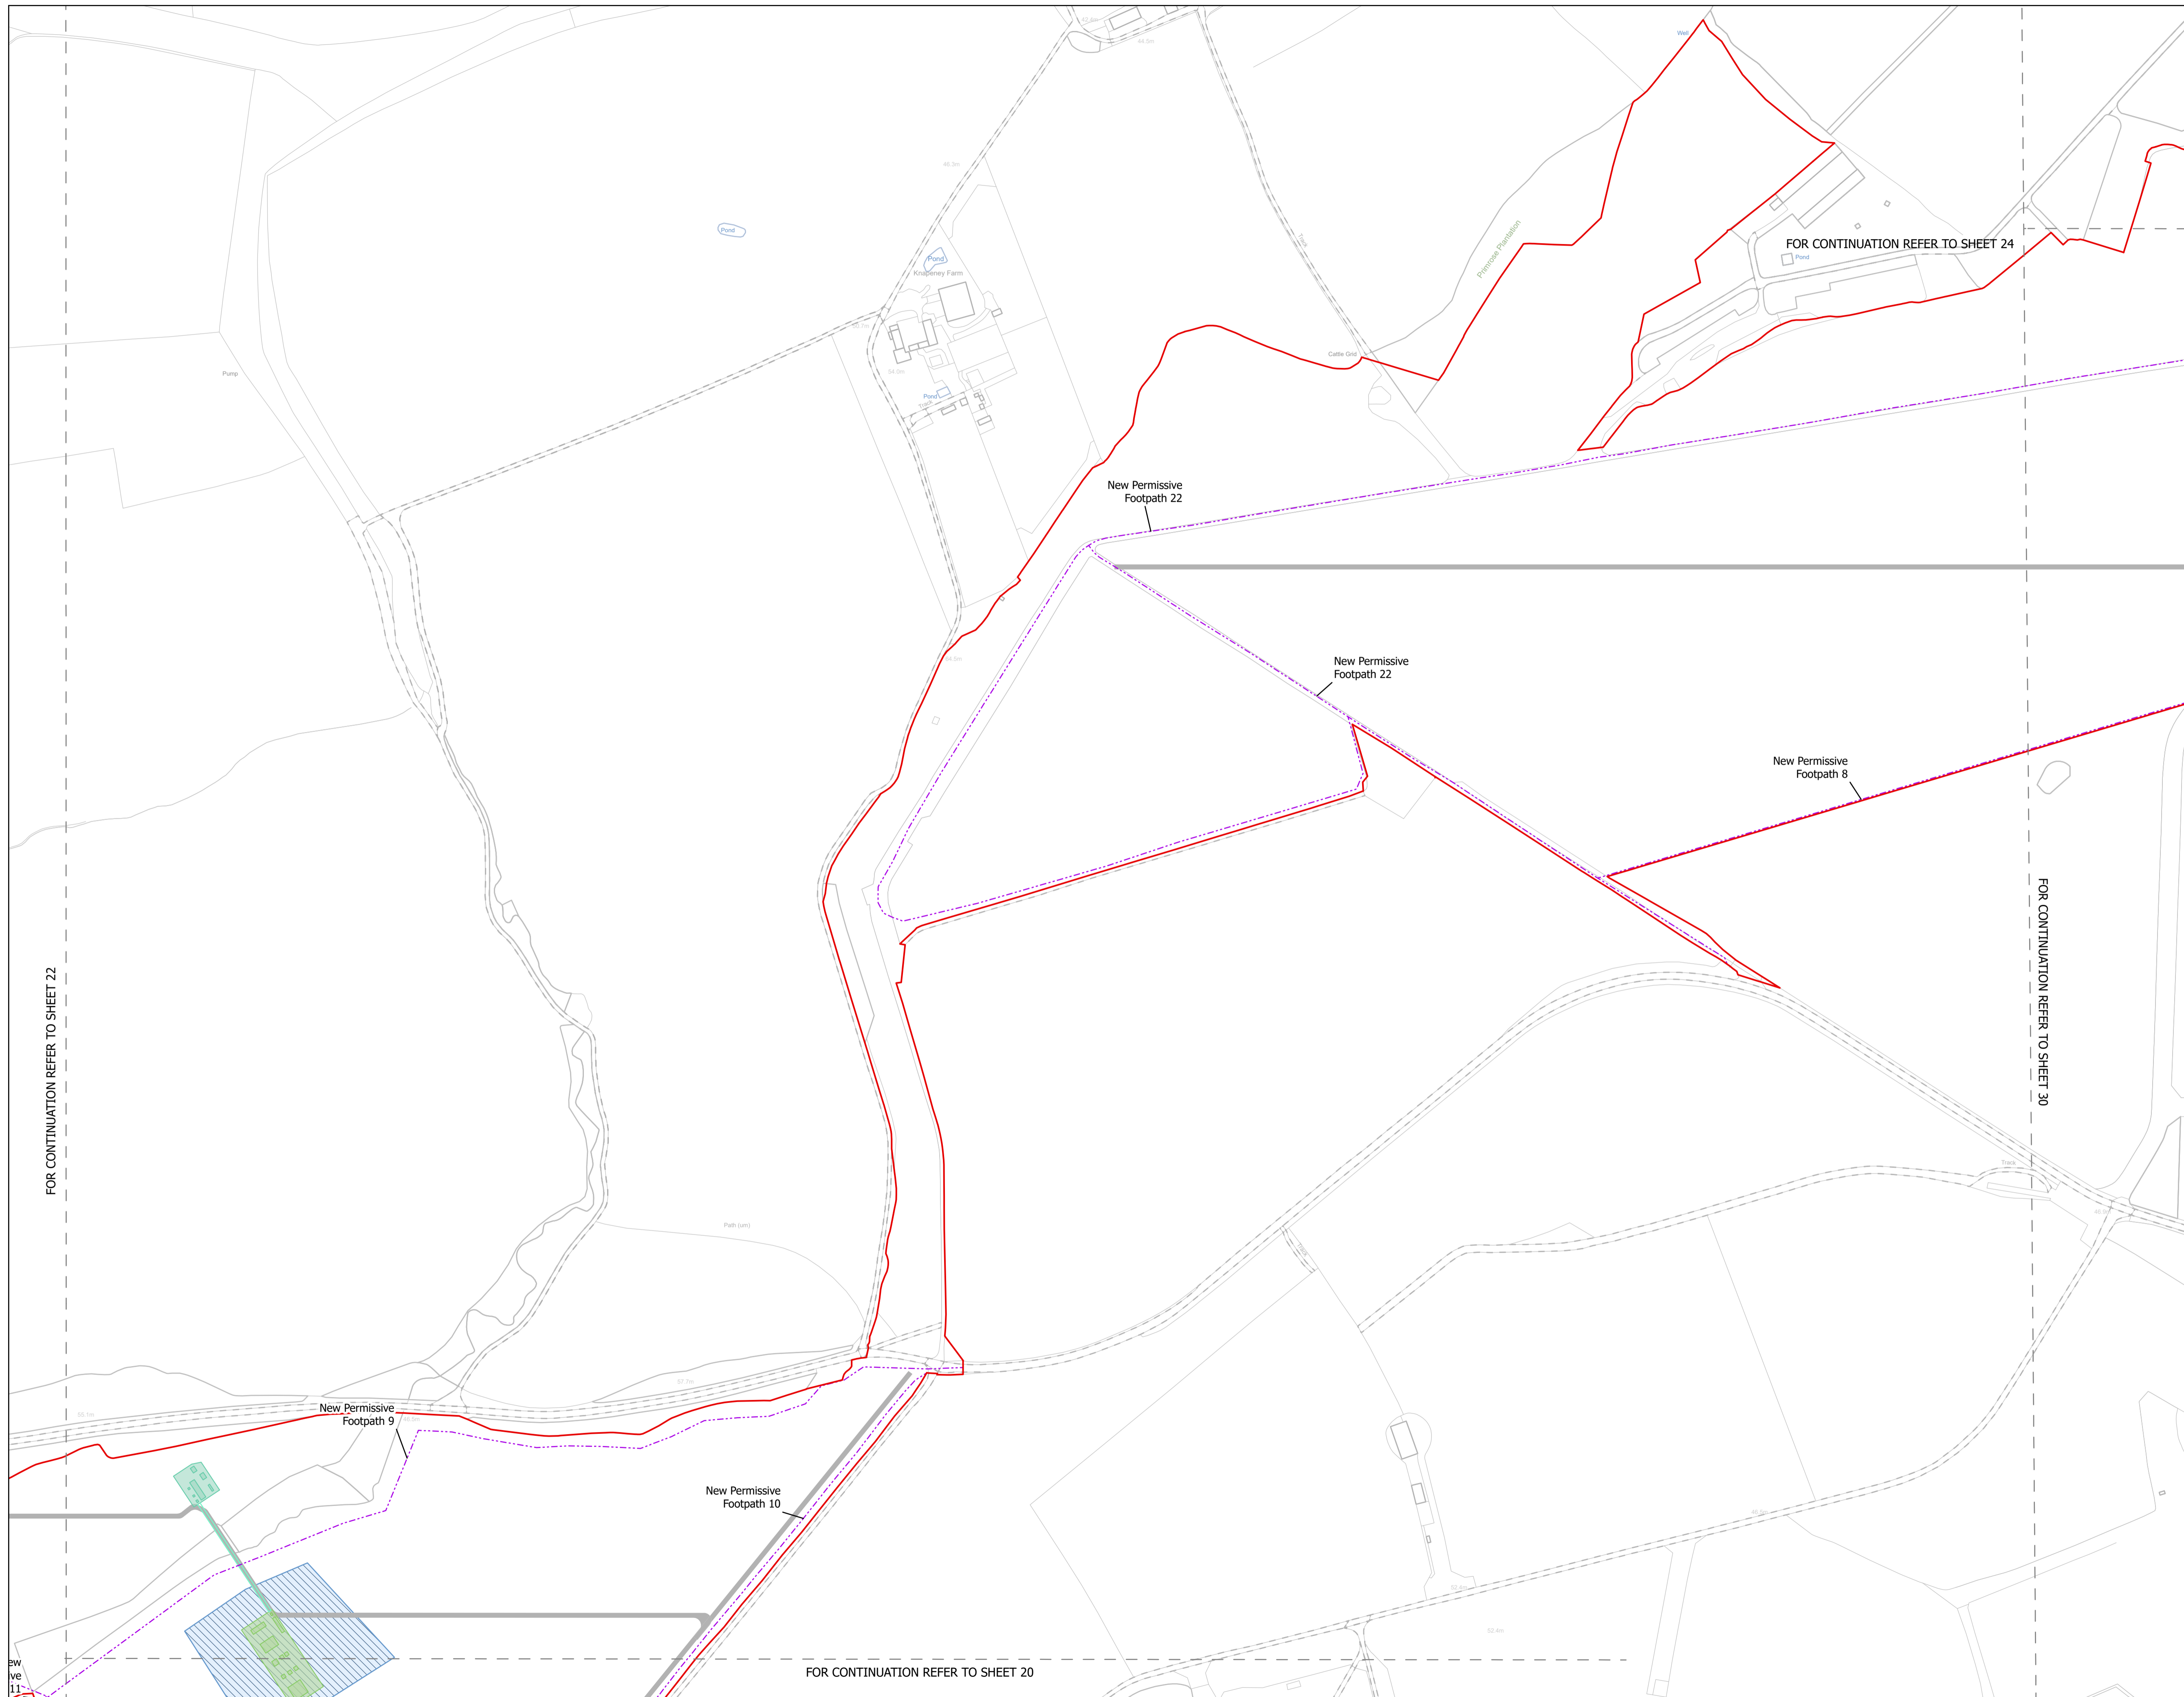

NOTES
1. ALL DIMENSIONS ARE IN METRES UNLESS STATED OTHERWISE.

- Legend**
- Order Limits
 - ↑ Construction Only Access Point
 - ↑ Maintenance and Construction Access Point
 - ↑ Maintenance Access and Construction Cross Over Point
 - Footpath Closure
 - Footpath Diversion
 - Bridleway Closed For Construction and Decommissioning
 - New Permissive Footpath
 - New Permissive Bridleway
 - Bridleway Diversion for Construction and Decommissioning
 - Access Bellmouth
 - Passing Places
 - HDD Connection Channel
 - HDD Compound Pull-Back Rig
 - HDD Compound Rig Side
 - Internal Tarmac Roads
 - Internal Stone Roads
 - Temporary Construction Roads
 - Main Compound Areas
 - Satellite Compound Areas

The Legend is identical on all sheets of the Illustrative Construction Layout and therefore not all items specified in the Legend are found on each sheet

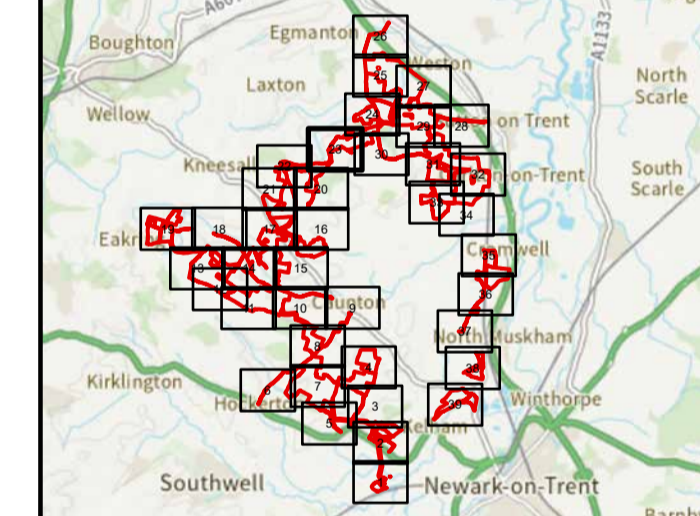

Revision 3	AD	LA	14/04/2026	Rev03
Revision 2	AD	LA	14/01/2026	Rev02
Revision 1	AD	LA	24/06/2025	Rev01
Revision Details	By	Check	Date	Suffix



Project Title:
GREAT NORTH ROAD SOLAR AND BIODIVERSITY PARK

Purpose of Issue:
DCO APPLICATION

Development Consent Order Number:
EN010162


Development Consent Order Drawing Number:
EN010162/APP/6.3.5.5B

Drawing Title:
Illustrative Construction Layout SHEET 23 of 39

Designed: AD	Drawn: AD	Checked: LA	Date: 14/04/2026
Internal Project Number: 026	Suitability: DCO Application		

Scale @ A1:
1:2,500

N	Rev: Rev03
---	---------------

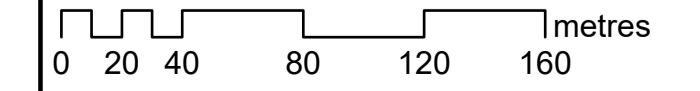


FOR CONTINUATION REFER TO SHEET 25

NOTES
1. ALL DIMENSIONS ARE IN METRES UNLESS STATED OTHERWISE.

Legend

- Order Limits
- ↑ Construction Only Access Point
- ↑ Maintenance and Construction Access Point
- ↑ Maintenance Access and Construction Cross Over Point
- Footpath Closure
- Footpath Diversion
- Bridleway Closed For Construction and Decommissioning
- New Permissive Footpath
- New Permissive Bridleway
- Bridleway Diversion for Construction and Decommissioning
- Access Bellmouth
- Passing Places
- HDD Connection Channel
- HDD Compound Pull-Back Rig
- HDD Compound Rig Side
- Internal Tarmac Roads
- Internal Stone Roads
- Temporary Construction Roads
- Main Compound Areas
- Satellite Compound Areas

The Legend is identical on all sheets of the Illustrative Construction Layout and therefore not all items specified in the Legend are found on each sheet

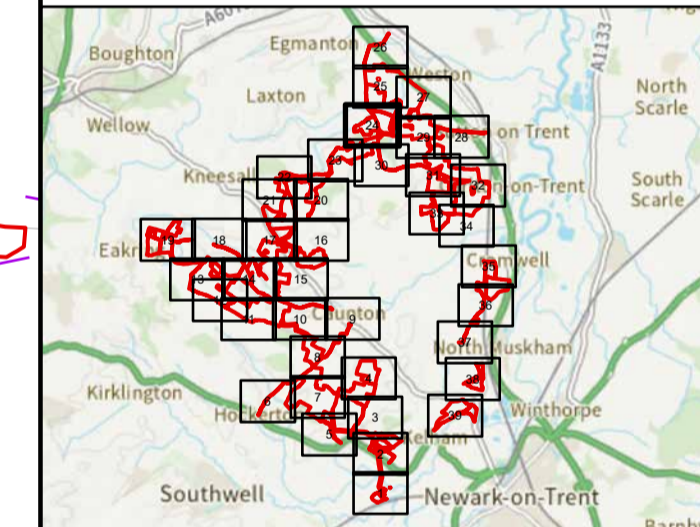

Revision 3	AD	LA	14/04/2026	Rev03
Revision 2	AD	LA	14/01/2026	Rev02
Revision 1	AD	LA	24/06/2025	Rev01
Revision Details	By	Check	Date	Suffix

Applicant: Elements Green Trent Limited

Solar & Biodiversity Park

Project Title:
GREAT NORTH ROAD SOLAR AND BIODIVERSITY PARK

Purpose of Issue:
DCO APPLICATION

Development Consent Order Number:
EN010162

Development Consent Order Drawing Number:
EN010162/APP/6.3.5.5B


Drawing Title:
Illustrative Construction Layout SHEET 24 of 39

Designed: AD	Drawn: AD	Checked: LA	Date: 14/04/2026
-----------------	--------------	----------------	---------------------

Internal Project Number: 026	Suitability: DCO Application
---------------------------------	---------------------------------

Scale @ A1:
1:2,500

N	Rev: Rev03
---	---------------

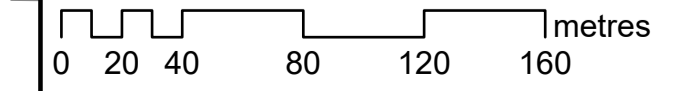


FOR CONTINUATION REFER TO SHEET 23

FOR CONTINUATION REFER TO SHEET 30

FOR CONTINUATION REFER TO SHEET 27

FOR CONTINUATION REFER TO SHEET 29

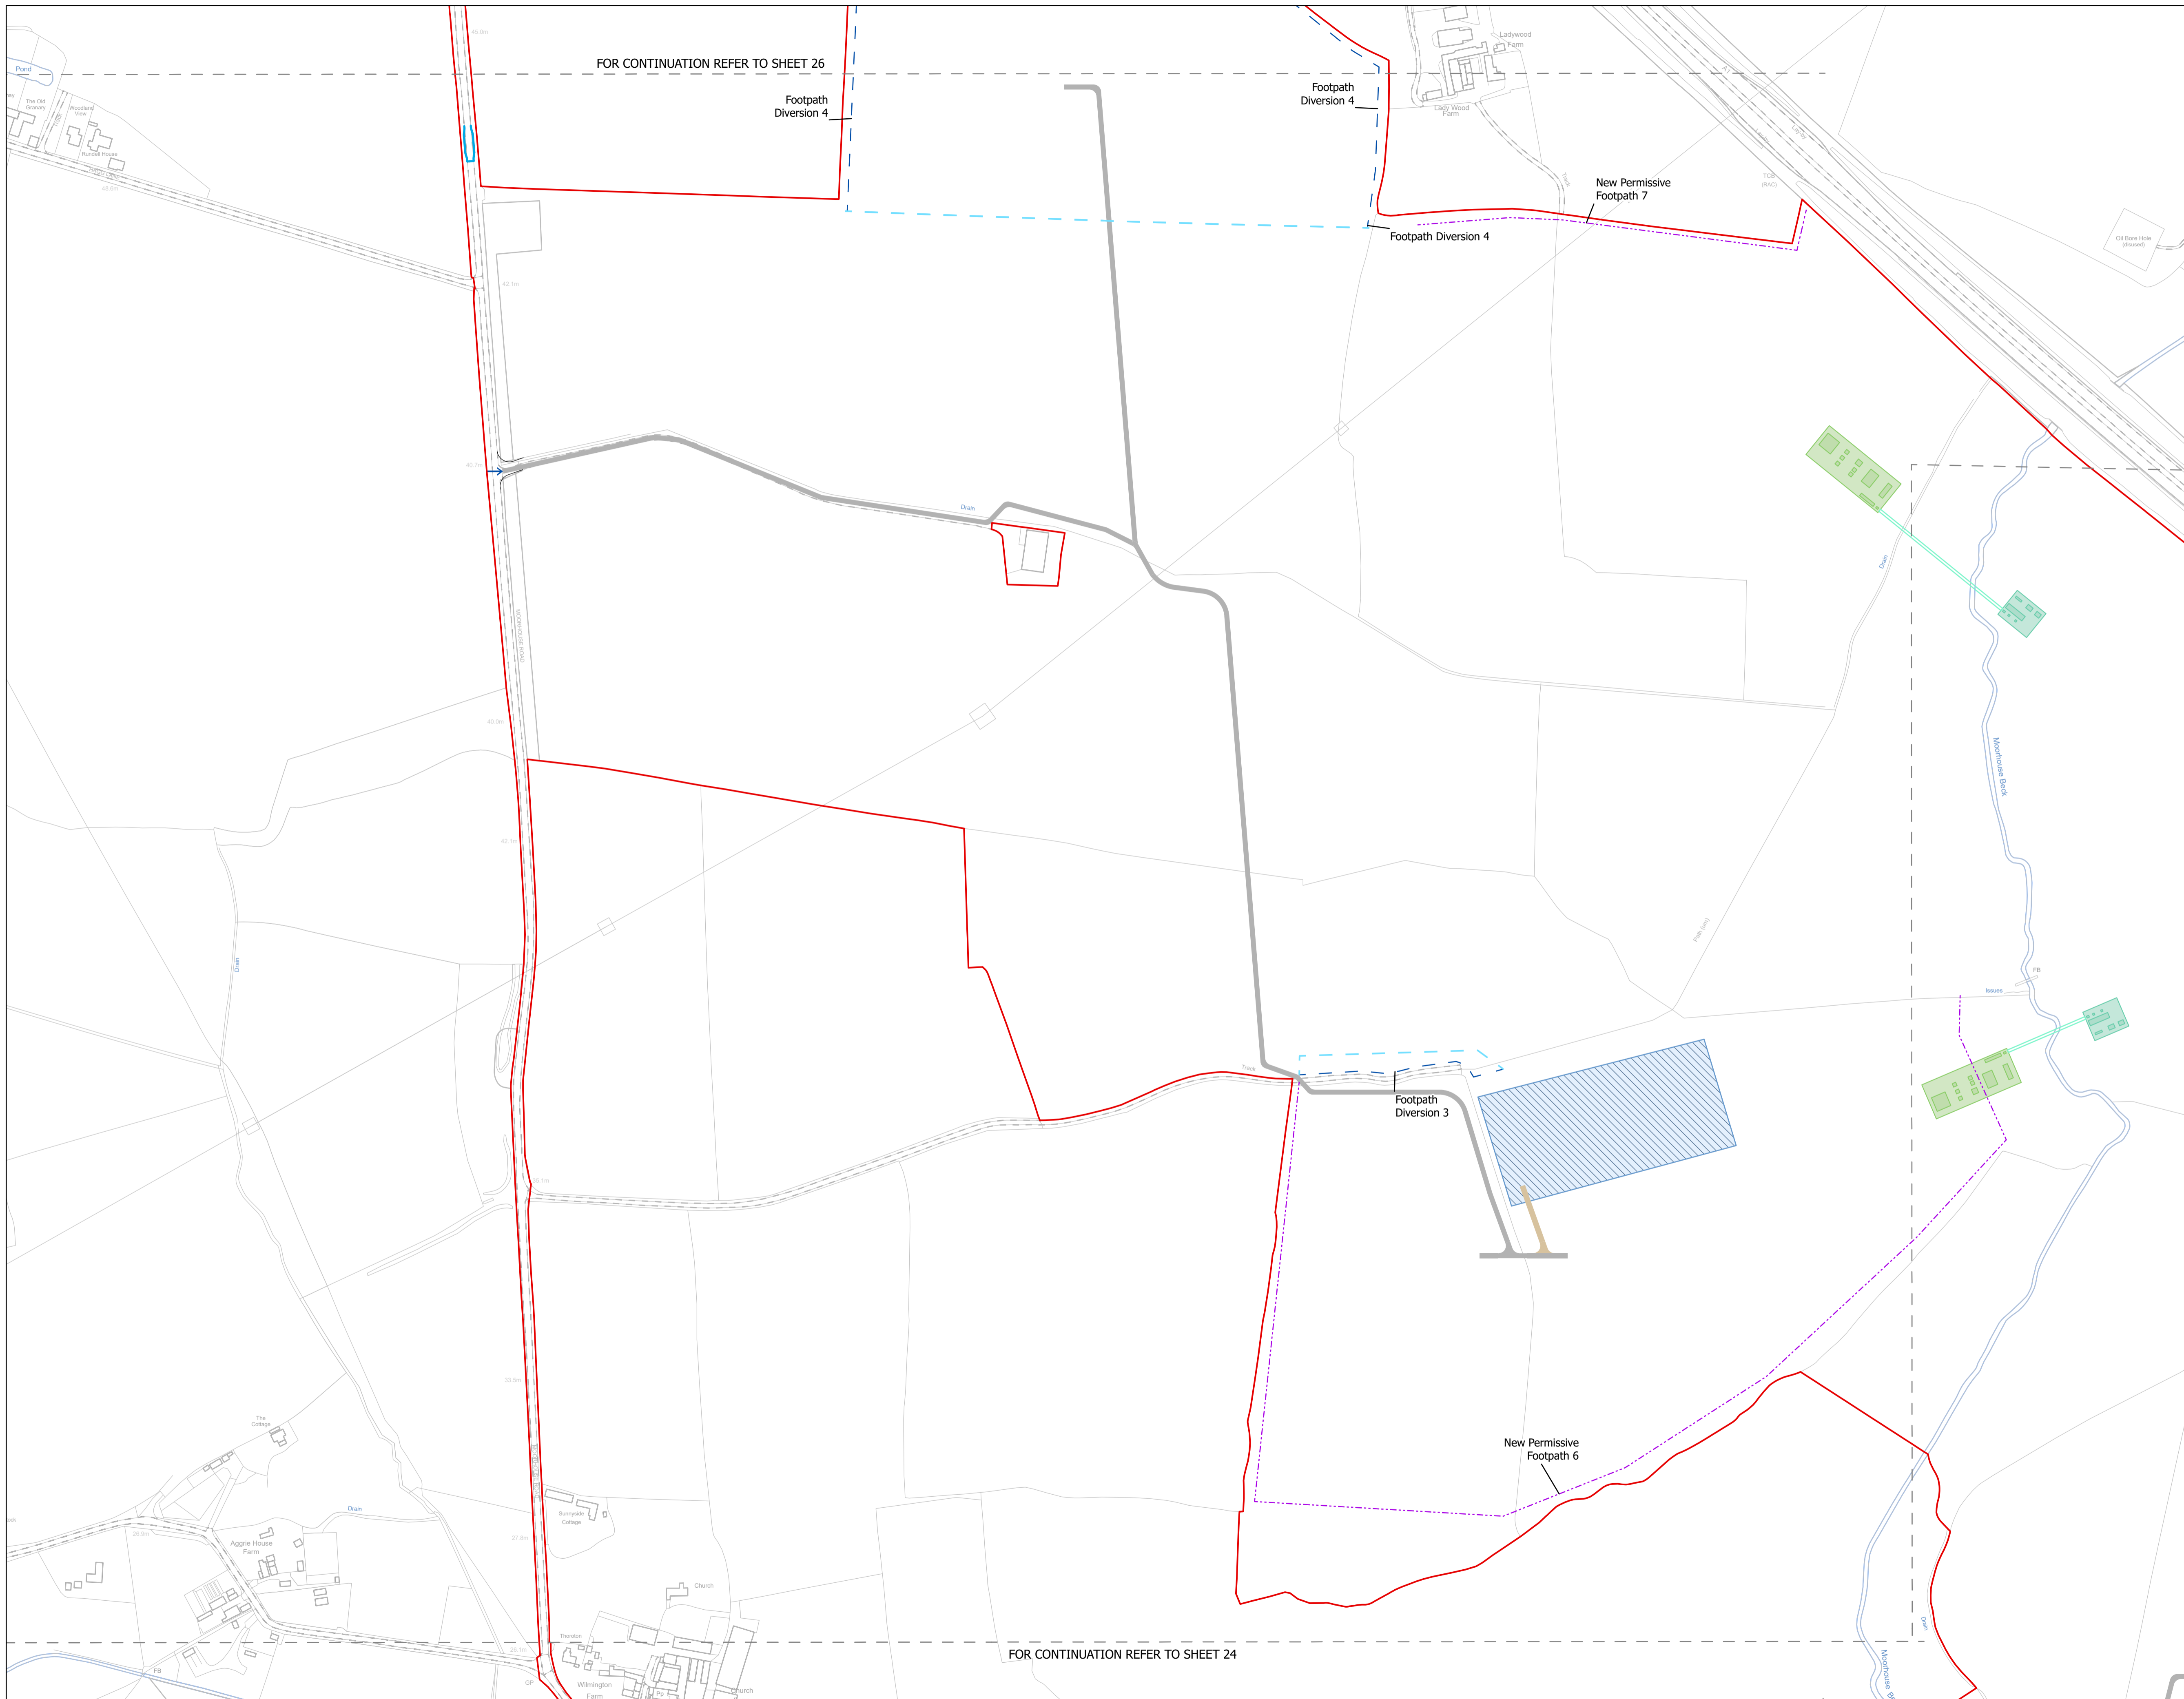


FOR CONTINUATION REFER TO SHEET 26

FOR CONTINUATION REFER TO SHEET 24

NOTES
1. ALL DIMENSIONS ARE IN METRES UNLESS STATED OTHERWISE.

- Legend**
- Order Limits
 - ↑ Construction Only Access Point
 - ↑ Maintenance and Construction Access Point
 - ↑ Maintenance Access and Construction Cross Over Point
 - Footpath Closure
 - Footpath Diversion
 - Bridleway Closed For Construction and Decommissioning
 - New Permissive Footpath
 - New Permissive Bridleway
 - Bridleway Diversion for Construction and Decommissioning
 - Access Bellmouth
 - Passing Places
 - HDD Connection Channel
 - HDD Compound Pull-Back Rig
 - HDD Compound Rig Side
 - Internal Tarmac Roads
 - Internal Stone Roads
 - Temporary Construction Roads
 - Main Compound Areas
 - Satellite Compound Areas

FOR CONTINUATION REFER TO SHEET 27
The Legend is identical on all sheets of the Illustrative Construction Layout and therefore not all items specified in the Legend are found on each sheet

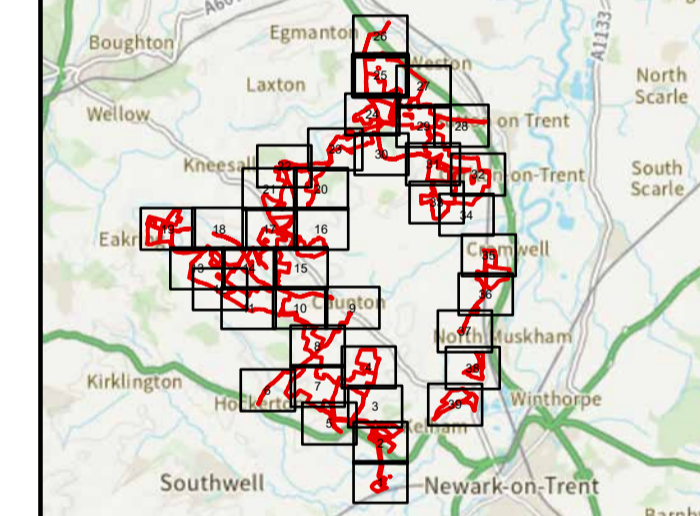

Revision 3	AD	LA	14/04/2026	Rev03
Revision 2	AD	LA	14/01/2026	Rev02
Revision 1	AD	LA	24/06/2025	Rev01
Revision Details	By	Check	Date	Suffix

Applicant: Elements Green Trent Limited

Solar & Biodiversity Park

Project Title:
GREAT NORTH ROAD SOLAR AND BIODIVERSITY PARK

Purpose of Issue:
DCO APPLICATION

Development Consent Order Number:
EN010162


Development Consent Order Drawing Number:
EN010162/APP/6.3.5.5B


Drawing Title:
Illustrative Construction Layout SHEET 25 of 39

Designed: AD	Drawn: AD	Checked: LA	Date: 14/04/2026
Internal Project Number: 026	Suitability: DCO Application		

Scale @ A1:
1:2,500

N	Rev: Rev03
---	---------------

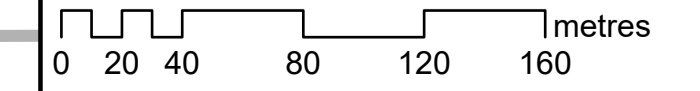

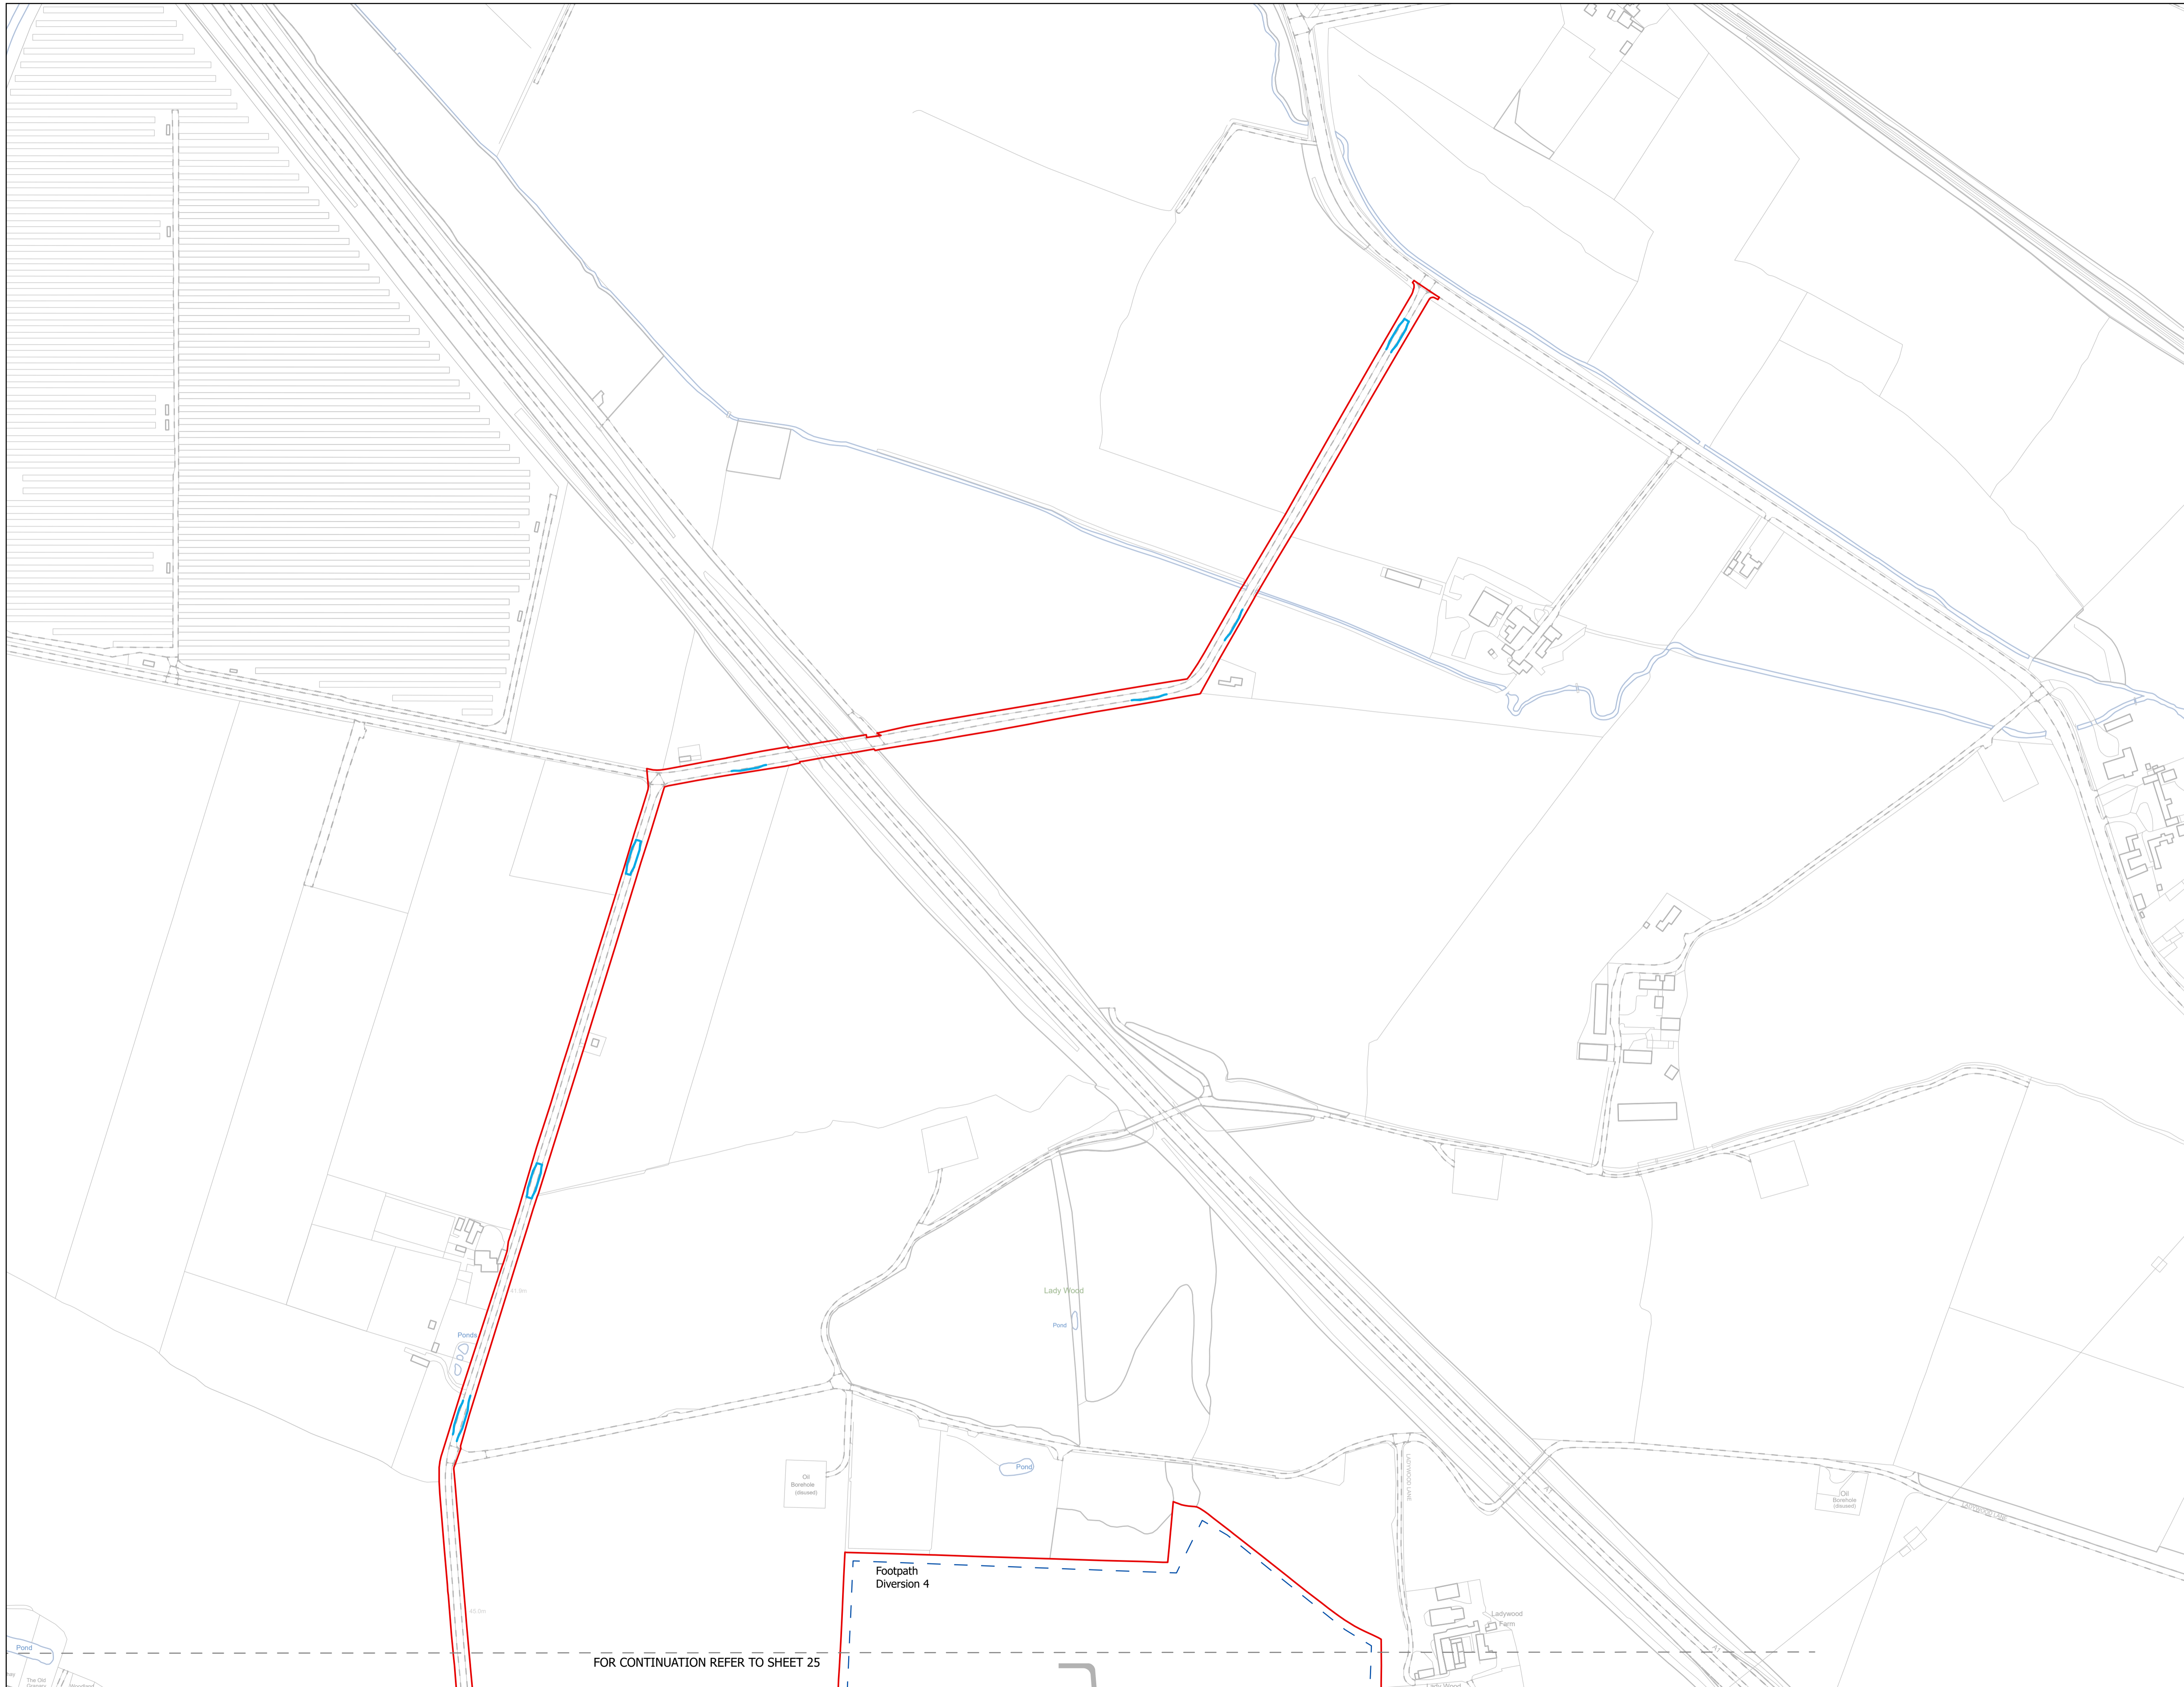


NOTES
1. ALL DIMENSIONS ARE IN METRES UNLESS STATED OTHERWISE.

Legend

- Order Limits
- ↑ Construction Only Access Point
- ↑ Maintenance and Construction Access Point
- ↑ Maintenance Access and Construction Cross Over Point
- Footpath Closure
- Footpath Diversion
- - - Bridleway Closed For Construction and Decommissioning
- - - New Permissive Footpath
- - - New Permissive Bridleway
- Bridleway Diversion for Construction and Decommissioning
- Access Bellmouth
- Passing Places
- HDD Connection Channel
- HDD Compound Pull-Back Rig
- HDD Compound Rig Side
- Internal Tarmac Roads
- Internal Stone Roads
- Temporary Construction Roads
- Main Compound Areas
- Satellite Compound Areas

The Legend is identical on all sheets of the Illustrative Construction Layout and therefore not all items specified in the Legend are found on each sheet

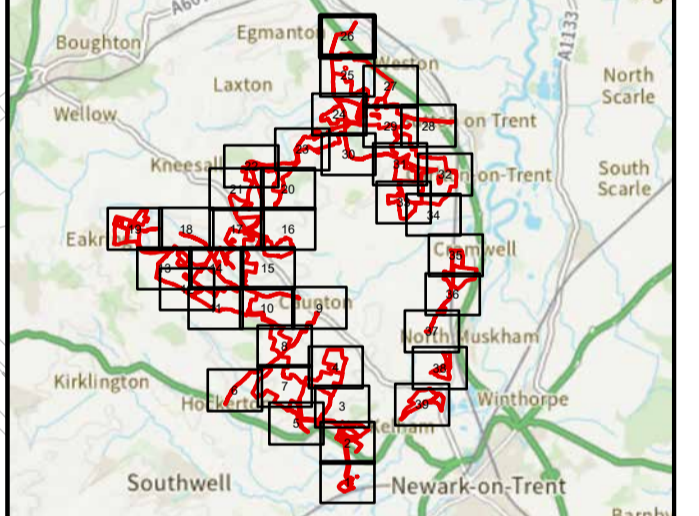

Revision 3	AD	LA	14/04/2026	Rev03
Revision 2	AD	LA	14/01/2026	Rev02
Revision 1	AD	LA	24/06/2025	Rev01
Revision Details	By	Check	Date	Suffix

Applicant: Elements Green Trent Limited

Solar & Biodiversity Park

Project Title:
GREAT NORTH ROAD SOLAR AND BIODIVERSITY PARK

Purpose of Issue:
DCO APPLICATION

Development Consent Order Number:
EN010162

Development Consent Order Drawing Number:
EN010162/APP/6.3.5.5B

Drawing Title:
Illustrative Construction Layout SHEET 26 of 39

Designed: AD	Drawn: AD	Checked: LA	Date: 14/04/2026
Internal Project Number: 026	Suitability: DCO Application		

Scale @ A1:
1:2,500


North arrow pointing up.

Rev: **Rev03**

Scale bar: 0 20 40 80 120 160 metres

FOR CONTINUATION REFER TO SHEET 25


Footpath Diversion 4

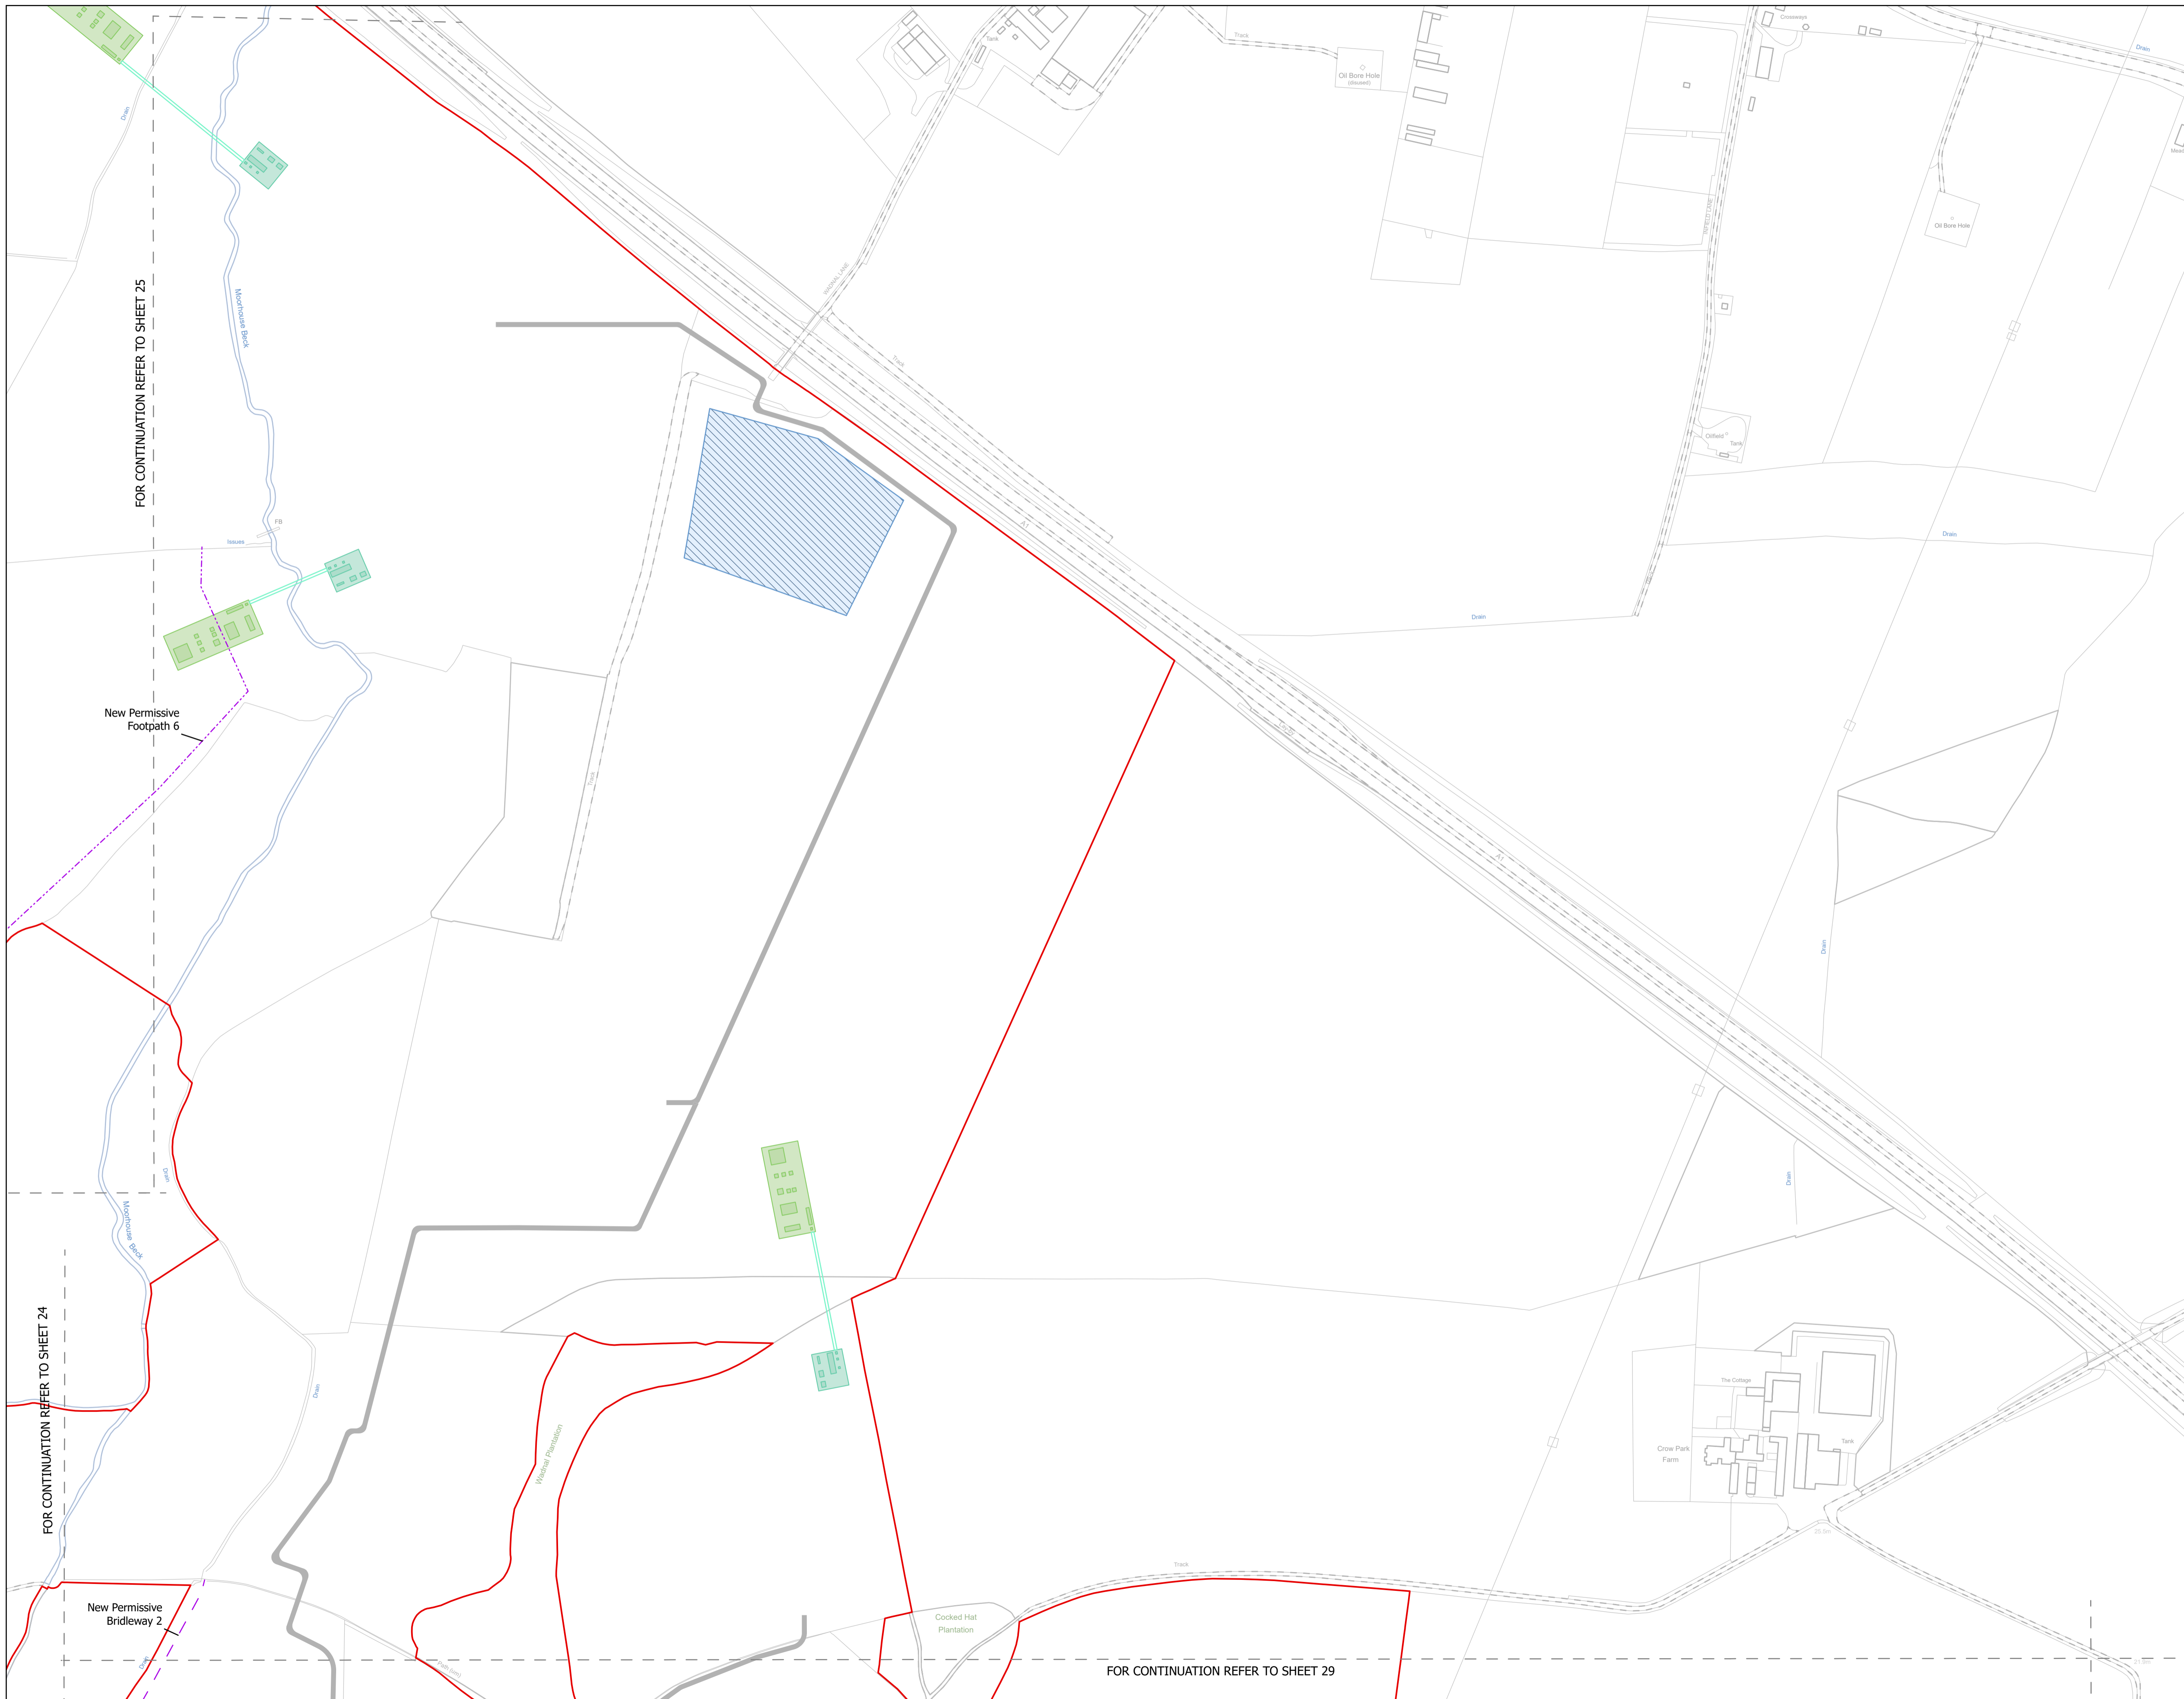

NOTES
1. ALL DIMENSIONS ARE IN METRES UNLESS STATED OTHERWISE.

- Legend**
- Order Limits
 - ↑ Construction Only Access Point
 - ↑ Maintenance and Construction Access Point
 - ↑ Maintenance Access and Construction Cross Over Point
 - - - Footpath Closure
 - - - Footpath Diversion
 - - - Bridleway Closed For Construction and Decommissioning
 - - - New Permissive Footpath
 - - - New Permissive Bridleway
 - - - Bridleway Diversion for Construction and Decommissioning
 - - - Access Bellmouth
 - - - Passing Places
 - - - HDD Connection Channel
 - HDD Compound Pull-Back Rig
 - HDD Compound Rig Side
 - Internal Tarmac Roads
 - Internal Stone Roads
 - Temporary Construction Roads
 - Main Compound Areas
 - Satellite Compound Areas

The Legend is identical on all sheets of the Illustrative Construction Layout and therefore not all items specified in the Legend are found on each sheet

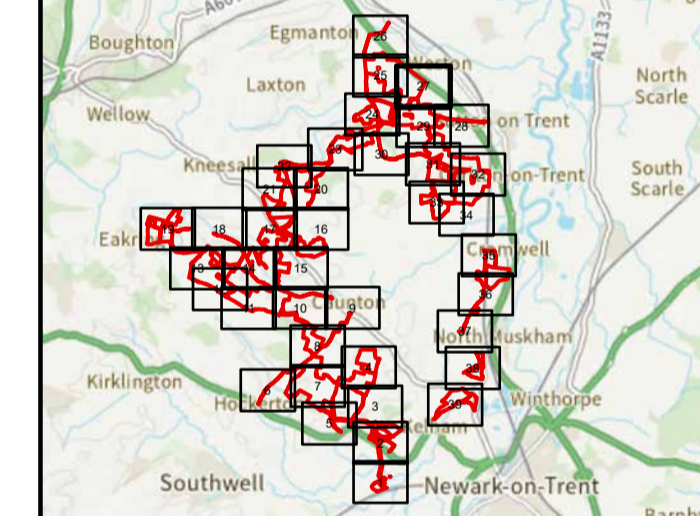

Revision 3	AD	LA	14/04/2026	Rev03
Revision 2	AD	LA	14/01/2026	Rev02
Revision 1	AD	LA	24/06/2025	Rev01
Revision Details	By	Check	Date	Suffix



Project Title:
GREAT NORTH ROAD SOLAR AND BIODIVERSITY PARK

Purpose of Issue:
DCO APPLICATION

Development Consent Order Number:
EN010162


Development Consent Order Drawing Number:
EN010162/APP/6.3.5.5B


Drawing Title:
Illustrative Construction Layout SHEET 27 of 39

Designed: AD	Drawn: AD	Checked: LA	Date: 14/04/2026
Internal Project Number: 026		Suitability: DCO Application	

Scale @ A1:
1:2,500

N	Rev: Rev03
---	---------------

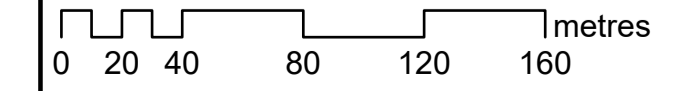

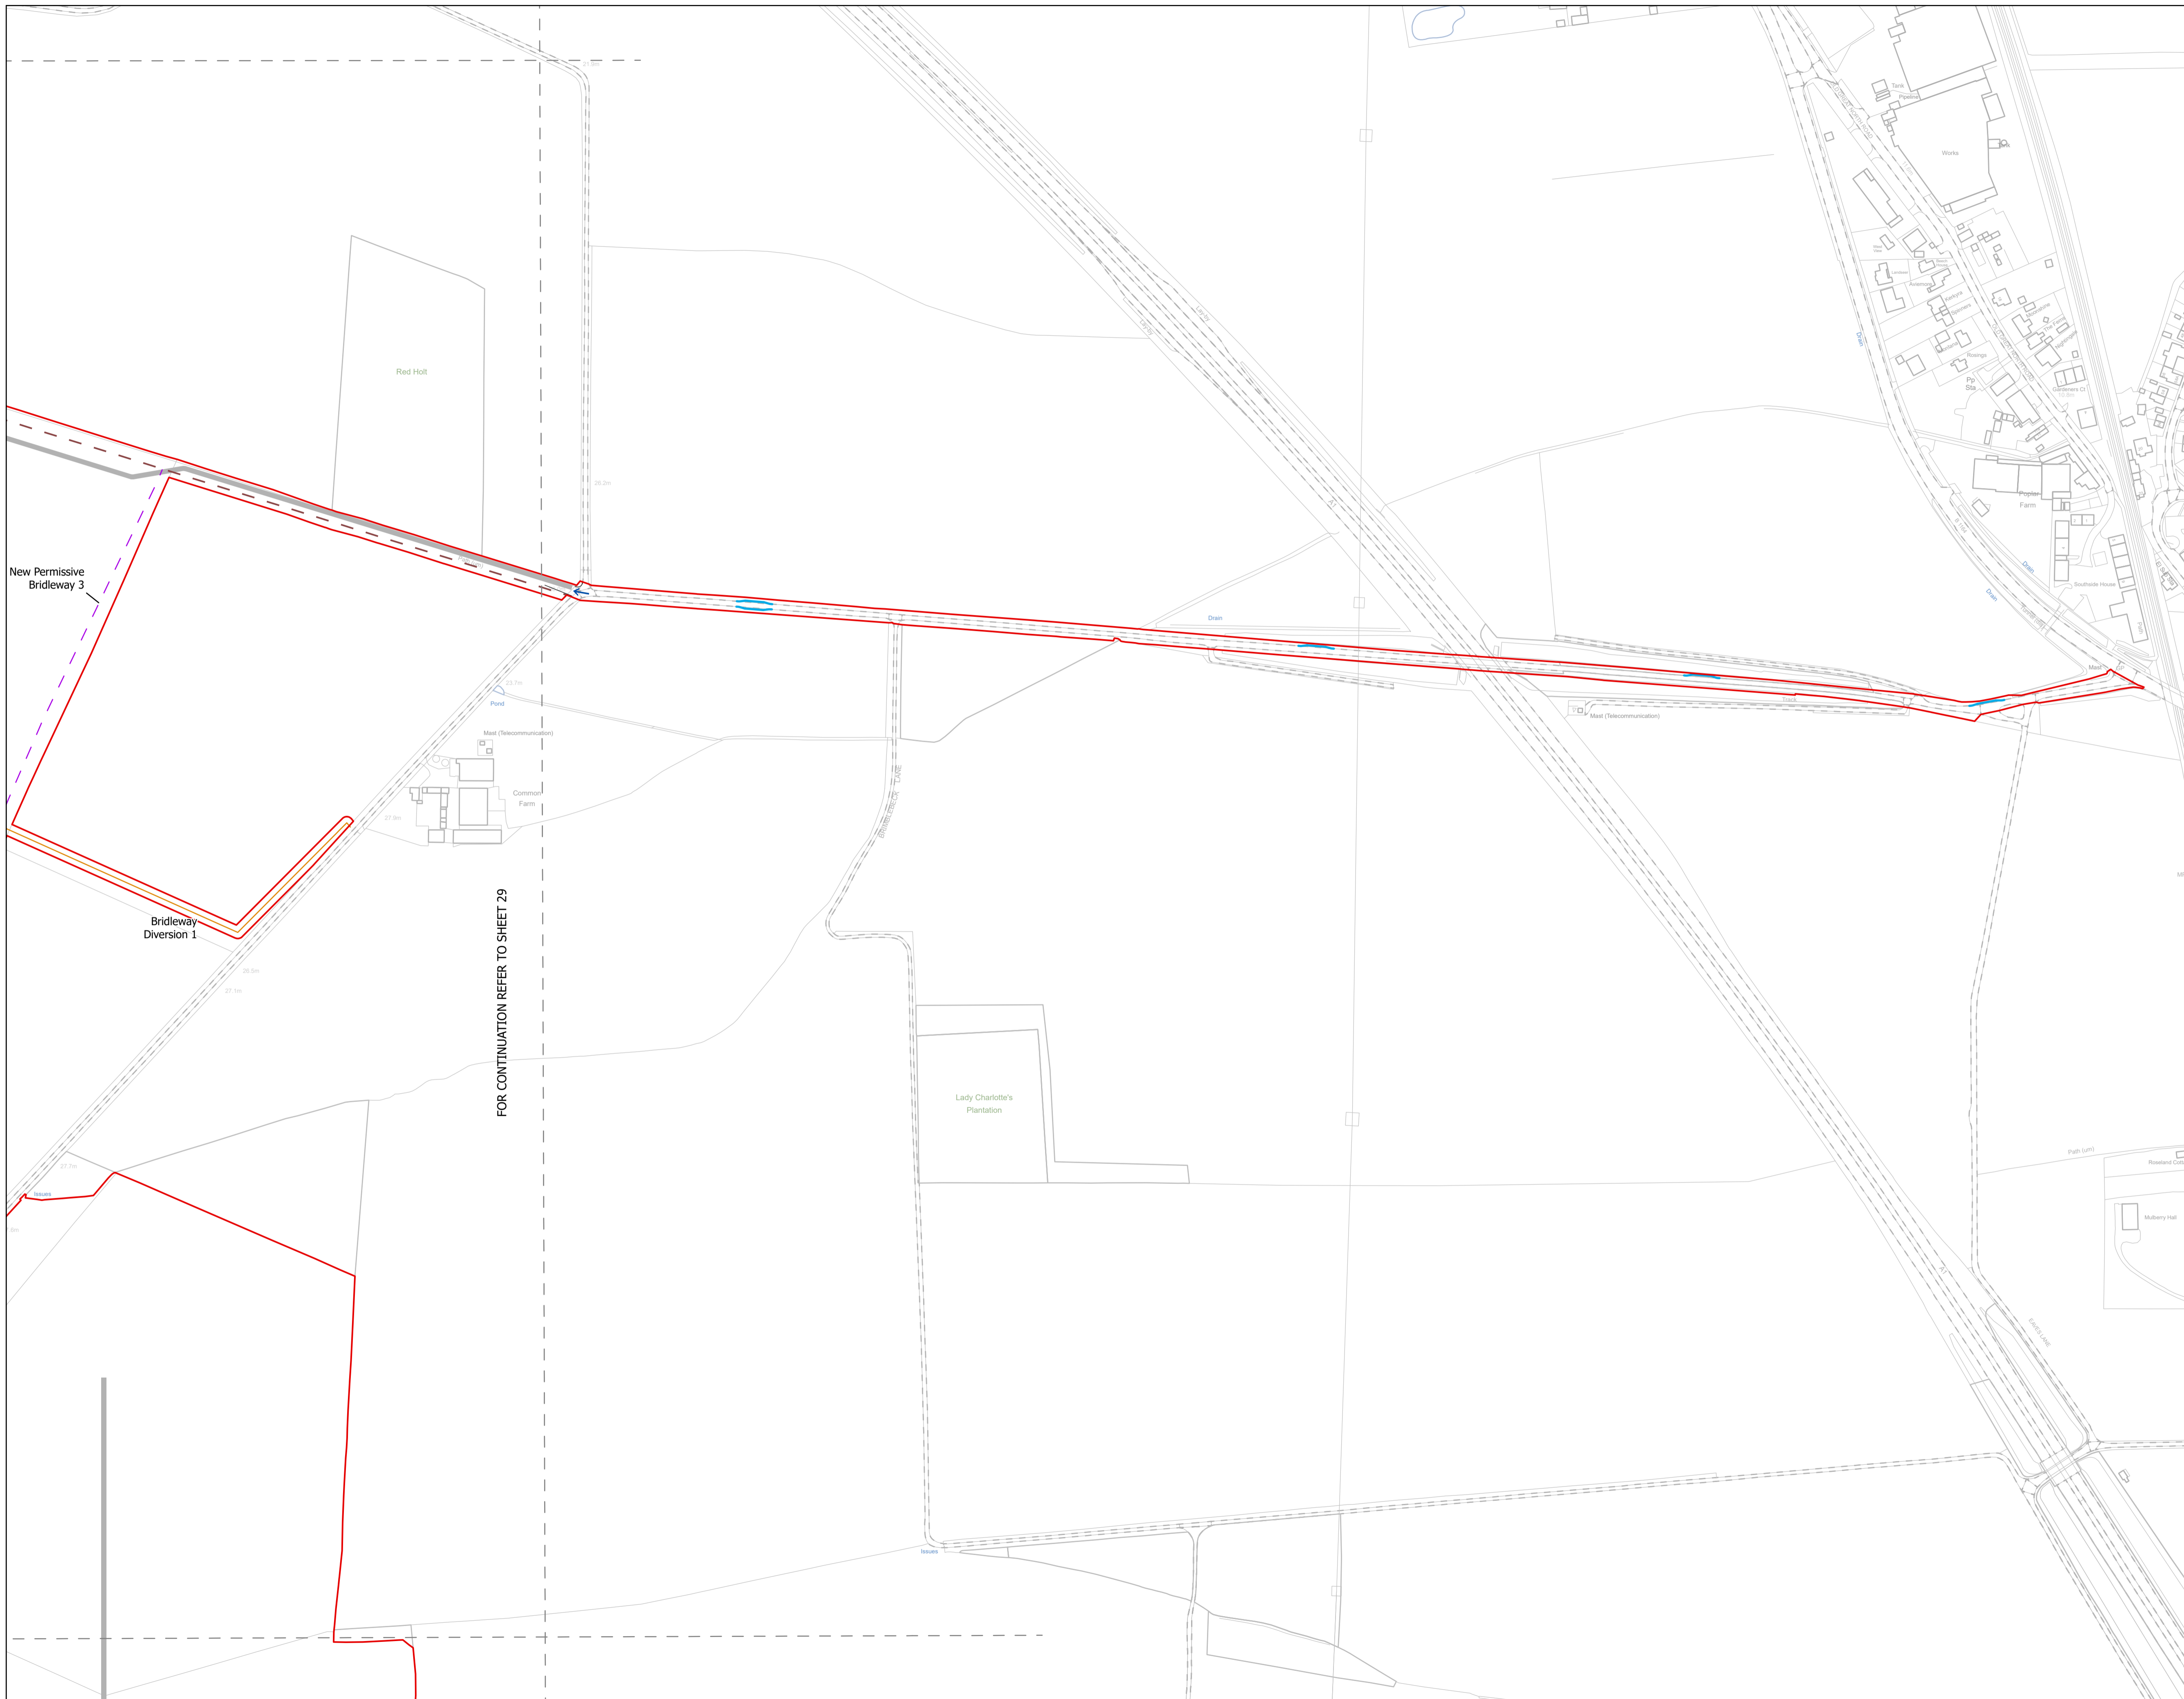


FOR CONTINUATION REFER TO SHEET 29

NOTES
1. ALL DIMENSIONS ARE IN METRES UNLESS STATED OTHERWISE.

- Legend**
- Order Limits
 - Construction Only Access Point
 - Maintenance and Construction Access Point
 - Maintenance Access and Construction Cross Over Point
 - Footpath Closure
 - Footpath Diversion
 - Bridleway Closed For Construction and Decommissioning
 - New Permissive Footpath
 - New Permissive Bridleway
 - Bridleway Diversion for Construction and Decommissioning
 - Access Bellmouth
 - Passing Places
 - HDD Connection Channel
 - HDD Compound Pull-Back Rig
 - HDD Compound Rig Side
 - Internal Tarmac Roads
 - Internal Stone Roads
 - Temporary Construction Roads
 - Main Compound Areas
 - Satellite Compound Areas

The Legend is identical on all sheets of the Illustrative Construction Layout and therefore not all items specified in the Legend are found on each sheet

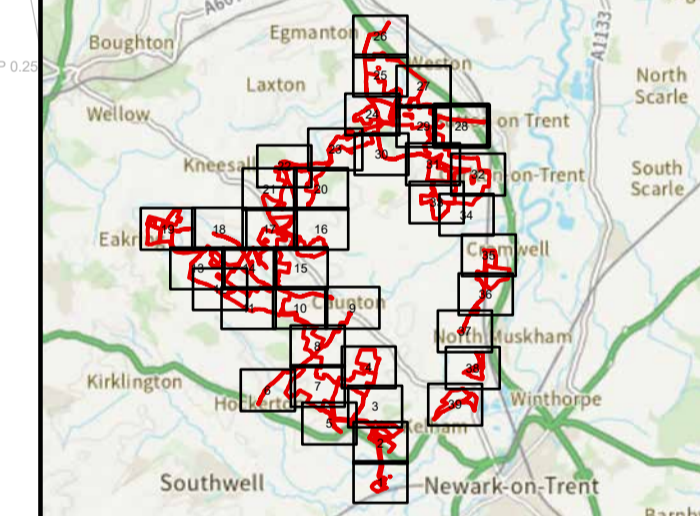

Revision 3	AD	LA	14/04/2026	Rev03
Revision 2	AD	LA	14/01/2026	Rev02
Revision 1	AD	LA	24/06/2025	Rev01
Revision Details	By	Check	Date	Suffix

Applicant: Elements Green Trent Limited

Solar & Biodiversity Park

Project Title:
GREAT NORTH ROAD SOLAR AND BIODIVERSITY PARK

Purpose of Issue:
DCO APPLICATION

Development Consent Order Number:
EN010162

Development Consent Order Drawing Number:
EN010162/APP/6.3.5.5B


Drawing Title:
Illustrative Construction Layout SHEET 28 of 39


Designed: AD	Drawn: AD	Checked: LA	Date: 14/04/2026
Internal Project Number: 026		Suitability: DCO Application	

Scale @ A1:
1:2,500

N

Rev:
Rev03

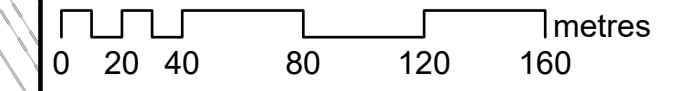

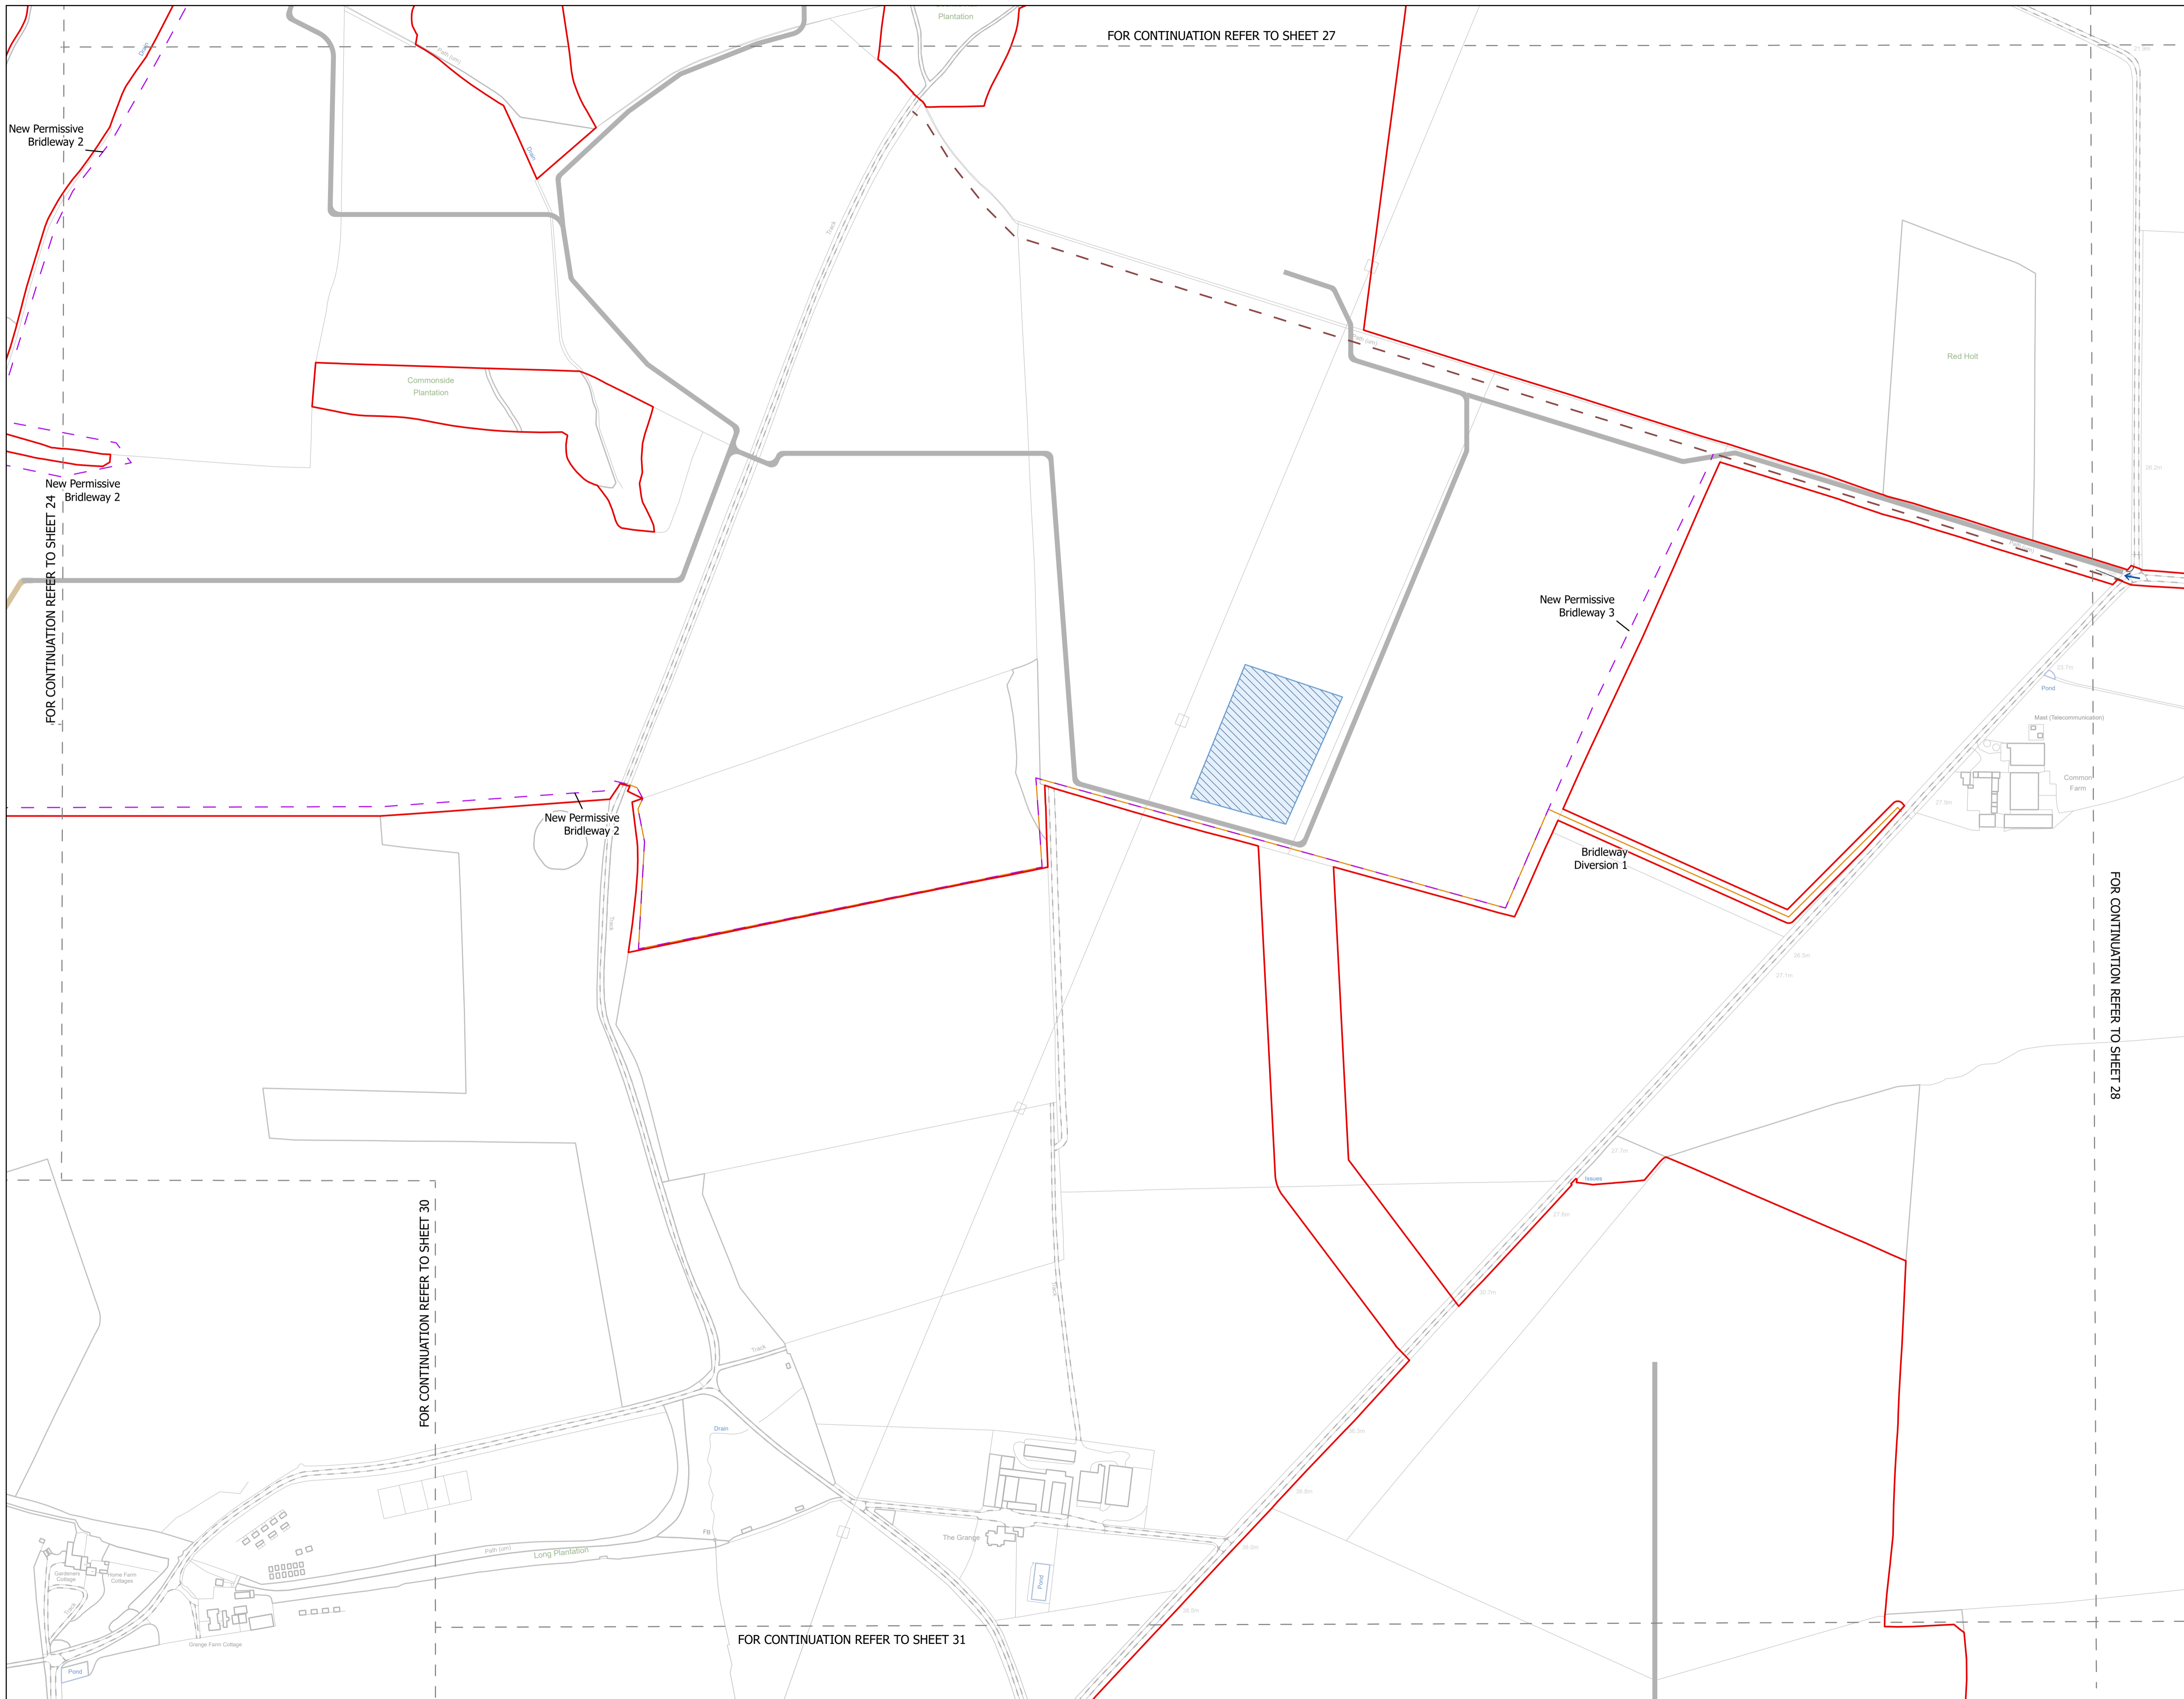


NOTES
1. ALL DIMENSIONS ARE IN METRES UNLESS STATED OTHERWISE.

Legend

- Order Limits
- ↑ Construction Only Access Point
- ↑ Maintenance and Construction Access Point
- ↑ Maintenance Access and Construction Cross Over Point
- Footpath Closure
- Footpath Diversion
- Bridleway Closed For Construction and Decommissioning
- New Permissive Footpath
- New Permissive Bridleway
- Bridleway Diversion for Construction and Decommissioning
- Access Bellmouth
- Passing Places
- HDD Connection Channel
- HDD Compound Pull-Back Rig
- HDD Compound Rig Side
- Internal Tarmac Roads
- Internal Stone Roads
- Temporary Construction Roads
- Main Compound Areas
- Satellite Compound Areas

The Legend is identical on all sheets of the Illustrative Construction Layout and therefore not all items specified in the Legend are found on each sheet

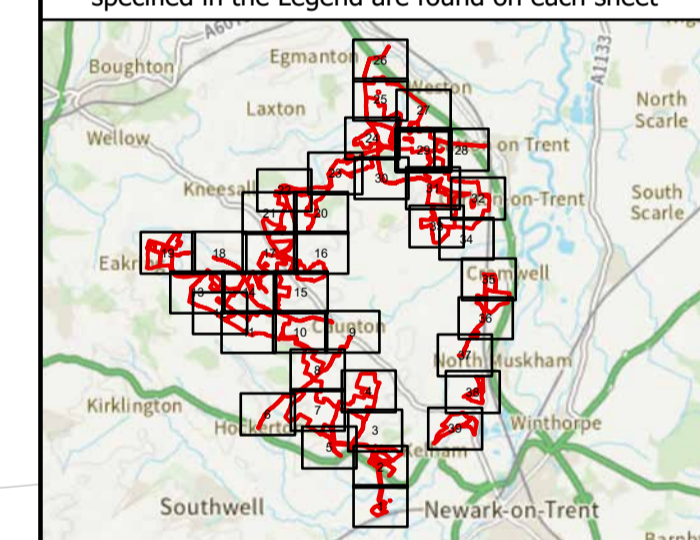

Revision 3	AD	LA	14/04/2026	Rev03
Revision 2	AD	LA	14/01/2026	Rev02
Revision 1	AD	LA	24/06/2025	Rev01
Revision Details	By	Check	Date	Suffix

Applicant: Elements Green Trent Limited

Solar & Biodiversity Park

Project Title:
GREAT NORTH ROAD SOLAR AND BIODIVERSITY PARK

Purpose of Issue:
DCO APPLICATION

Development Consent Order Number:
EN010162

Development Consent Order Drawing Number:
EN010162/APP/6.3.5.5B


Drawing Title:
Illustrative Construction Layout SHEET 29 of 39

Designed: AD	Drawn: AD	Checked: LA	Date: 14/04/2026
Internal Project Number: 026		Suitability: DCO Application	
Scale @ A1: 1:2,500			

North arrow pointing up.

Revision: **Rev03**


Scale bar: 0, 20, 40, 80, 120, 160 metres

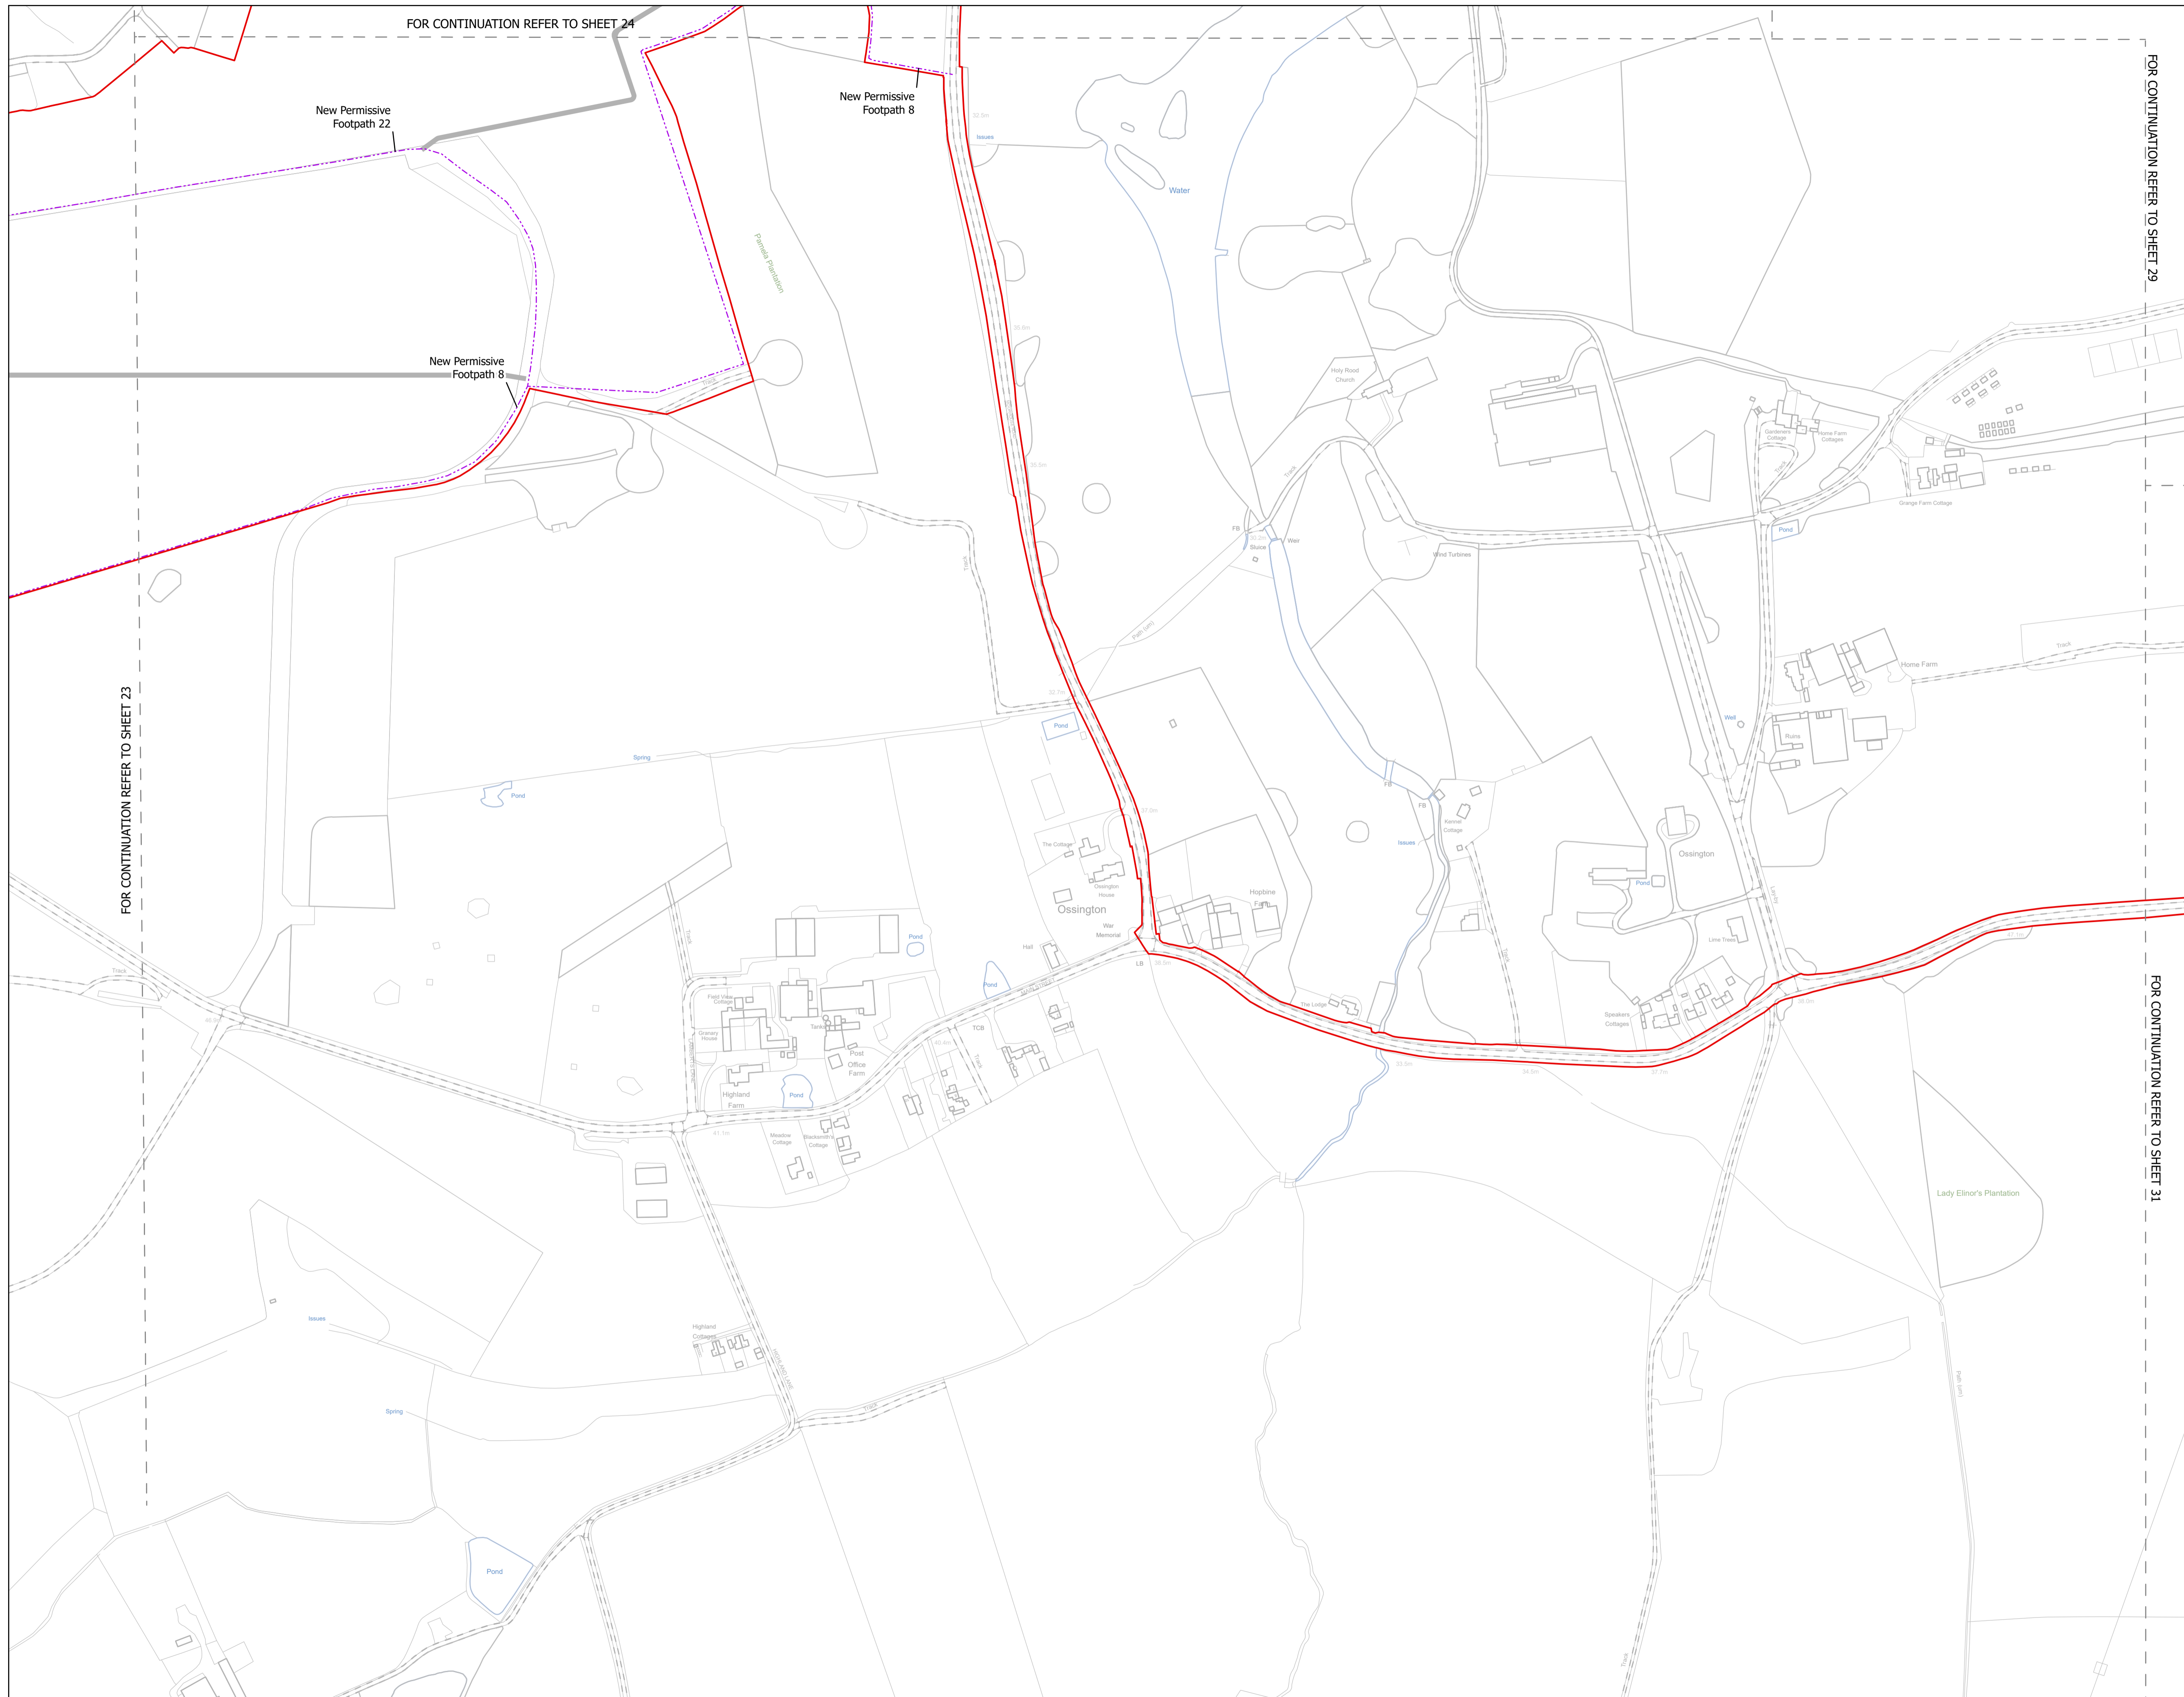

NOTES
1. ALL DIMENSIONS ARE IN METRES UNLESS STATED OTHERWISE.

- Legend**
- Order Limits
 - ↑ Construction Only Access Point
 - ↑ Maintenance and Construction Access Point
 - ↑ Maintenance Access and Construction Cross Over Point
 - Footpath Closure
 - Footpath Diversion
 - Bridleway Closed For Construction and Decommissioning
 - New Permissive Footpath
 - New Permissive Bridleway
 - Bridleway Diversion for Construction and Decommissioning
 - Access Bellmouth
 - Passing Places
 - HDD Connection Channel
 - HDD Compound Pull-Back Rig
 - HDD Compound Rig Side
 - Internal Tarmac Roads
 - Internal Stone Roads
 - Temporary Construction Roads
 - Main Compound Areas
 - Satellite Compound Areas

The Legend is identical on all sheets of the Illustrative Construction Layout and therefore not all items specified in the Legend are found on each sheet

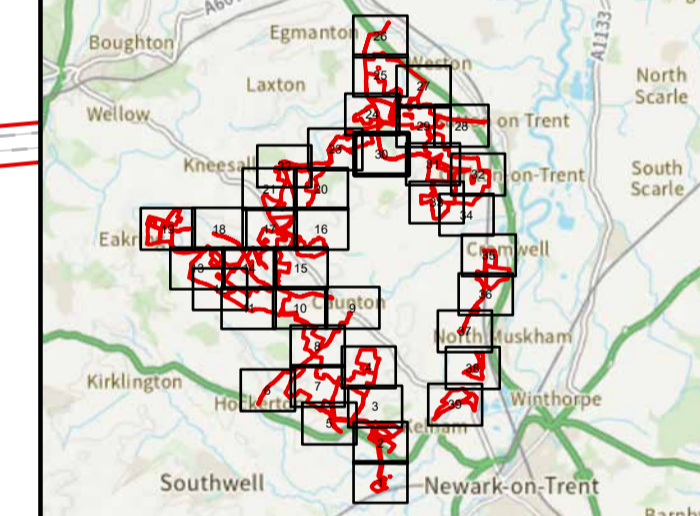

Revision 3	AD	LA	14/04/2026	Rev03
Revision 2	AD	LA	14/01/2026	Rev02
Revision 1	AD	LA	24/06/2025	Rev01
Revision Details	By	Check	Date	Suffix

Applicant: Elements Green Trent Limited

Project Title:
GREAT NORTH ROAD SOLAR AND BIODIVERSITY PARK

Purpose of Issue:
DCO APPLICATION

Development Consent Order Number:
EN010162

Development Consent Order Drawing Number:
EN010162/APP/6.3.5.5B


Drawing Title:
Illustrative Construction Layout SHEET 30 of 39

Designed: AD	Drawn: AD	Checked: LA	Date: 14/04/2026
Internal Project Number: 026		Suitability: DCO Application	
Scale @ A1: 1:2,500			

North arrow pointing up.

Revision: **Rev03**

Scale bar: 0, 20, 40, 80, 120, 160 metres

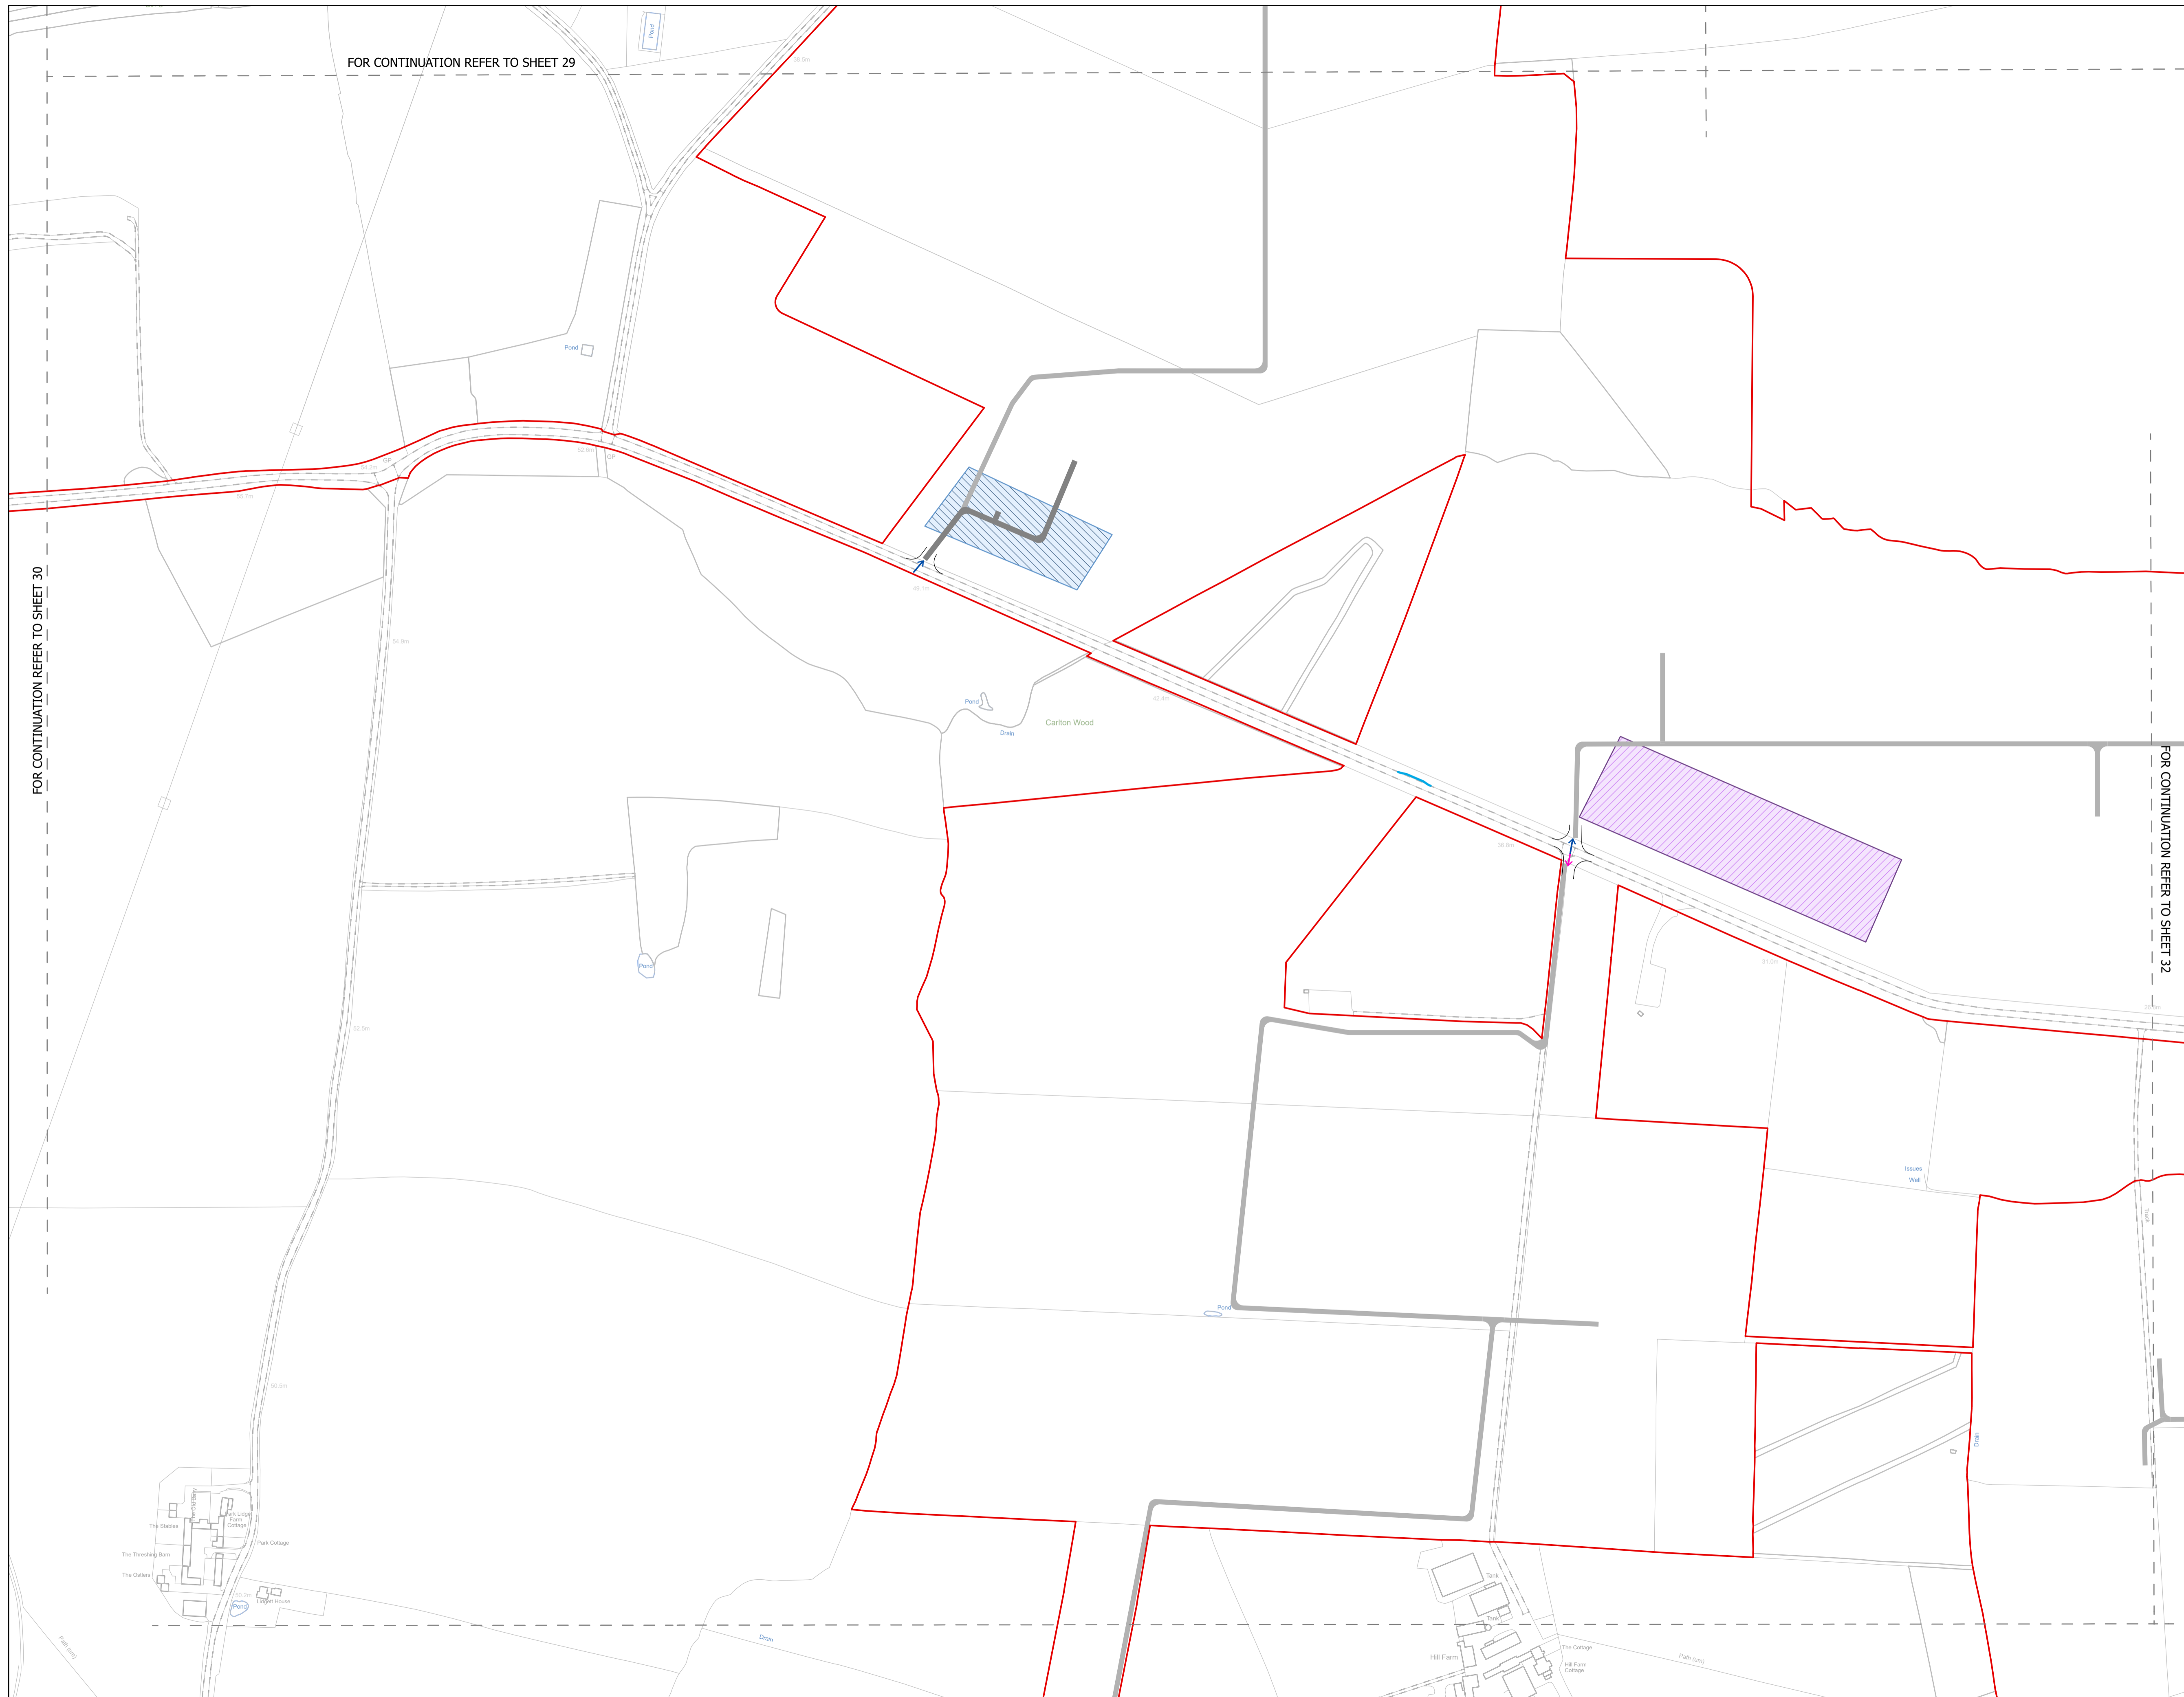

FOR CONTINUATION REFER TO SHEET 29

FOR CONTINUATION REFER TO SHEET 30


FOR CONTINUATION REFER TO SHEET 32

NOTES
1. ALL DIMENSIONS ARE IN METRES UNLESS STATED OTHERWISE.

Legend

- Order Limits
- ↑ Construction Only Access Point
- ↑ Maintenance and Construction Access Point
- ↑ Maintenance Access and Construction Cross Over Point
- Footpath Closure
- Footpath Diversion
- Bridleway Closed For Construction and Decommissioning
- New Permissive Footpath
- New Permissive Bridleway
- Bridleway Diversion for Construction and Decommissioning
- Access Bellmouth
- Passing Places
- HDD Connection Channel
- HDD Compound Pull-Back Rig
- HDD Compound Rig Side
- Internal Tarmac Roads
- Internal Stone Roads
- Temporary Construction Roads
- Main Compound Areas
- Satellite Compound Areas

The Legend is identical on all sheets of the Illustrative Construction Layout and therefore not all items specified in the Legend are found on each sheet

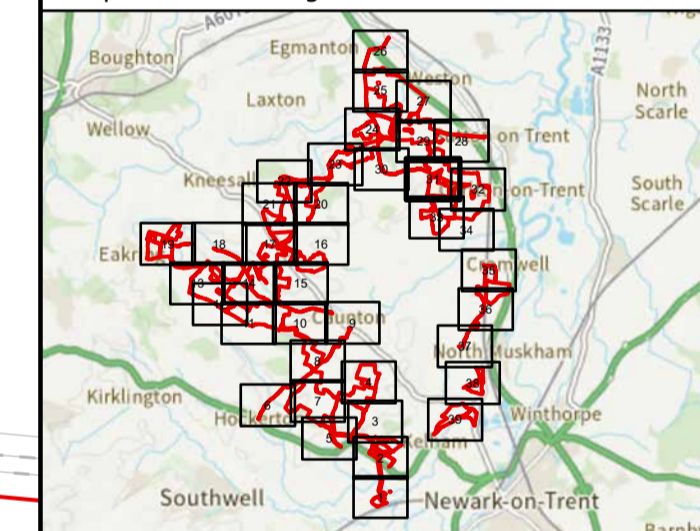

Revision 3	AD	LA	14/04/2026	Rev03
Revision 2	AD	LA	14/01/2026	Rev02
Revision 1	AD	LA	24/06/2025	Rev01
Revision Details	By	Check	Date	Suffix

Applicant: Elements Green Trent Limited



Project Title:
GREAT NORTH ROAD SOLAR AND BIODIVERSITY PARK

Purpose of Issue:
DCO APPLICATION

Development Consent Order Number:
EN010162

Development Consent Order Drawing Number:
EN010162/APP/6.3.5.5B

Drawing Title:
Illustrative Construction Layout SHEET 31 of 39


Designed: AD	Drawn: AD	Checked: LA	Date: 14/04/2026
-----------------	--------------	----------------	---------------------


Internal Project Number:
026

Suitability:
DCO Application

Scale @ A1:
1:2,500

N	Rev: Rev03
---	---------------

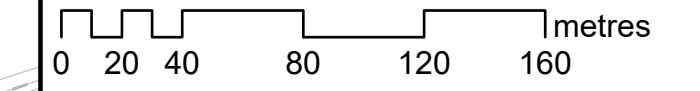

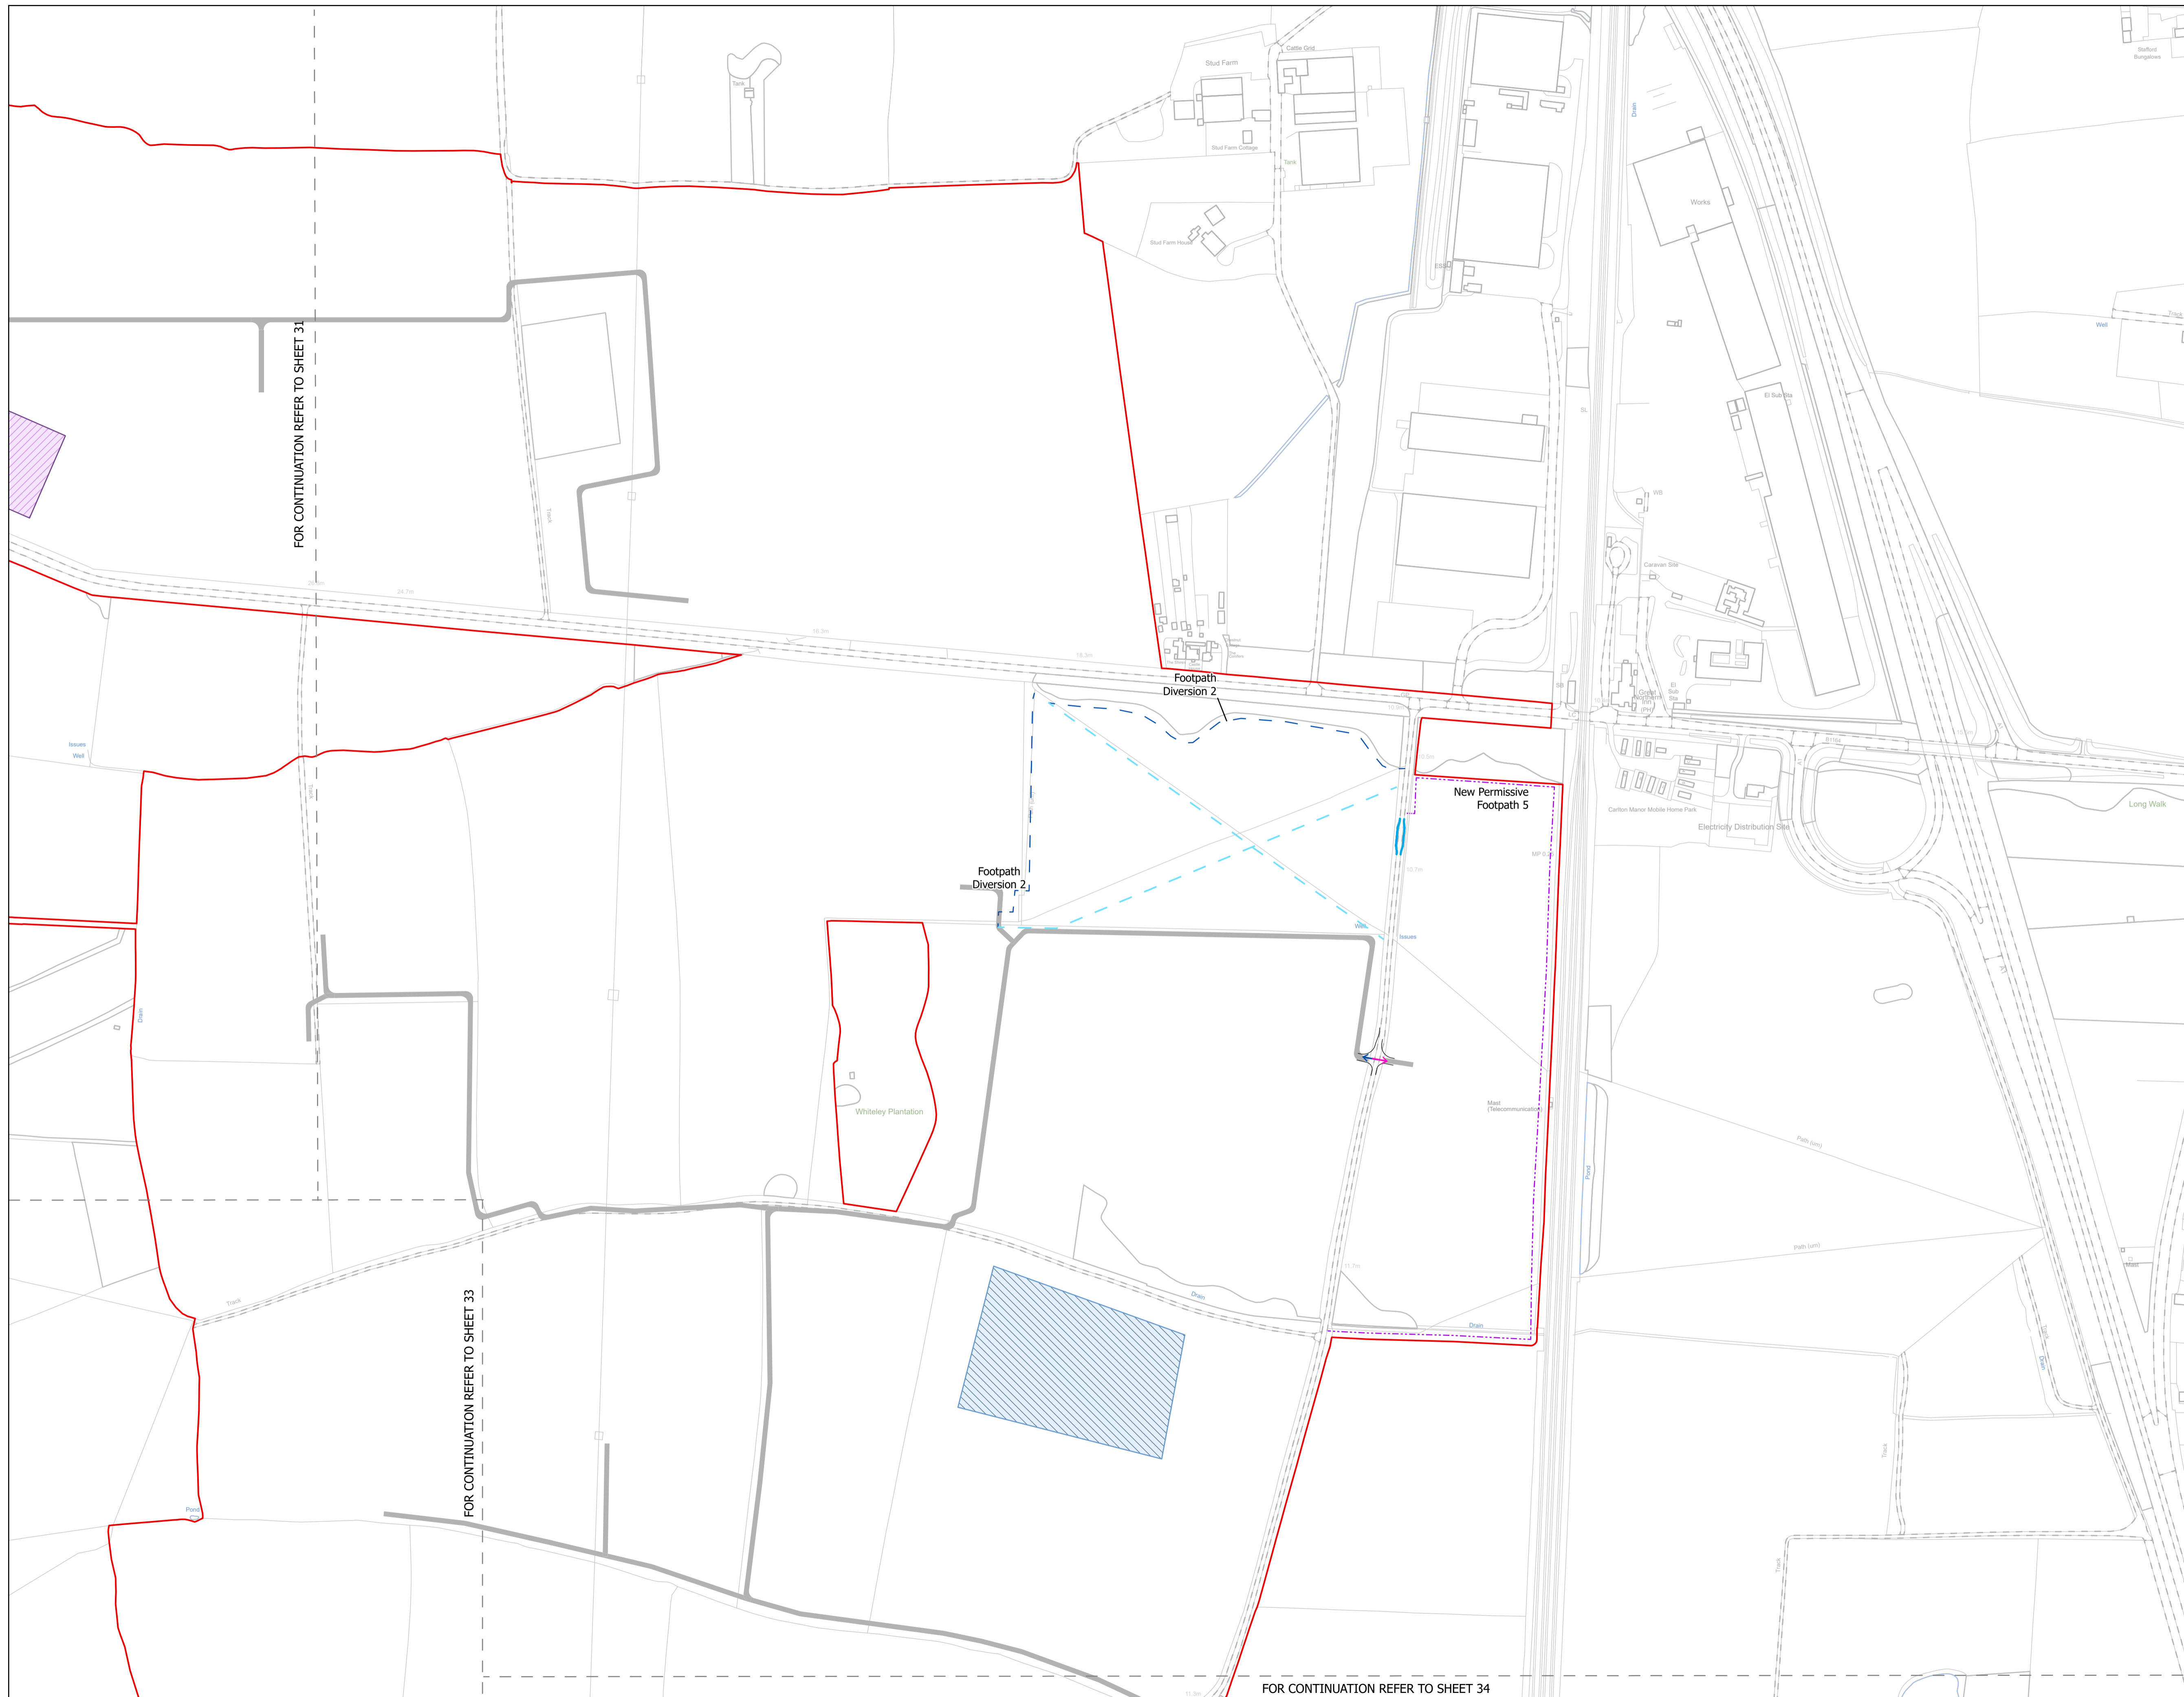

FOR CONTINUATION REFER TO SHEET 31

FOR CONTINUATION REFER TO SHEET 33


FOR CONTINUATION REFER TO SHEET 34

NOTES
1. ALL DIMENSIONS ARE IN METRES UNLESS STATED OTHERWISE.

Legend

- Order Limits
- ↑ Construction Only Access Point
- ↑ Maintenance and Construction Access Point
- ↑ Maintenance Access and Construction Cross Over Point
- Footpath Closure
- - - Footpath Diversion
- - - Bridleway Closed For Construction and Decommissioning
- - - New Permissive Footpath
- - - New Permissive Bridleway
- - - Bridleway Diversion for Construction and Decommissioning
- Access Bellmouth
- Passing Places
- HDD Connection Channel
- HDD Compound Pull-Back Rig
- HDD Compound Rig Side
- Internal Tarmac Roads
- Internal Stone Roads
- Temporary Construction Roads
- Main Compound Areas
- Satellite Compound Areas

The Legend is identical on all sheets of the Illustrative Construction Layout and therefore not all items specified in the Legend are found on each sheet

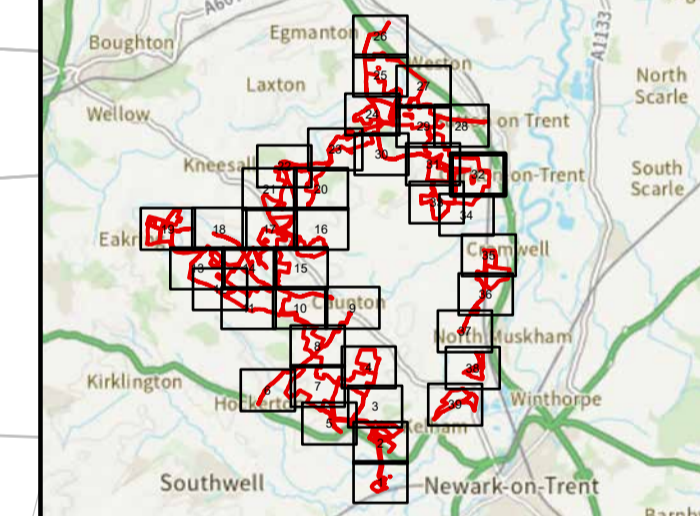

Revision 3	AD	LA	14/04/2026	Rev03
Revision 2	AD	LA	14/01/2026	Rev02
Revision 1	AD	LA	24/06/2025	Rev01
Revision Details	By	Check	Date	Suffix



Project Title:
GREAT NORTH ROAD SOLAR AND BIODIVERSITY PARK

Purpose of Issue:
DCO APPLICATION


Development Consent Order Number:
EN010162


Development Consent Order Drawing Number:
EN010162/APP/6.3.5.5B

Drawing Title:
Illustrative Construction Layout SHEET 32 of 39

Designed: AD	Drawn: AD	Checked: LA	Date: 14/04/2026
Internal Project Number: 026	Suitability: DCO Application		

Scale @ A1:
1:2,500

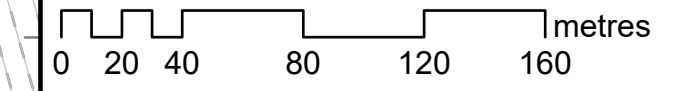

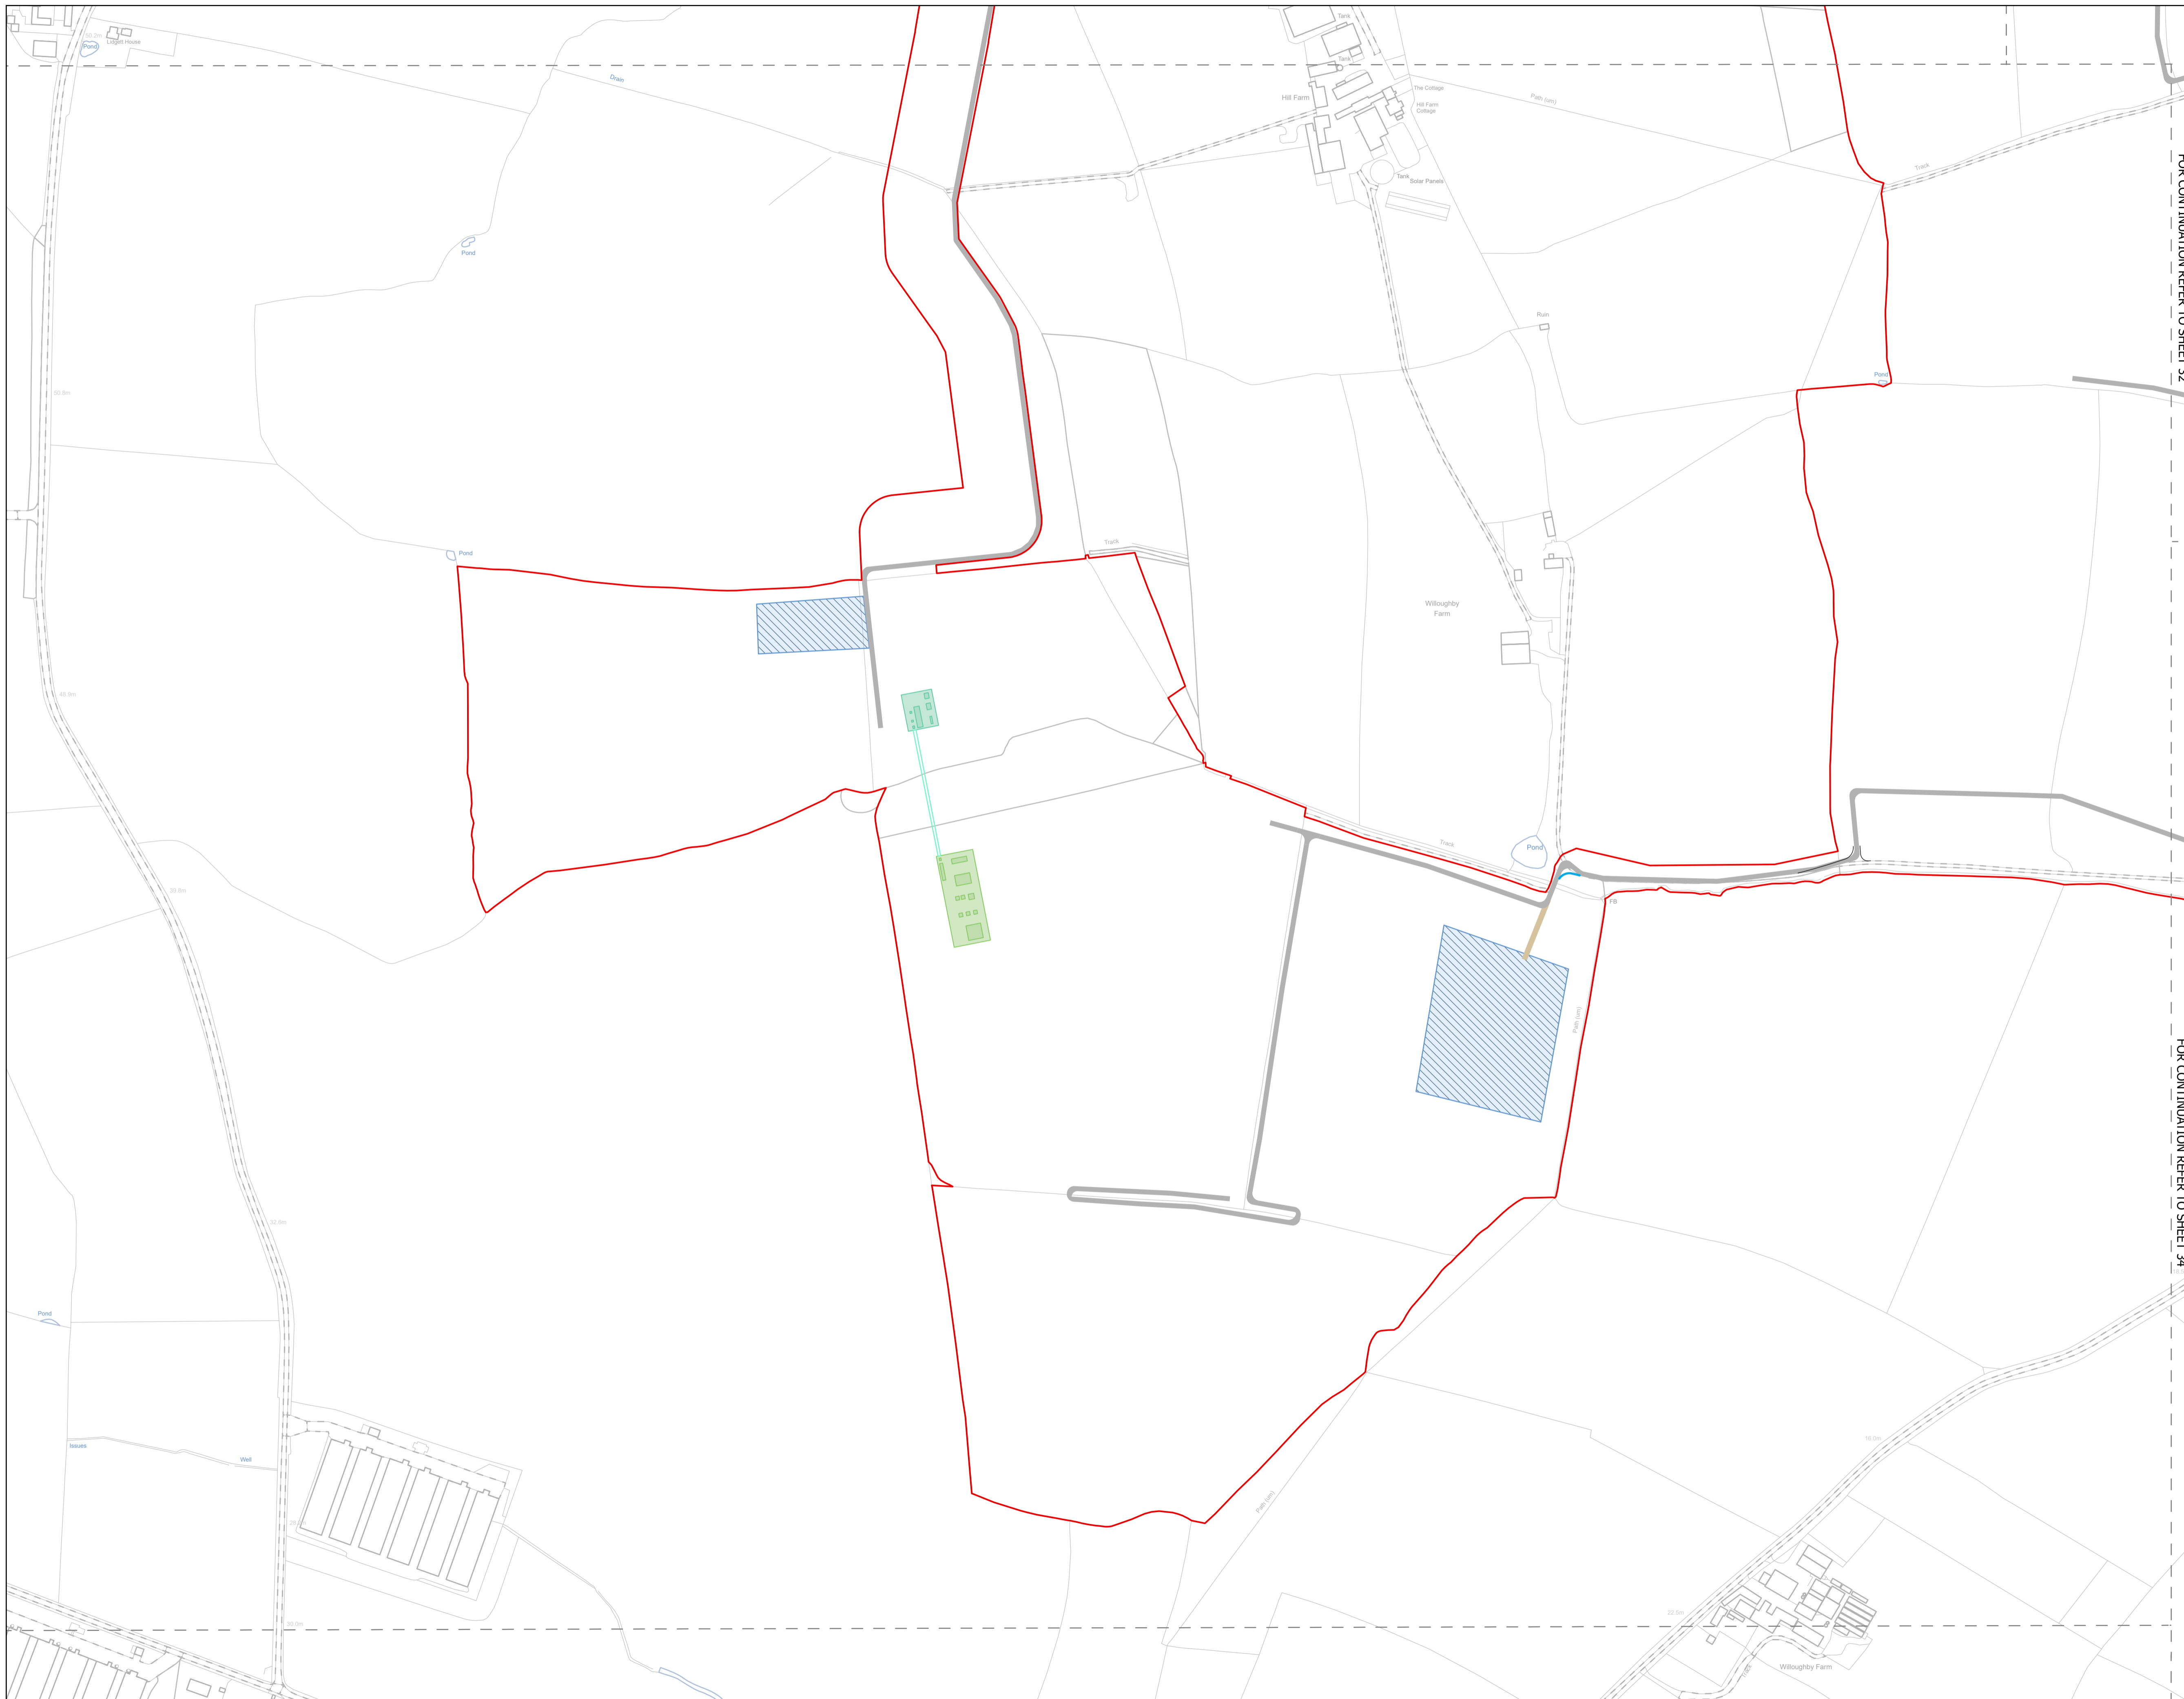


NOTES
1. ALL DIMENSIONS ARE IN METRES UNLESS STATED OTHERWISE.

FOR CONTINUATION REFER TO SHEET 32

- Legend**
- Order Limits
 - ↑ Construction Only Access Point
 - ↑ Maintenance and Construction Access Point
 - ↑ Maintenance Access and Construction Cross Over Point
 - Footpath Closure
 - Footpath Diversion
 - Bridleway Closed For Construction and Decommissioning
 - New Permissive Footpath
 - New Permissive Bridleway
 - Bridleway Diversion for Construction and Decommissioning
 - Access Bellmouth
 - Passing Places
 - HDD Connection Channel
 - HDD Compound Pull-Back Rig
 - HDD Compound Rig Side
 - Internal Tarmac Roads
 - Internal Stone Roads
 - Temporary Construction Roads
 - Main Compound Areas
 - Satellite Compound Areas

The Legend is identical on all sheets of the Illustrative Construction Layout and therefore not all items specified in the Legend are found on each sheet

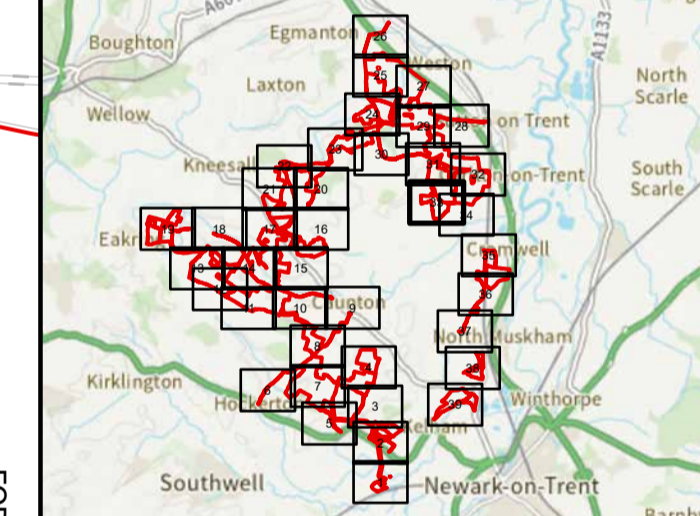

Revision 3	AD	LA	14/04/2026	Rev03
Revision 2	AD	LA	14/01/2026	Rev02
Revision 1	AD	LA	24/06/2025	Rev01
Revision Details	By	Check	Date	Suffix

Applicant: Elements Green Trent Limited

Solar & Biodiversity Park

Project Title:
GREAT NORTH ROAD SOLAR AND BIODIVERSITY PARK

Purpose of Issue:
DCO APPLICATION

Development Consent Order Number:
EN010162

Development Consent Order Drawing Number:
EN010162/APP/6.3.5.5B


Drawing Title:
Illustrative Construction Layout SHEET 33 of 39

Designed: AD	Drawn: AD	Checked: LA	Date: 14/04/2026
Internal Project Number: 026	Suitability: DCO Application		

Scale @ A1:
1:2,500

Rev:
Rev03

FOR CONTINUATION REFER TO SHEET 34

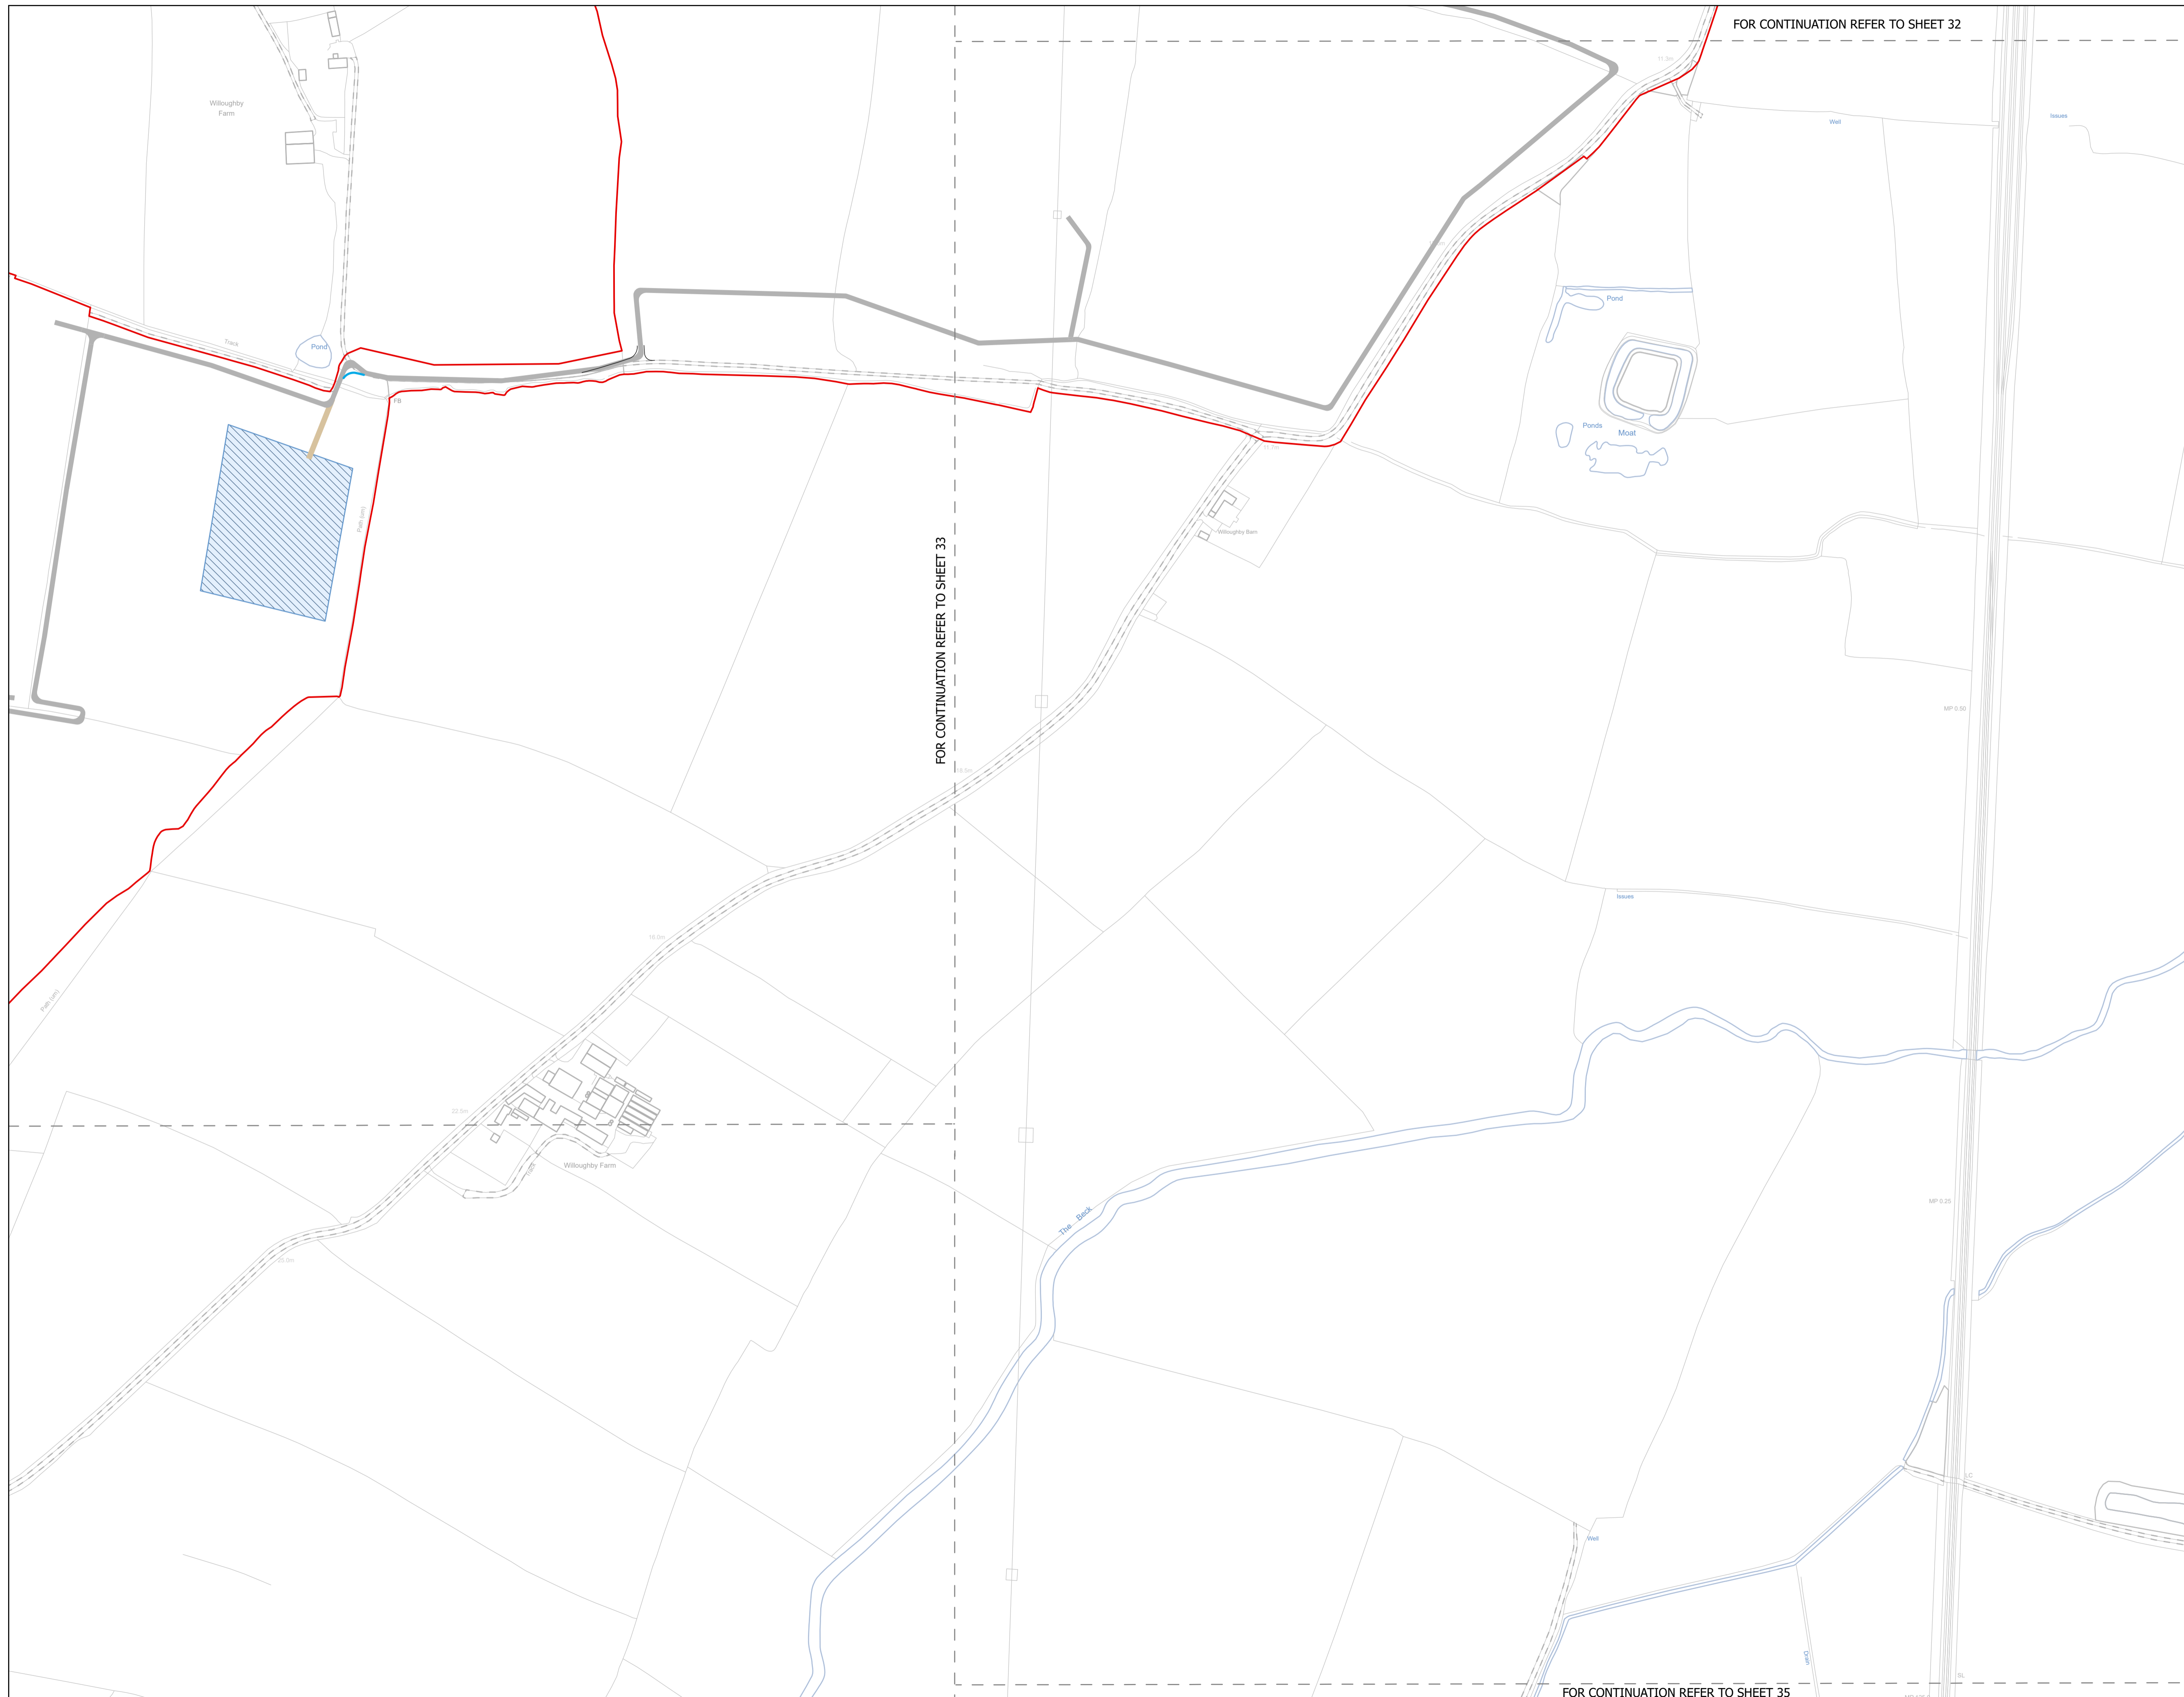

FOR CONTINUATION REFER TO SHEET 32

FOR CONTINUATION REFER TO SHEET 33


FOR CONTINUATION REFER TO SHEET 35

NOTES
1. ALL DIMENSIONS ARE IN METRES UNLESS STATED OTHERWISE.

Legend

- Order Limits
- ↑ Construction Only Access Point
- ↑ Maintenance and Construction Access Point
- ↑ Maintenance Access and Construction Cross Over Point
- Footpath Closure
- Footpath Diversion
- Bridleway Closed For Construction and Decommissioning
- New Permissive Footpath
- New Permissive Bridleway
- Bridleway Diversion for Construction and Decommissioning
- Access Bellmouth
- Passing Places
- HDD Connection Channel
- HDD Compound Pull-Back Rig
- HDD Compound Rig Side
- Internal Tarmac Roads
- Internal Stone Roads
- Temporary Construction Roads
- Main Compound Areas
- Satellite Compound Areas

The Legend is identical on all sheets of the Illustrative Construction Layout and therefore not all items specified in the Legend are found on each sheet

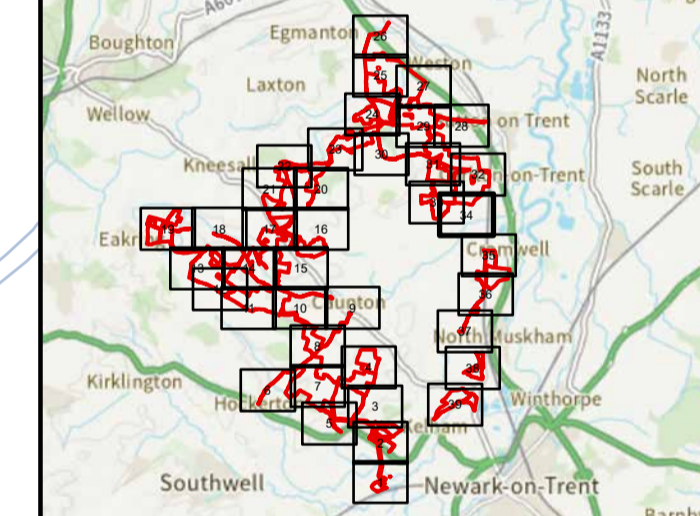

Revision 3	AD	LA	14/04/2026	Rev03
Revision 2	AD	LA	14/01/2026	Rev02
Revision 1	AD	LA	24/06/2025	Rev01
Revision Details	By	Check	Date	Suffix

Applicant: Elements Green Trent Limited

Solar & Biodiversity Park

Project Title:
GREAT NORTH ROAD SOLAR AND BIODIVERSITY PARK

Purpose of Issue:
DCO APPLICATION

Development Consent Order Number:
EN010162

Development Consent Order Drawing Number:
EN010162/APP/6.3.5.5B


Drawing Title:
Illustrative Construction Layout SHEET 34 of 39

Designed: AD	Drawn: AD	Checked: LA	Date: 14/04/2026
Internal Project Number: 026		Suitability: DCO Application	


Scale @ A1:
1:2,500

N

Rev:
Rev03

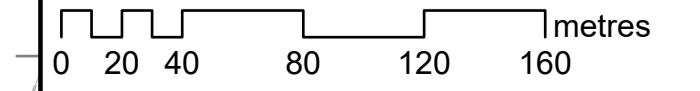

FOR CONTINUATION REFER TO SHEET 34

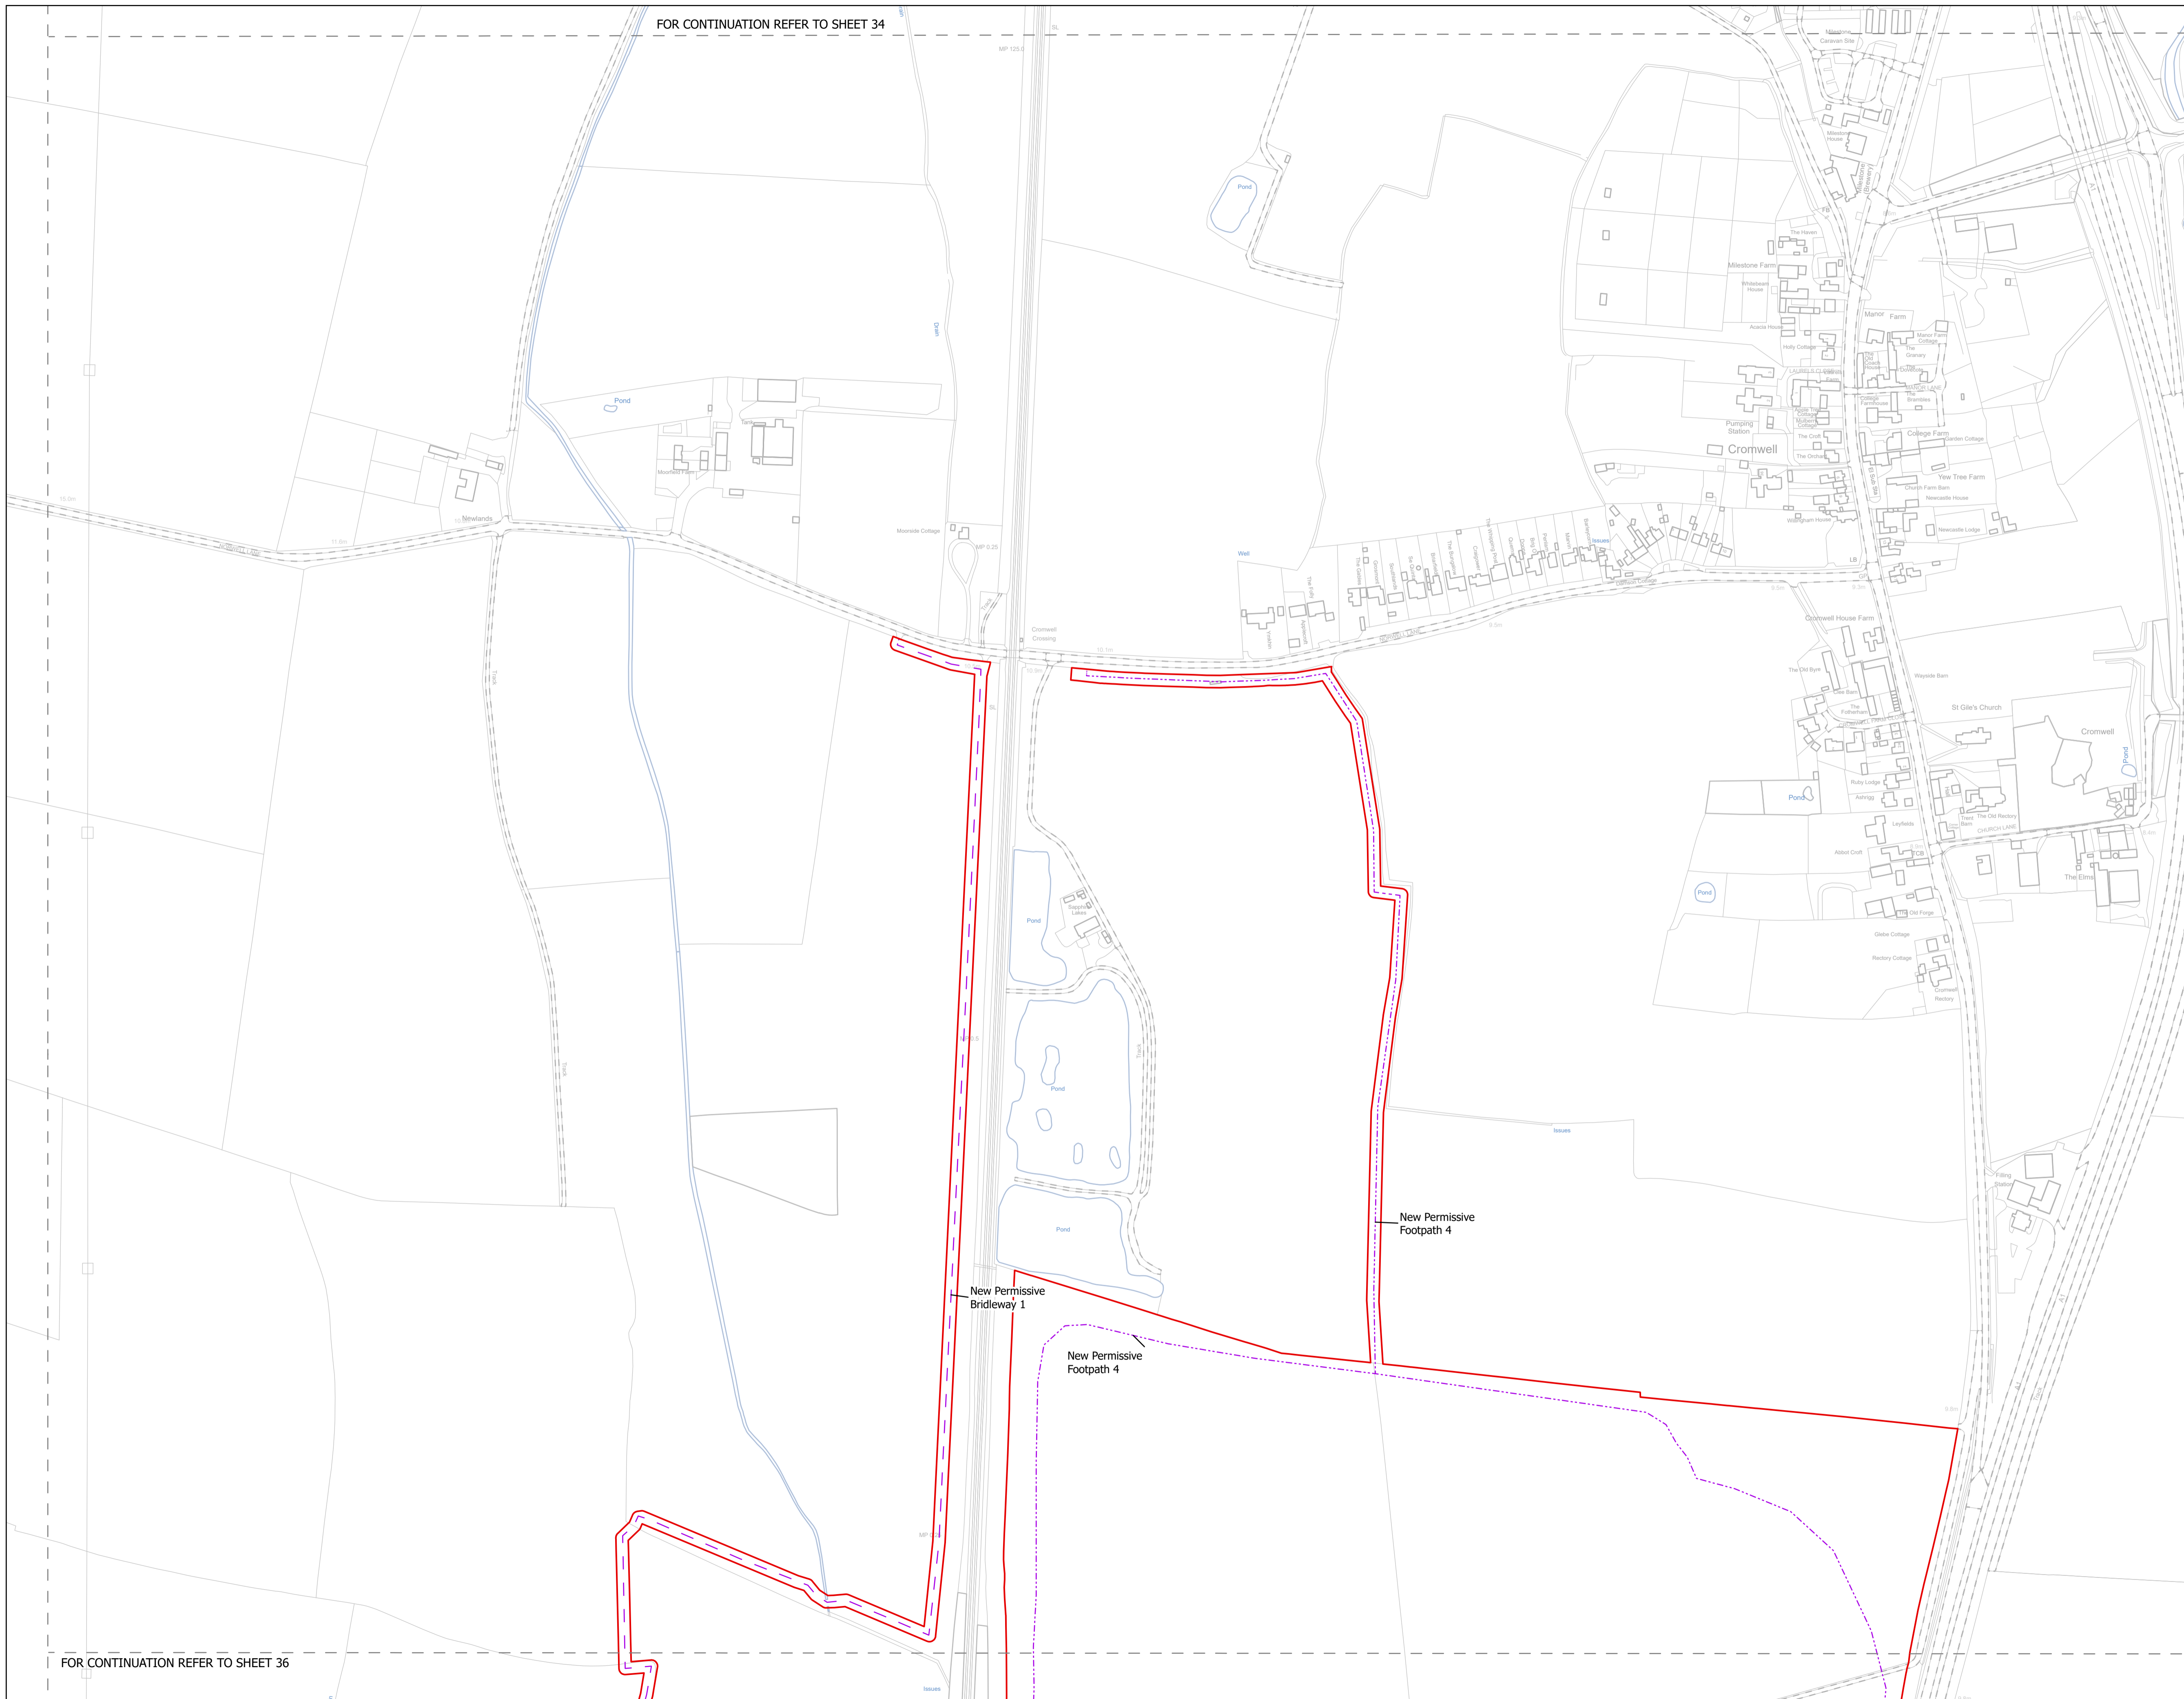


FOR CONTINUATION REFER TO SHEET 36

NOTES
1. ALL DIMENSIONS ARE IN METRES UNLESS STATED OTHERWISE.

Legend

- Order Limits
- ↑ Construction Only Access Point
- ↑ Maintenance and Construction Access Point
- ↑ Maintenance Access and Construction Cross Over Point
- Footpath Closure
- Footpath Diversion
- Bridleway Closed For Construction and Decommissioning
- New Permissive Footpath
- New Permissive Bridleway
- Bridleway Diversion for Construction and Decommissioning
- Access Bellmouth
- Passing Places
- HDD Connection Channel
- HDD Compound Pull-Back Rig
- HDD Compound Rig Side
- Internal Tarmac Roads
- Internal Stone Roads
- Temporary Construction Roads
- Main Compound Areas
- Satellite Compound Areas

The Legend is identical on all sheets of the Illustrative Construction Layout and therefore not all items specified in the Legend are found on each sheet

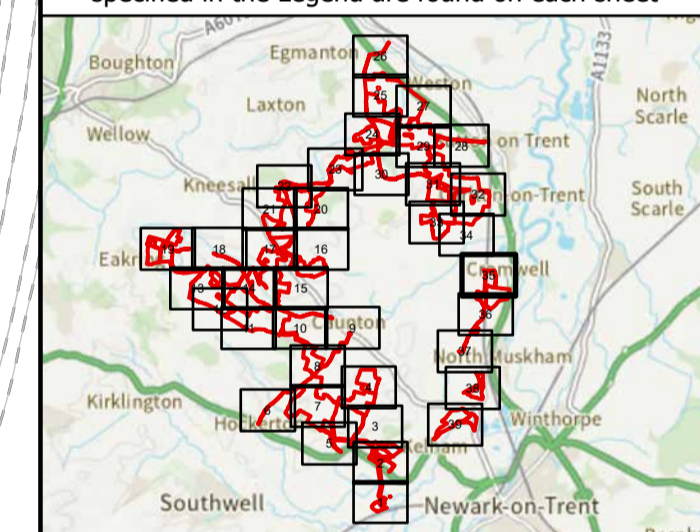

Revision 3	AD	LA	14/04/2026	Rev03
Revision 2	AD	LA	14/01/2026	Rev02
Revision 1	AD	LA	24/06/2025	Rev01
Revision Details	By	Check	Date	Suffix

Applicant: Elements Green Trent Limited

Solar & Biodiversity Park

Project Title:
GREAT NORTH ROAD SOLAR AND BIODIVERSITY PARK

Purpose of Issue:
DCO APPLICATION

Development Consent Order Number:
EN010162

Development Consent Order Drawing Number:
EN010162/APP/6.3.5.5B


Drawing Title:
Illustrative Construction Layout SHEET 35 of 39

Designed: AD	Drawn: AD	Checked: LA	Date: 14/04/2026
Internal Project Number: 026		Suitability: DCO Application	

Scale @ A1:
1:2,500

N

Rev:
Rev03

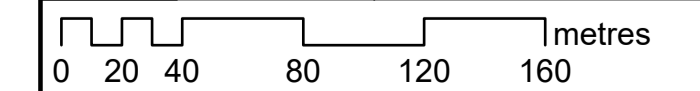


FOR CONTINUATION REFER TO SHEET 35

NOTES
1. ALL DIMENSIONS ARE IN METRES UNLESS STATED OTHERWISE.


Legend

- Order Limits
- Construction Only Access Point
- Maintenance and Construction Access Point
- Maintenance Access and Construction Cross Over Point
- Footpath Closure
- Footpath Diversion
- Bridleway Closed For Construction and Decommissioning
- New Permissive Footpath
- New Permissive Bridleway
- Bridleway Diversion for Construction and Decommissioning
- Access Bellmouth
- Passing Places
- HDD Connection Channel
- HDD Compound Pull-Back Rig
- HDD Compound Rig Side
- Internal Tarmac Roads
- Internal Stone Roads
- Temporary Construction Roads
- Main Compound Areas
- Satellite Compound Areas

The Legend is identical on all sheets of the Illustrative Construction Layout and therefore not all items specified in the Legend are found on each sheet

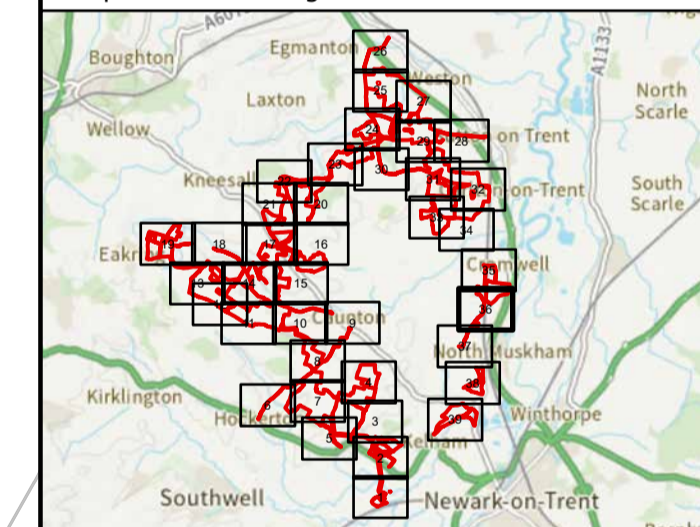

Revision 3	AD	LA	14/04/2026	Rev03
Revision 2	AD	LA	14/01/2026	Rev02
Revision 1	AD	LA	24/06/2025	Rev01
Revision Details	By	Check	Date	Suffix

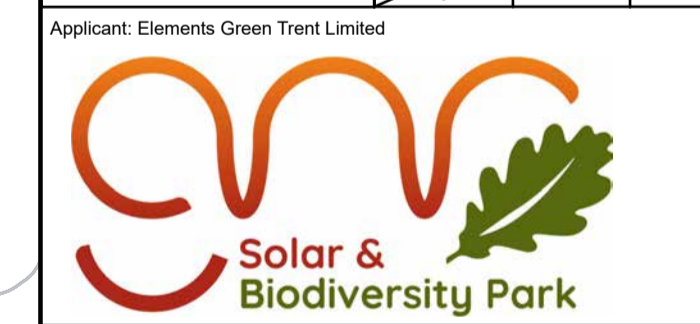

Project Title:
GREAT NORTH ROAD SOLAR AND BIODIVERSITY PARK

Purpose of Issue:
DCO APPLICATION


Development Consent Order Number:
EN010162

Development Consent Order Drawing Number:
EN010162/APP/6.3.5.5B


Drawing Title:
Illustrative Construction Layout SHEET 36 of 39

Designed: AD	Drawn: AD	Checked: LA	Date: 14/04/2026
Internal Project Number: 026	Suitability: DCO Application		
Scale @ A1: 1:2,500			

N	Rev: Rev03
---	---------------

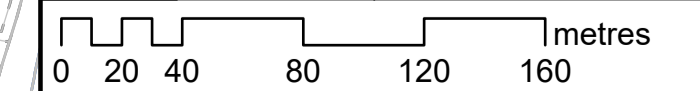

FOR CONTINUATION REFER TO SHEET 37

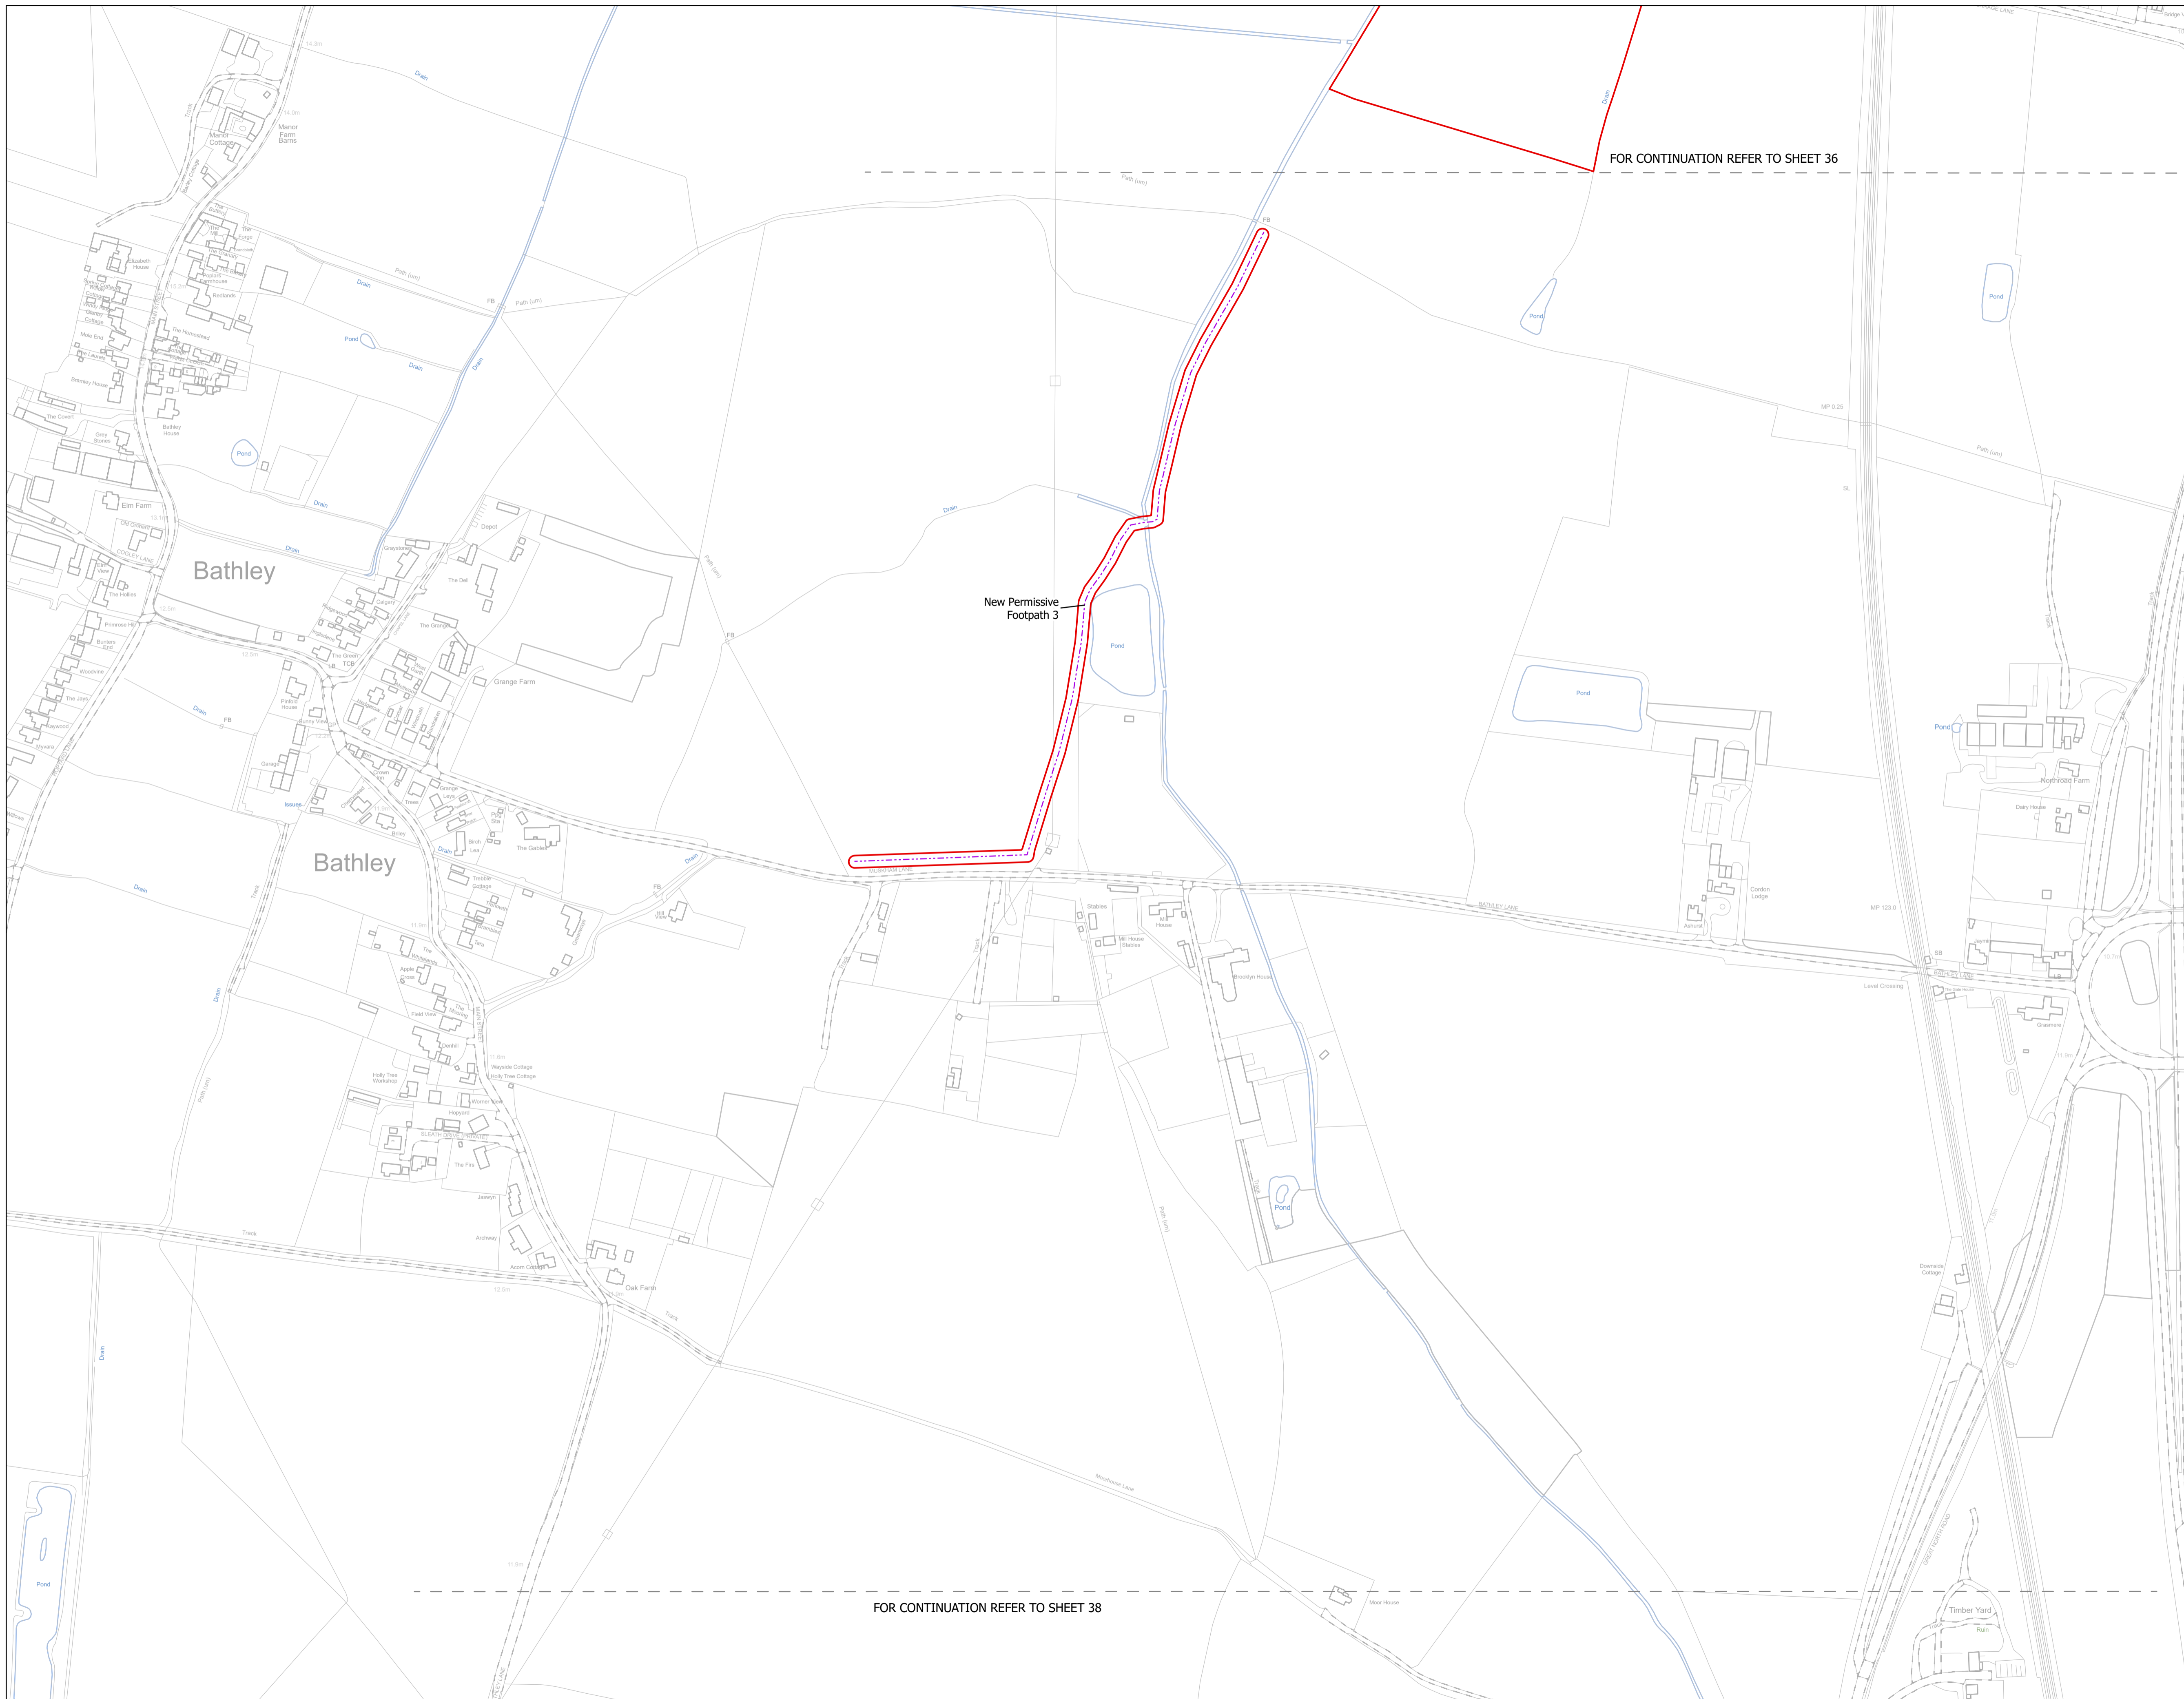

NOTES
1. ALL DIMENSIONS ARE IN METRES UNLESS STATED OTHERWISE.


FOR CONTINUATION REFER TO SHEET 36

New Permissive Footpath 3

Legend

- Order Limits
- ↑ Construction Only Access Point
- ↑ Maintenance and Construction Access Point
- ↑ Maintenance Access and Construction Cross Over Point
- Footpath Closure
- Footpath Diversion
- Bridleway Closed For Construction and Decommissioning
- New Permissive Footpath
- New Permissive Bridleway
- Bridleway Diversion for Construction and Decommissioning
- Access Bellmouth
- Passing Places
- HDD Connection Channel
- HDD Compound Pull-Back Rig
- HDD Compound Rig Side
- Internal Tarmac Roads
- Internal Stone Roads
- Temporary Construction Roads
- Main Compound Areas
- Satellite Compound Areas

The Legend is identical on all sheets of the Illustrative Construction Layout and therefore not all items specified in the Legend are found on each sheet

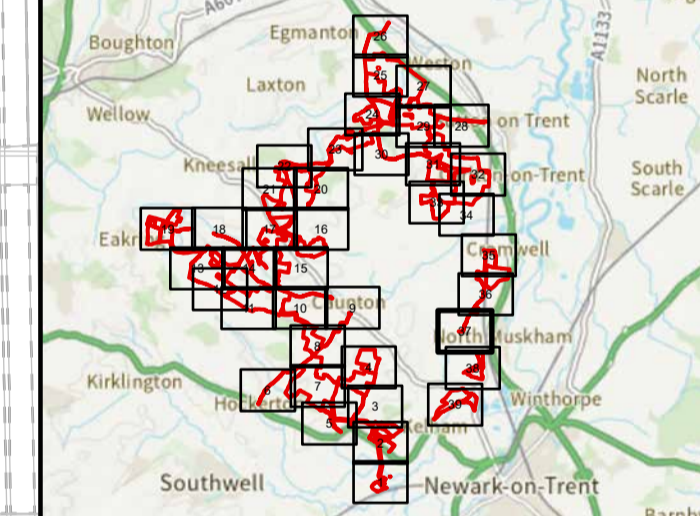

Revision 3	AD	LA	14/04/2026	Rev03
Revision 2	AD	LA	14/01/2026	Rev02
Revision 1	AD	LA	24/06/2025	Rev01
Revision Details	By	Check	Date	Suffix



Project Title:
GREAT NORTH ROAD SOLAR AND BIODIVERSITY PARK

Purpose of Issue:
DCO APPLICATION

Development Consent Order Number:
EN010162

Development Consent Order Drawing Number:
EN010162/APP/6.3.5.5B

Drawing Title:
Illustrative Construction Layout SHEET 37 of 39


Designed: AD	Drawn: AD	Checked: LA	Date: 14/04/2026
-----------------	--------------	----------------	---------------------

Internal Project Number:
026

Suitability:
DCO Application


Scale @ A1:
1:2,500

N	Rev: Rev03
---	---------------

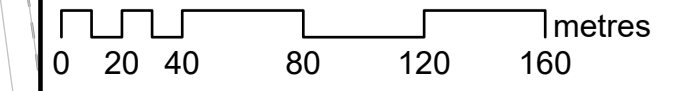

FOR CONTINUATION REFER TO SHEET 38

FOR CONTINUATION REFER TO SHEET 37

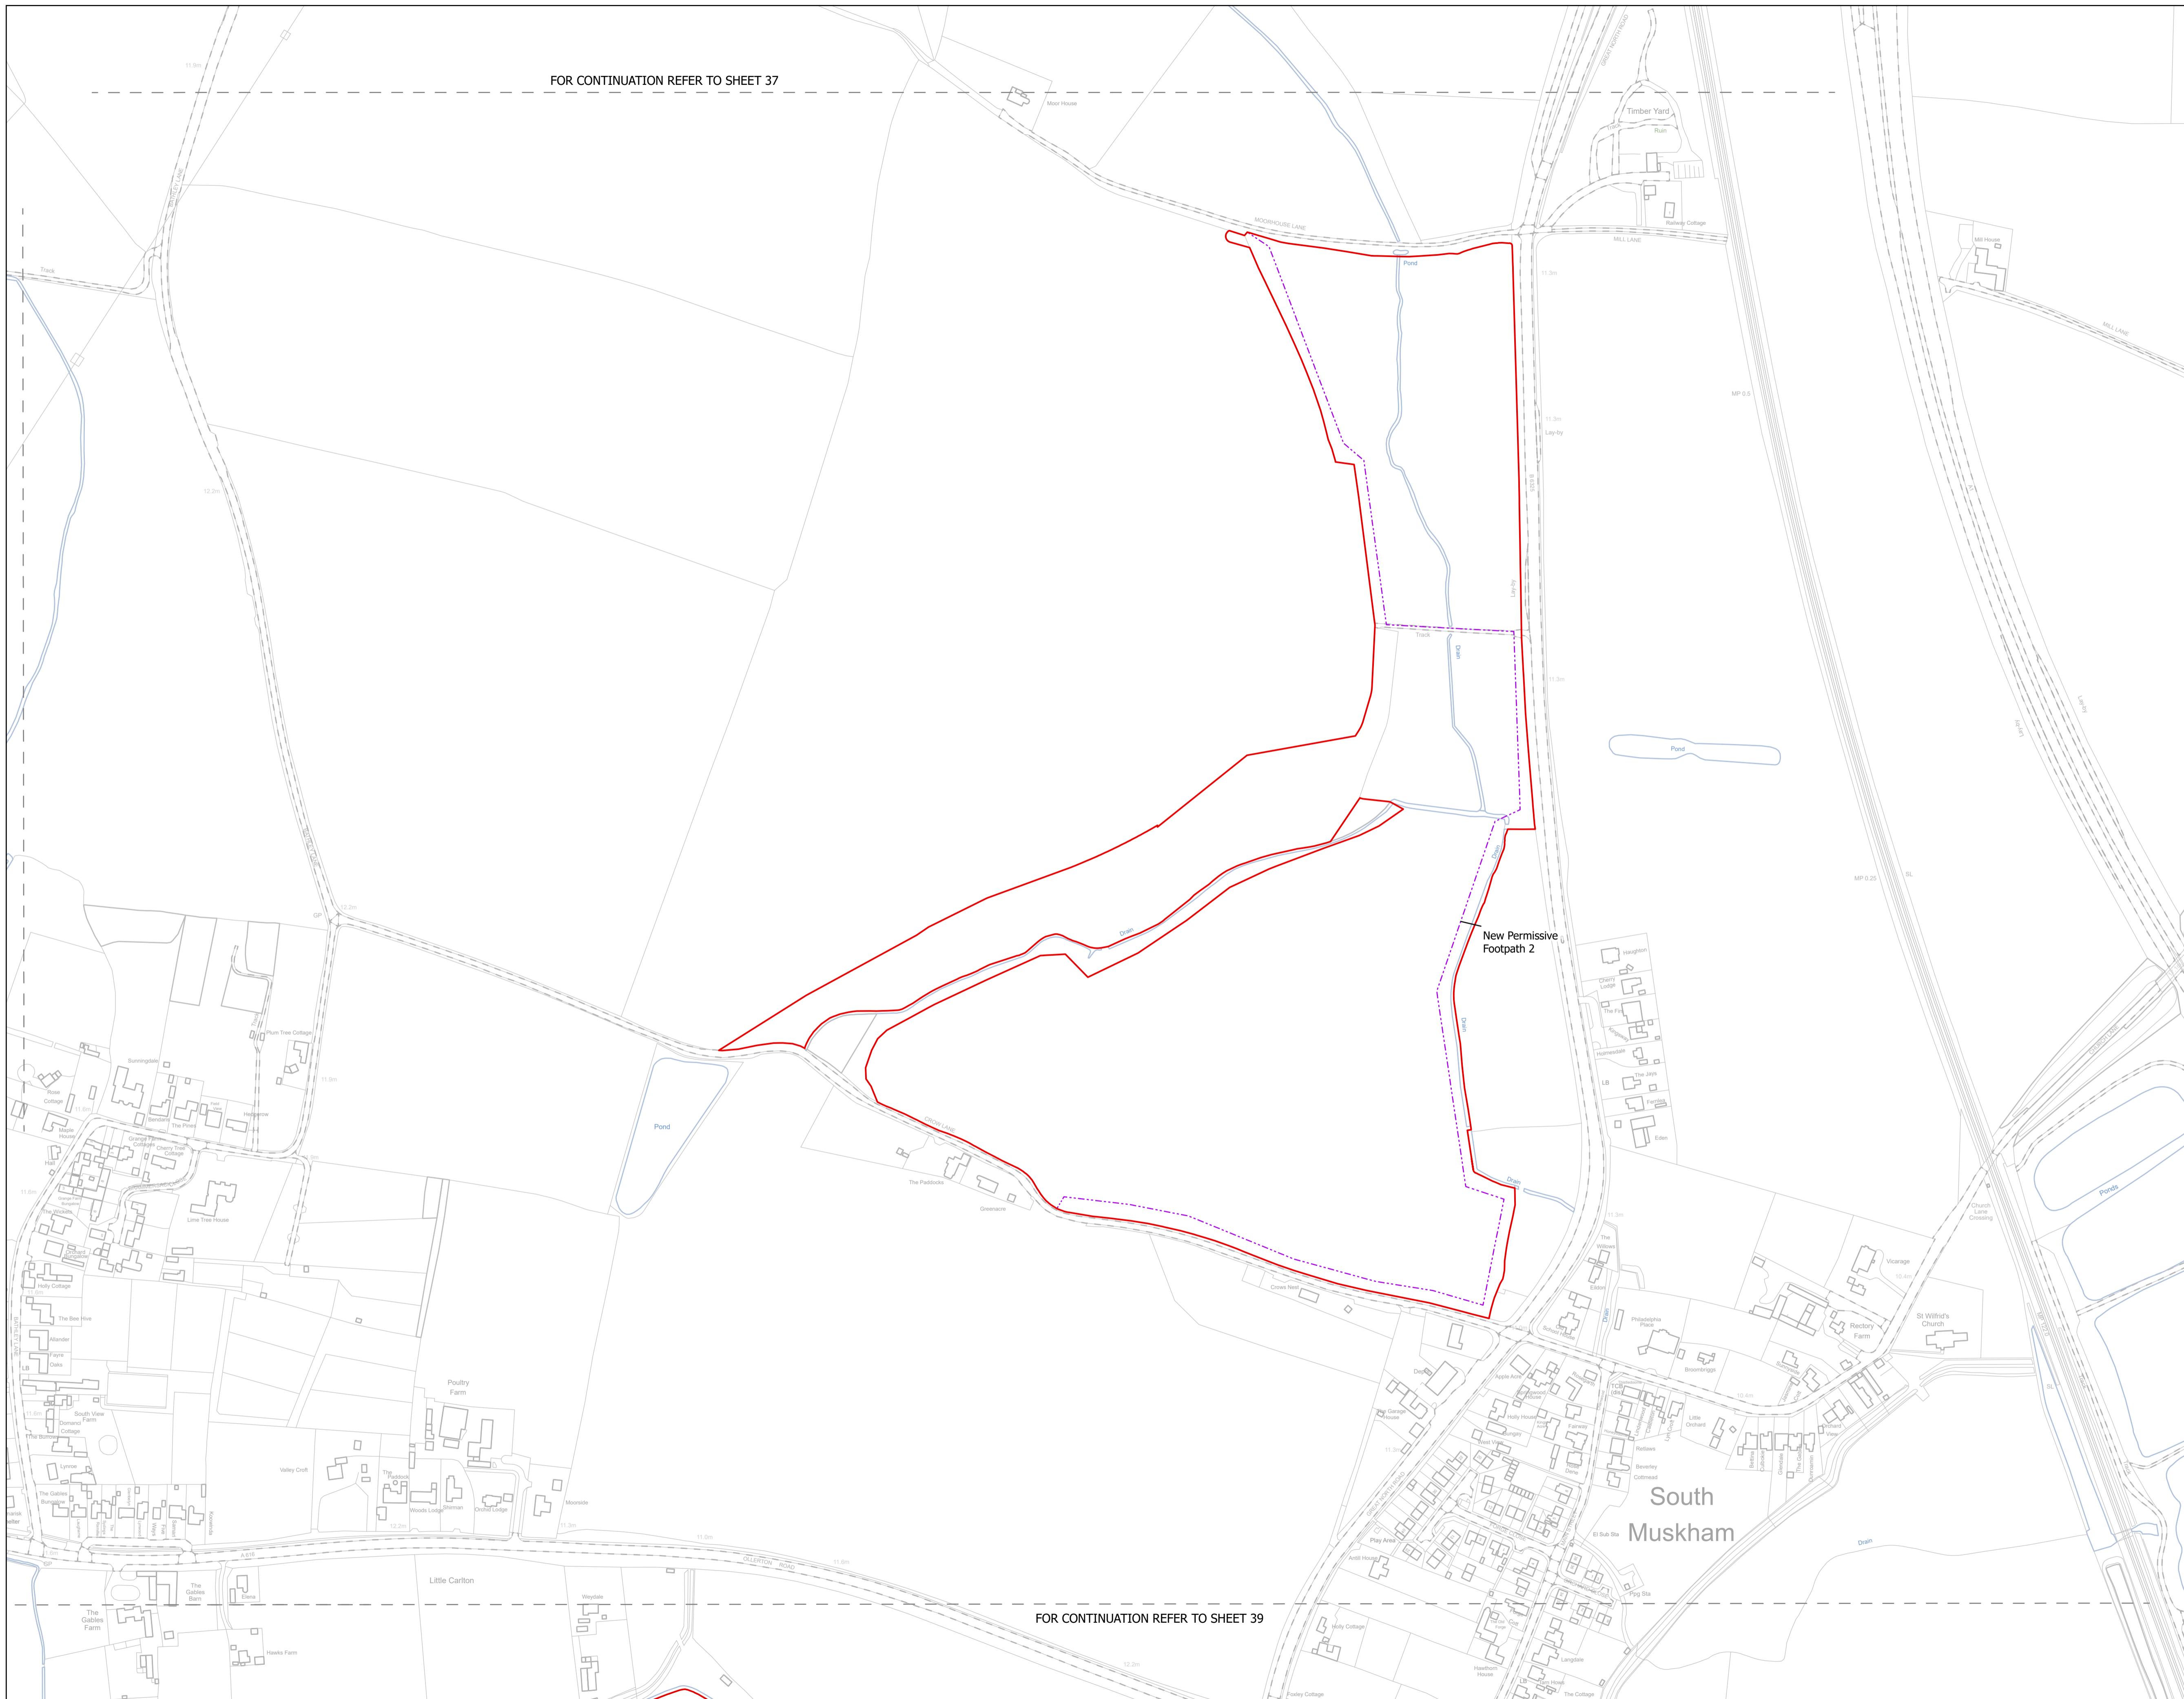


FOR CONTINUATION REFER TO SHEET 39

NOTES
1. ALL DIMENSIONS ARE IN METRES UNLESS STATED OTHERWISE.

Legend

- Order Limits
- ↑ Construction Only Access Point
- ↑ Maintenance and Construction Access Point
- ↑ Maintenance Access and Construction Cross Over Point
- Footpath Closure
- Footpath Diversion
- Bridleway Closed For Construction and Decommissioning
- - - New Permissive Footpath
- - - New Permissive Bridleway
- Bridleway Diversion for Construction and Decommissioning
- Access Bellmouth
- Passing Places
- HDD Connection Channel
- HDD Compound Pull-Back Rig
- HDD Compound Rig Side
- Internal Tarmac Roads
- Internal Stone Roads
- Temporary Construction Roads
- Main Compound Areas
- Satellite Compound Areas

The Legend is identical on all sheets of the Illustrative Construction Layout and therefore not all items specified in the Legend are found on each sheet

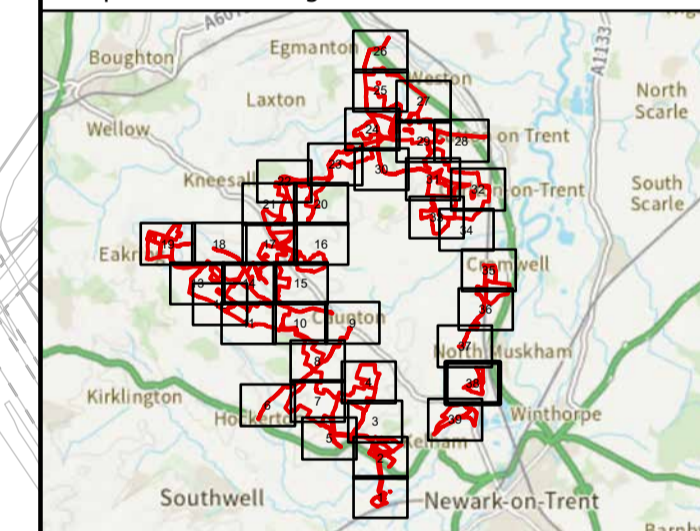

Revision 3	AD	LA	14/04/2026	Rev03
Revision 2	AD	LA	14/01/2026	Rev02
Revision 1	AD	LA	24/06/2025	Rev01
Revision Details	By	Check	Date	Suffix

Applicant: Elements Green Trent Limited

Project Title:
GREAT NORTH ROAD SOLAR AND BIODIVERSITY PARK

Purpose of Issue:
DCO APPLICATION

Development Consent Order Number:
EN010162

Development Consent Order Drawing Number:
EN010162/APP/6.3.5.5B


Drawing Title:
Illustrative Construction Layout SHEET 38 of 39

Designed: AD	Drawn: AD	Checked: LA	Date: 14/04/2026
-----------------	--------------	----------------	---------------------

Internal Project Number: 026	Suitability: DCO Application
---------------------------------	---------------------------------

Scale @ A1:
1:2,500

N	Rev: Rev03
---	---------------

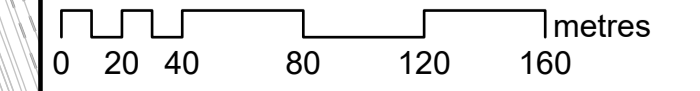


FOR CONTINUATION REFER TO SHEET 38

NOTES
1. ALL DIMENSIONS ARE IN METRES UNLESS STATED OTHERWISE.

Legend

- Order Limits
- ↑ Construction Only Access Point
- ↑ Maintenance and Construction Access Point
- ↑ Maintenance Access and Construction Cross Over Point
- Footpath Closure
- Footpath Diversion
- Bridleway Closed For Construction and Decommissioning
- New Permissive Footpath
- New Permissive Bridleway
- Bridleway Diversion for Construction and Decommissioning
- Access Bellmouth
- Passing Places
- HDD Connection Channel
- HDD Compound Pull-Back Rig
- HDD Compound Rig Side
- Internal Tarmac Roads
- Internal Stone Roads
- Temporary Construction Roads
- Main Compound Areas
- Satellite Compound Areas

The Legend is identical on all sheets of the Illustrative Construction Layout and therefore not all items specified in the Legend are found on each sheet

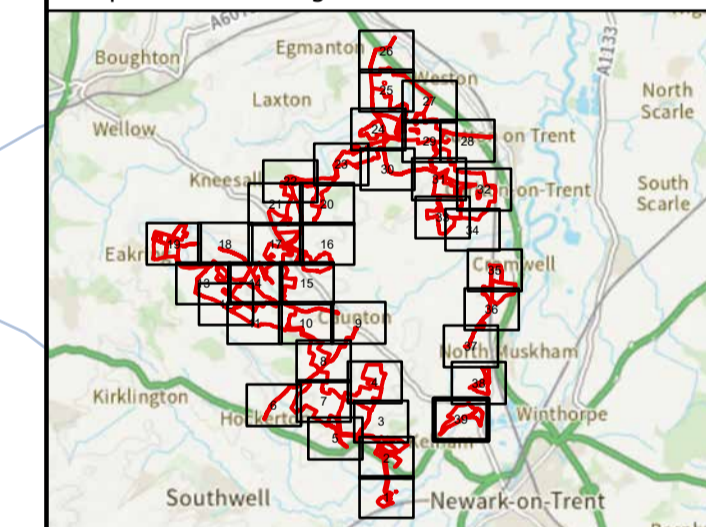

Revision 3	AD	LA	14/04/2026	Rev03
Revision 2	AD	LA	14/01/2026	Rev02
Revision 1	AD	LA	24/06/2025	Rev01
Revision Details	By	Check	Date	Suffix

Applicant: Elements Green Trent Limited



Project Title:
GREAT NORTH ROAD SOLAR AND BIODIVERSITY PARK

Purpose of Issue:
DCO APPLICATION

Development Consent Order Number:
EN010162

Development Consent Order Drawing Number:
EN010162/APP/6.3.5.5B

Drawing Title:
Illustrative Construction Layout SHEET 39 of 39


Designed: AD	Drawn: AD	Checked: LA	Date: 14/04/2026
-----------------	--------------	----------------	---------------------


Internal Project Number:
026

Suitability:
DCO Application

Scale @ A1:
1:2,500


Rev:
Rev03

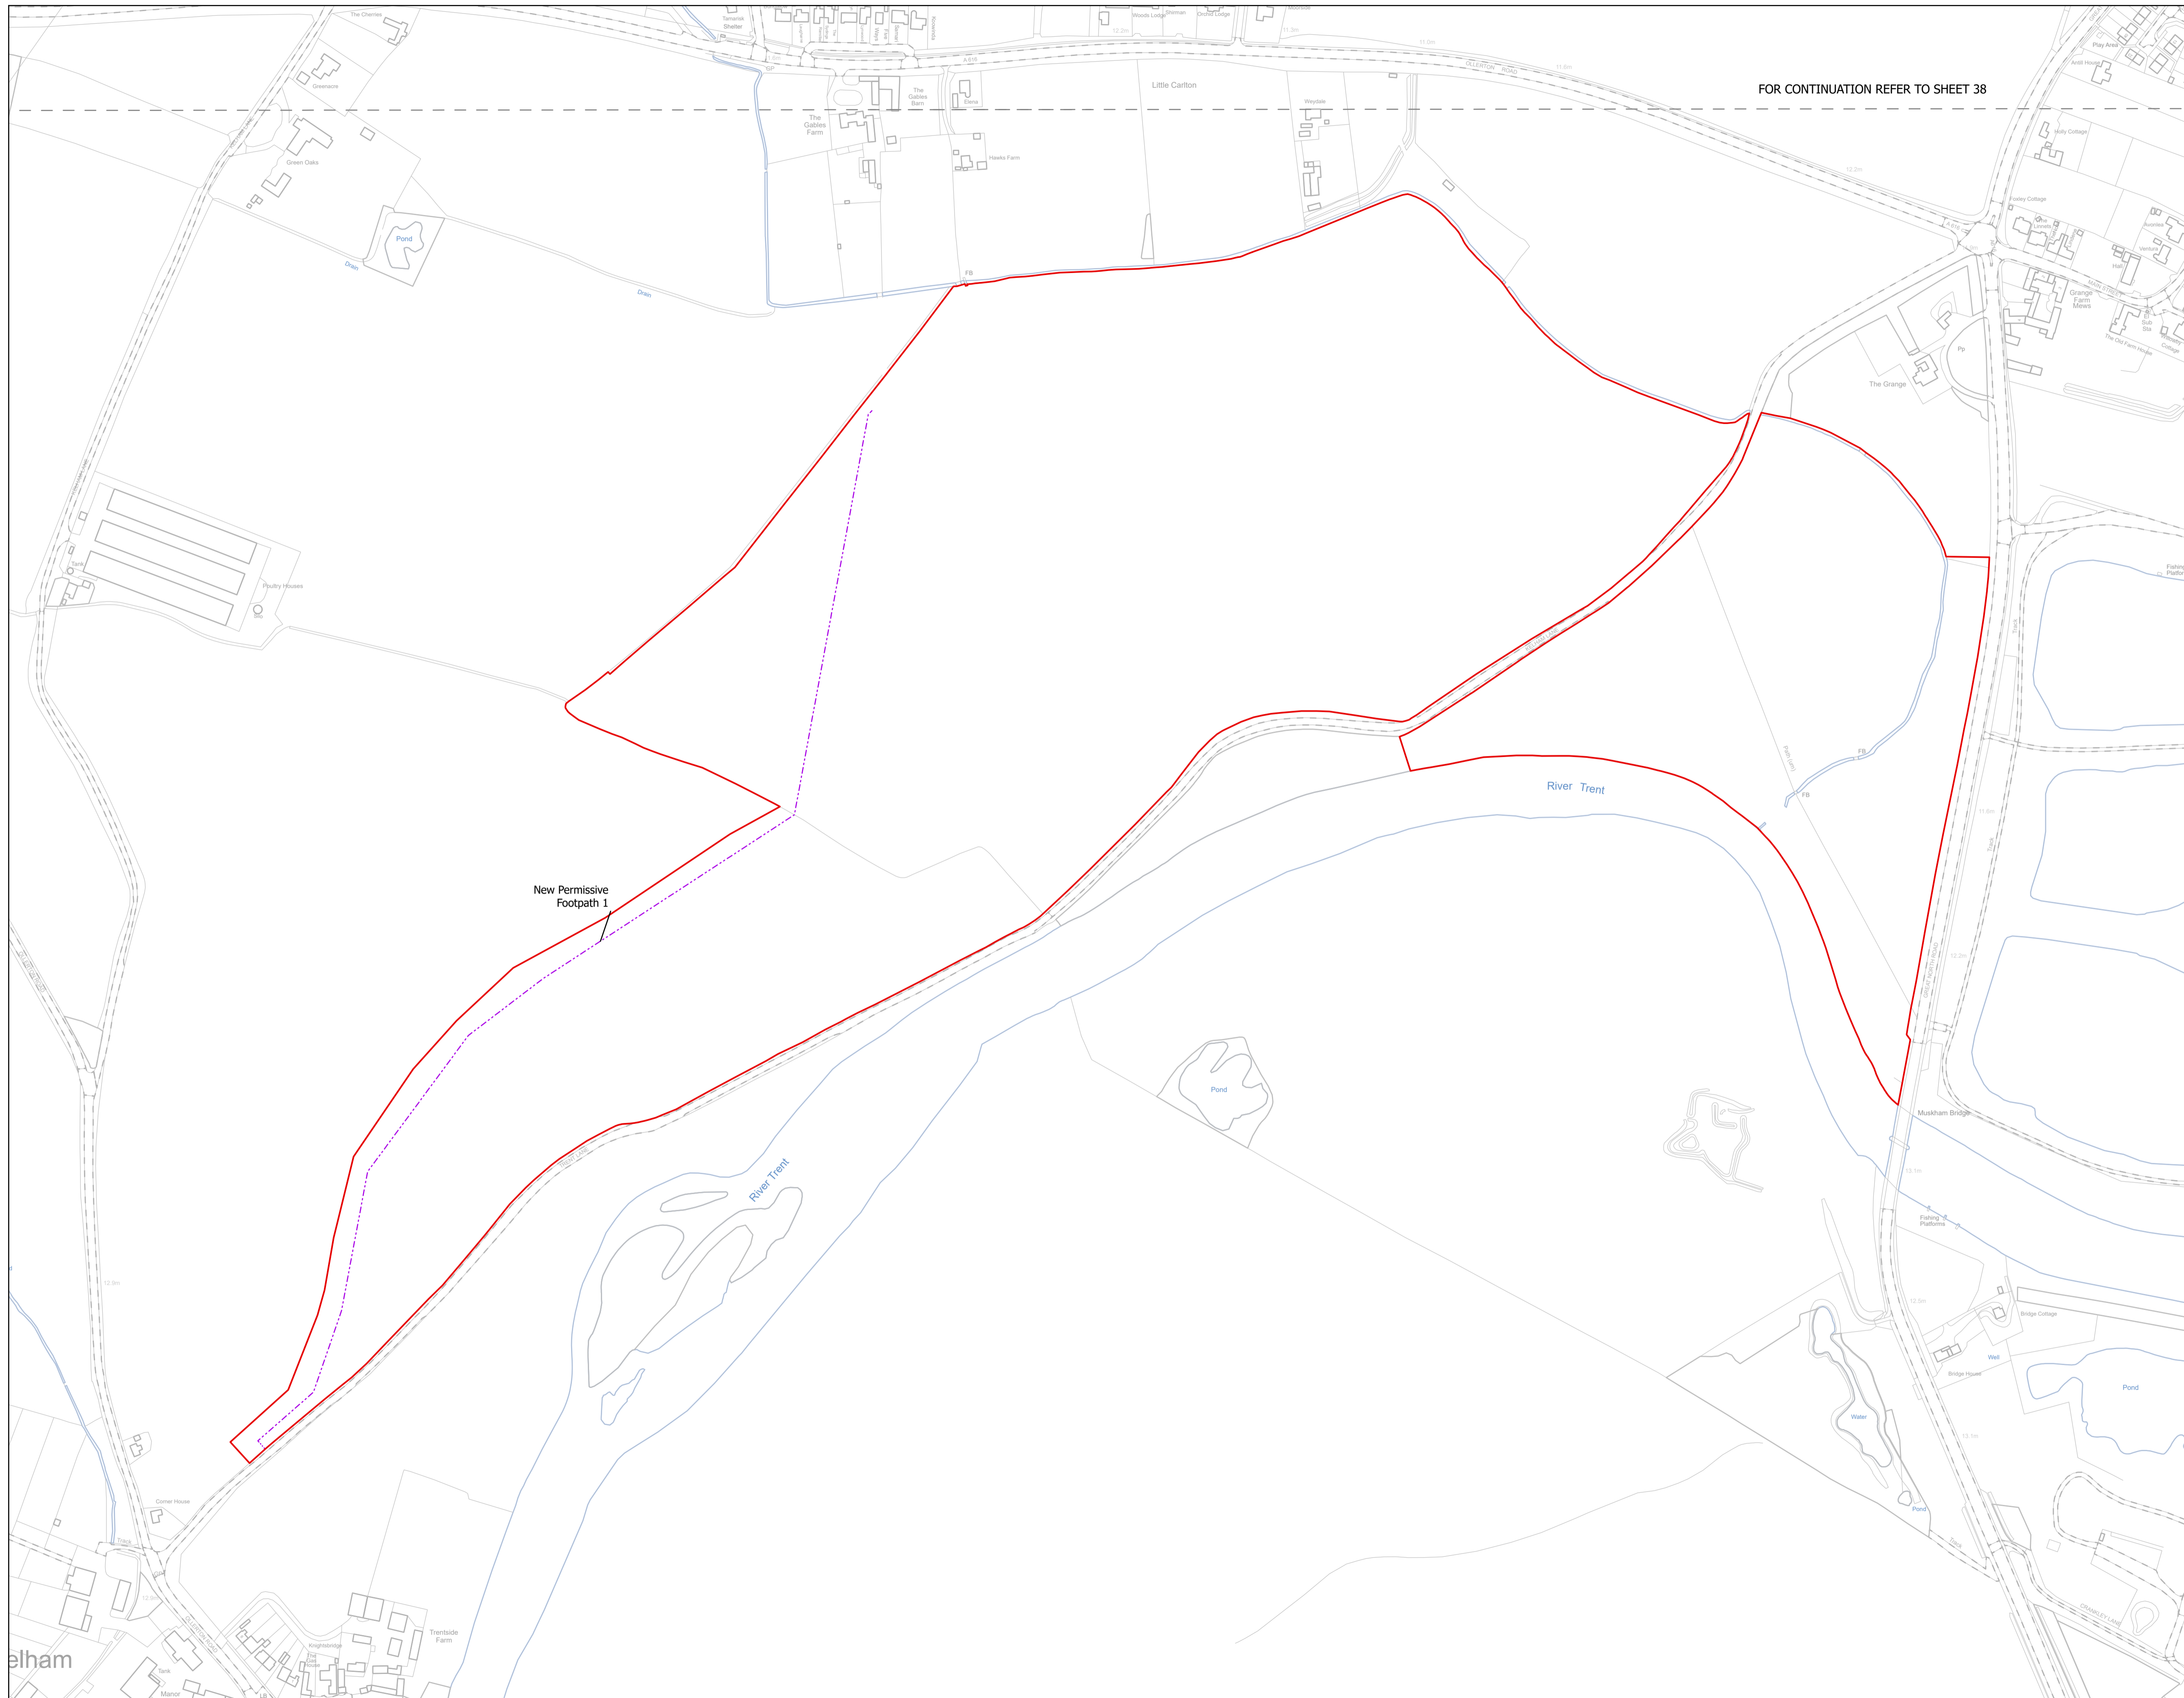

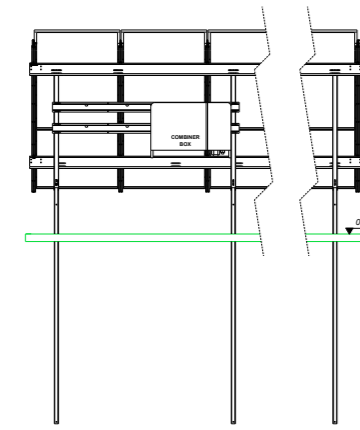


REAR VIEW (1)


Ground Level

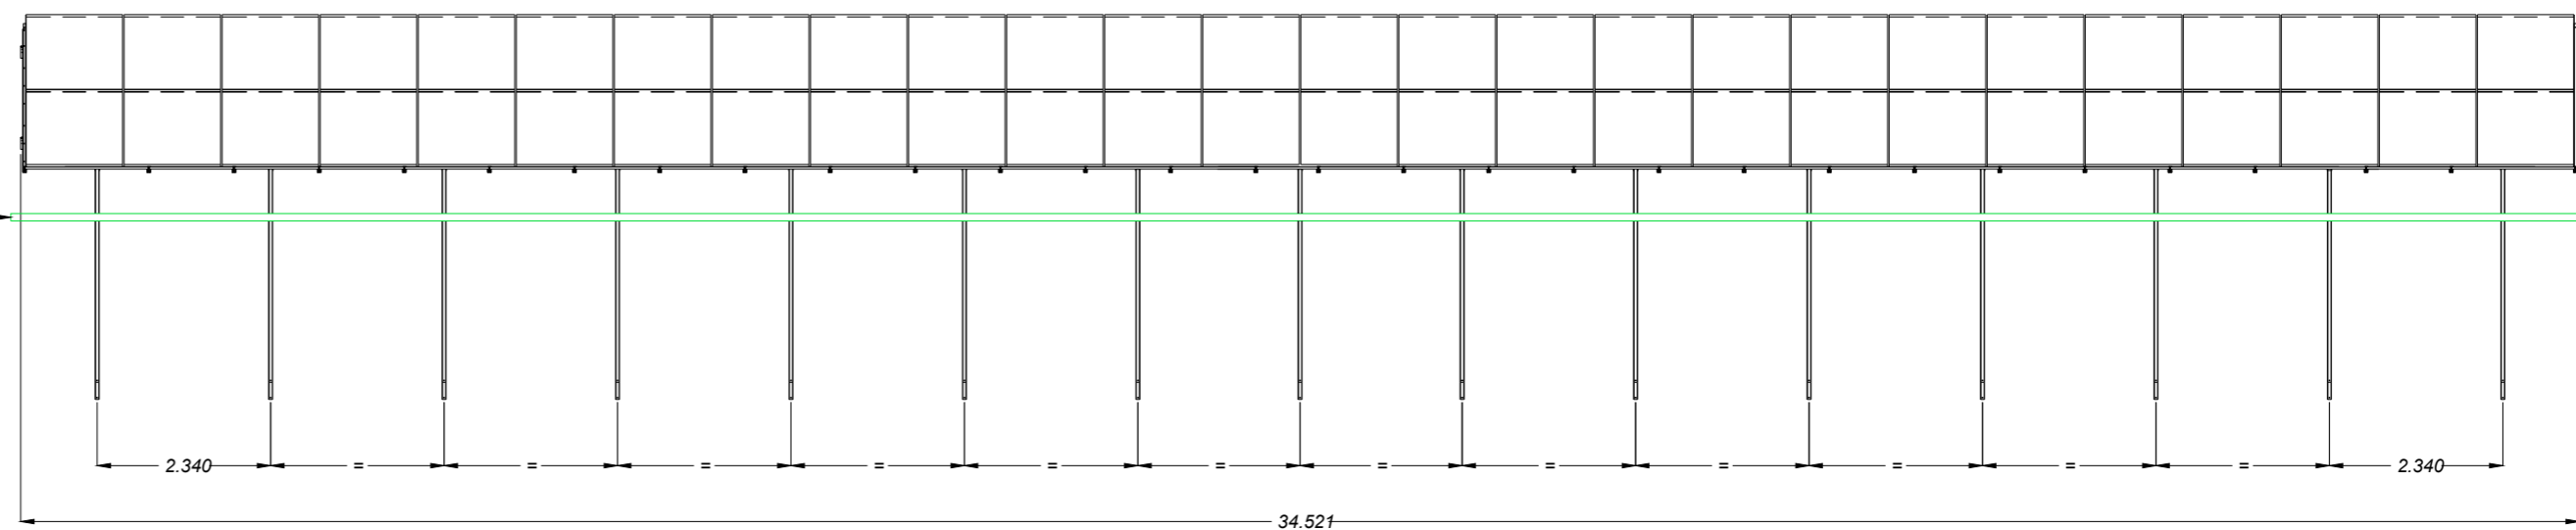

FRONT VIEW

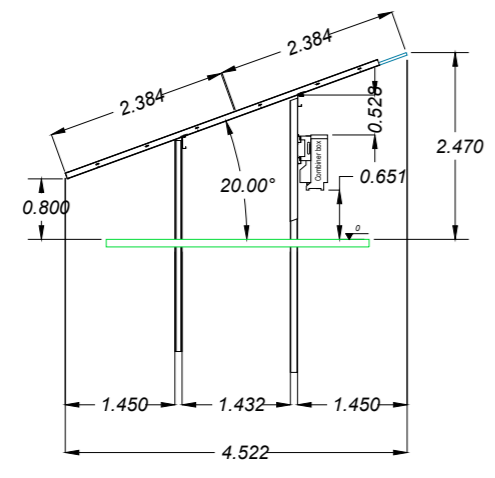


LEFT SIDE VIEW

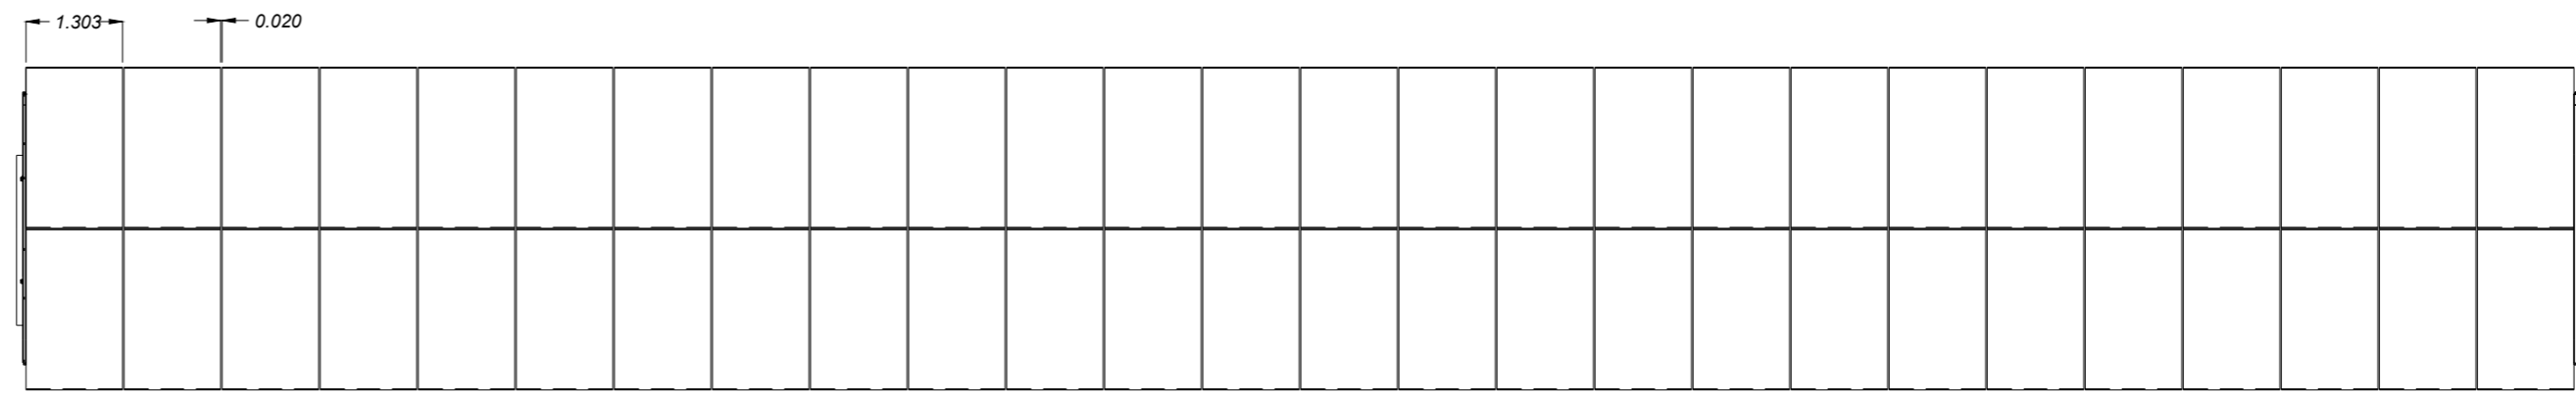

TOP VIEW

- (1) Combiner box position can be different
- (2) Table Size: 2Px26

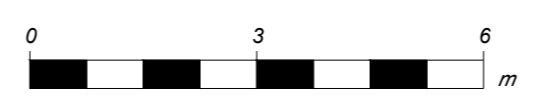

Rev.	Description	Date	Responsible
R01	First Issue	2025-06-13	BA

This document and its contents are confidential and it is intended solely for the use of the recipient(s) to whom it is addressed. All content, including drawings, designs, and other materials, are the intellectual property of Elements Green Trent Ltd. Any unauthorised use or distribution of this document without the prior written consent of Elements Green Trent Ltd (company number 13665201) is strictly prohibited. Registered Office: 1 Half Moon Street, London, England, W1J 7AY



Solar & Biodiversity Park


Drawing Title

Figure 5.6
Illustrative Sollar Array Plan, Elevation and Cross-Section

Illustrative Purposes Only


Drawing No. **UK003-PV-ENG-0-460-R00-5.06.1**

Designed by	Approved by	Date	Scale	Dimensions in	Paper Size	Sheet
BA	OC	2025-06-13	1:100	m	A2 (594x420)	1/2

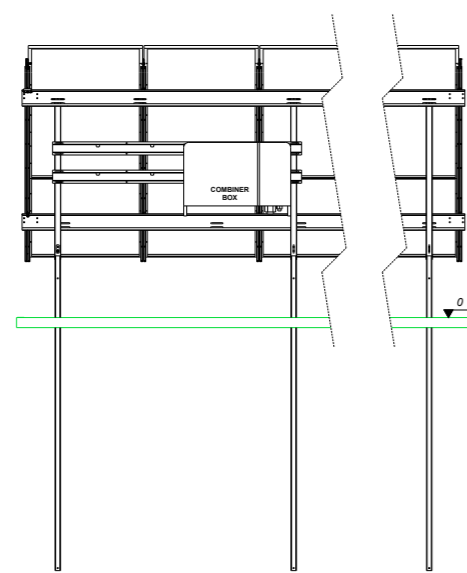


REAR VIEW (1)


Ground Level

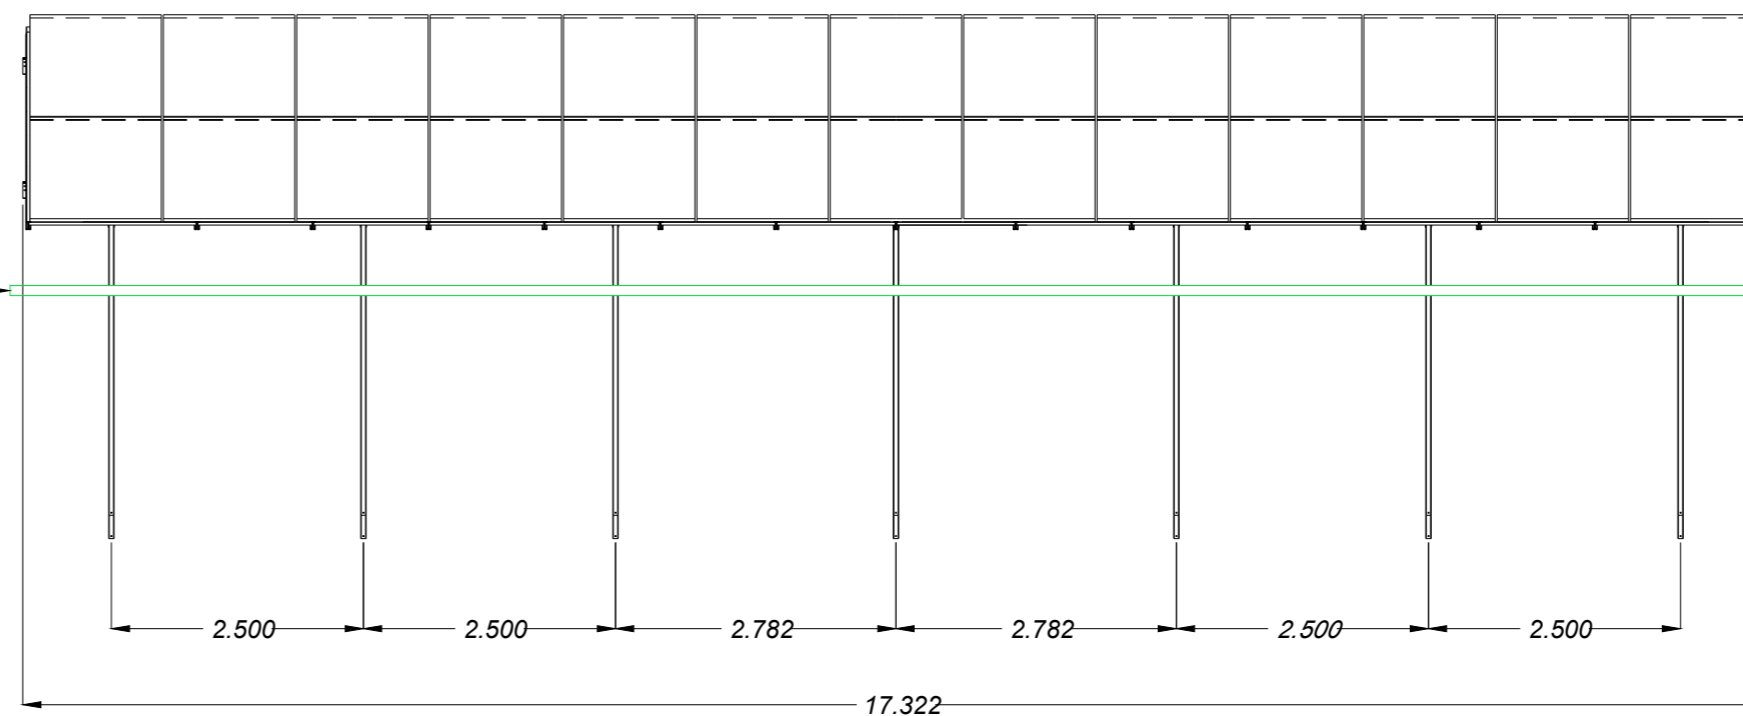

FRONT VIEW

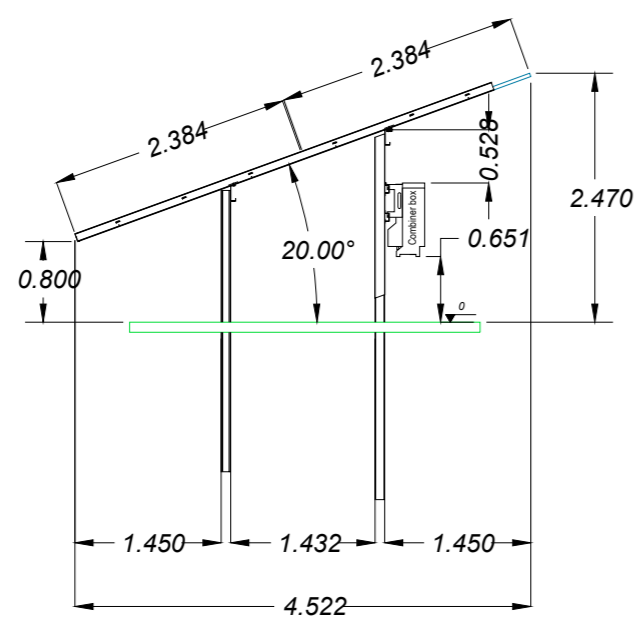


LEFT SIDE VIEW

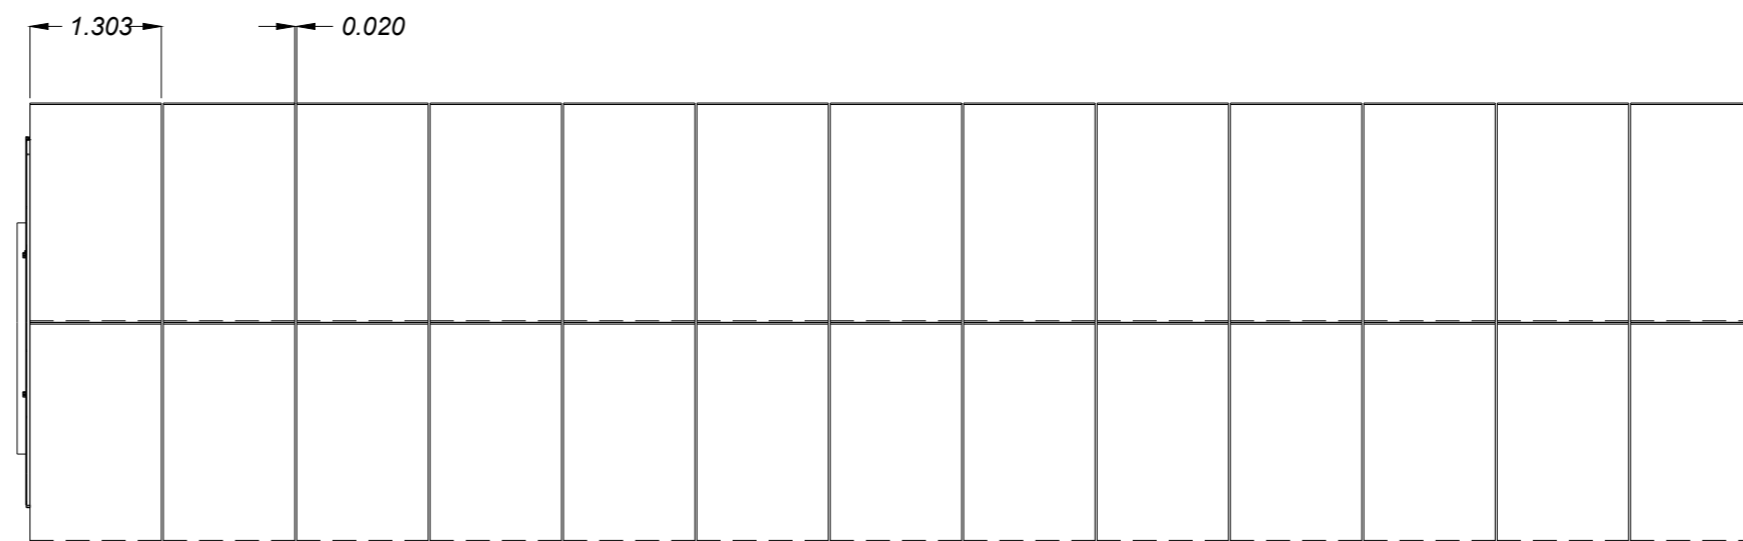


TOP VIEW

- (1) Combiner box position can be different
- (2) Table size: 2Px13

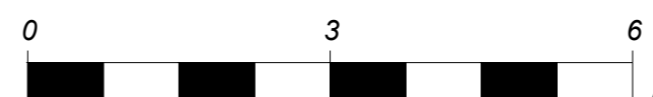


Rev.	Description	Date	Responsible
R01	First Issue	2025-06-13	BA

This document and its contents are confidential and it is intended solely for the use of the recipient(s) to whom it is addressed.
 All content, including drawings, designs, and other materials, are the intellectual property of Elements Green Trent Ltd.
 Any unauthorised use or distribution of this document without the prior written consent of Elements Green Trent Ltd (company number 13665201) is strictly prohibited.
 Registered Office: 1 Half Moon Street, London, England, W1J 7AY

	Drawing Title Figure 5.6 Illustrative Solar Array Plan, Elevation and Cross-Section
	Illustrative Purposes Only
Drawing No. UK003-PV-ENG-0-460-R00-5.06.2	
Designed by BA	Approved by OC
Date 2025-06-13	Scale 1:75
Dimensions in m	Paper Size A2 (594x420)
Sheet 2/2	

3m Pole* with Fixed camera, IR Sensor and LED light

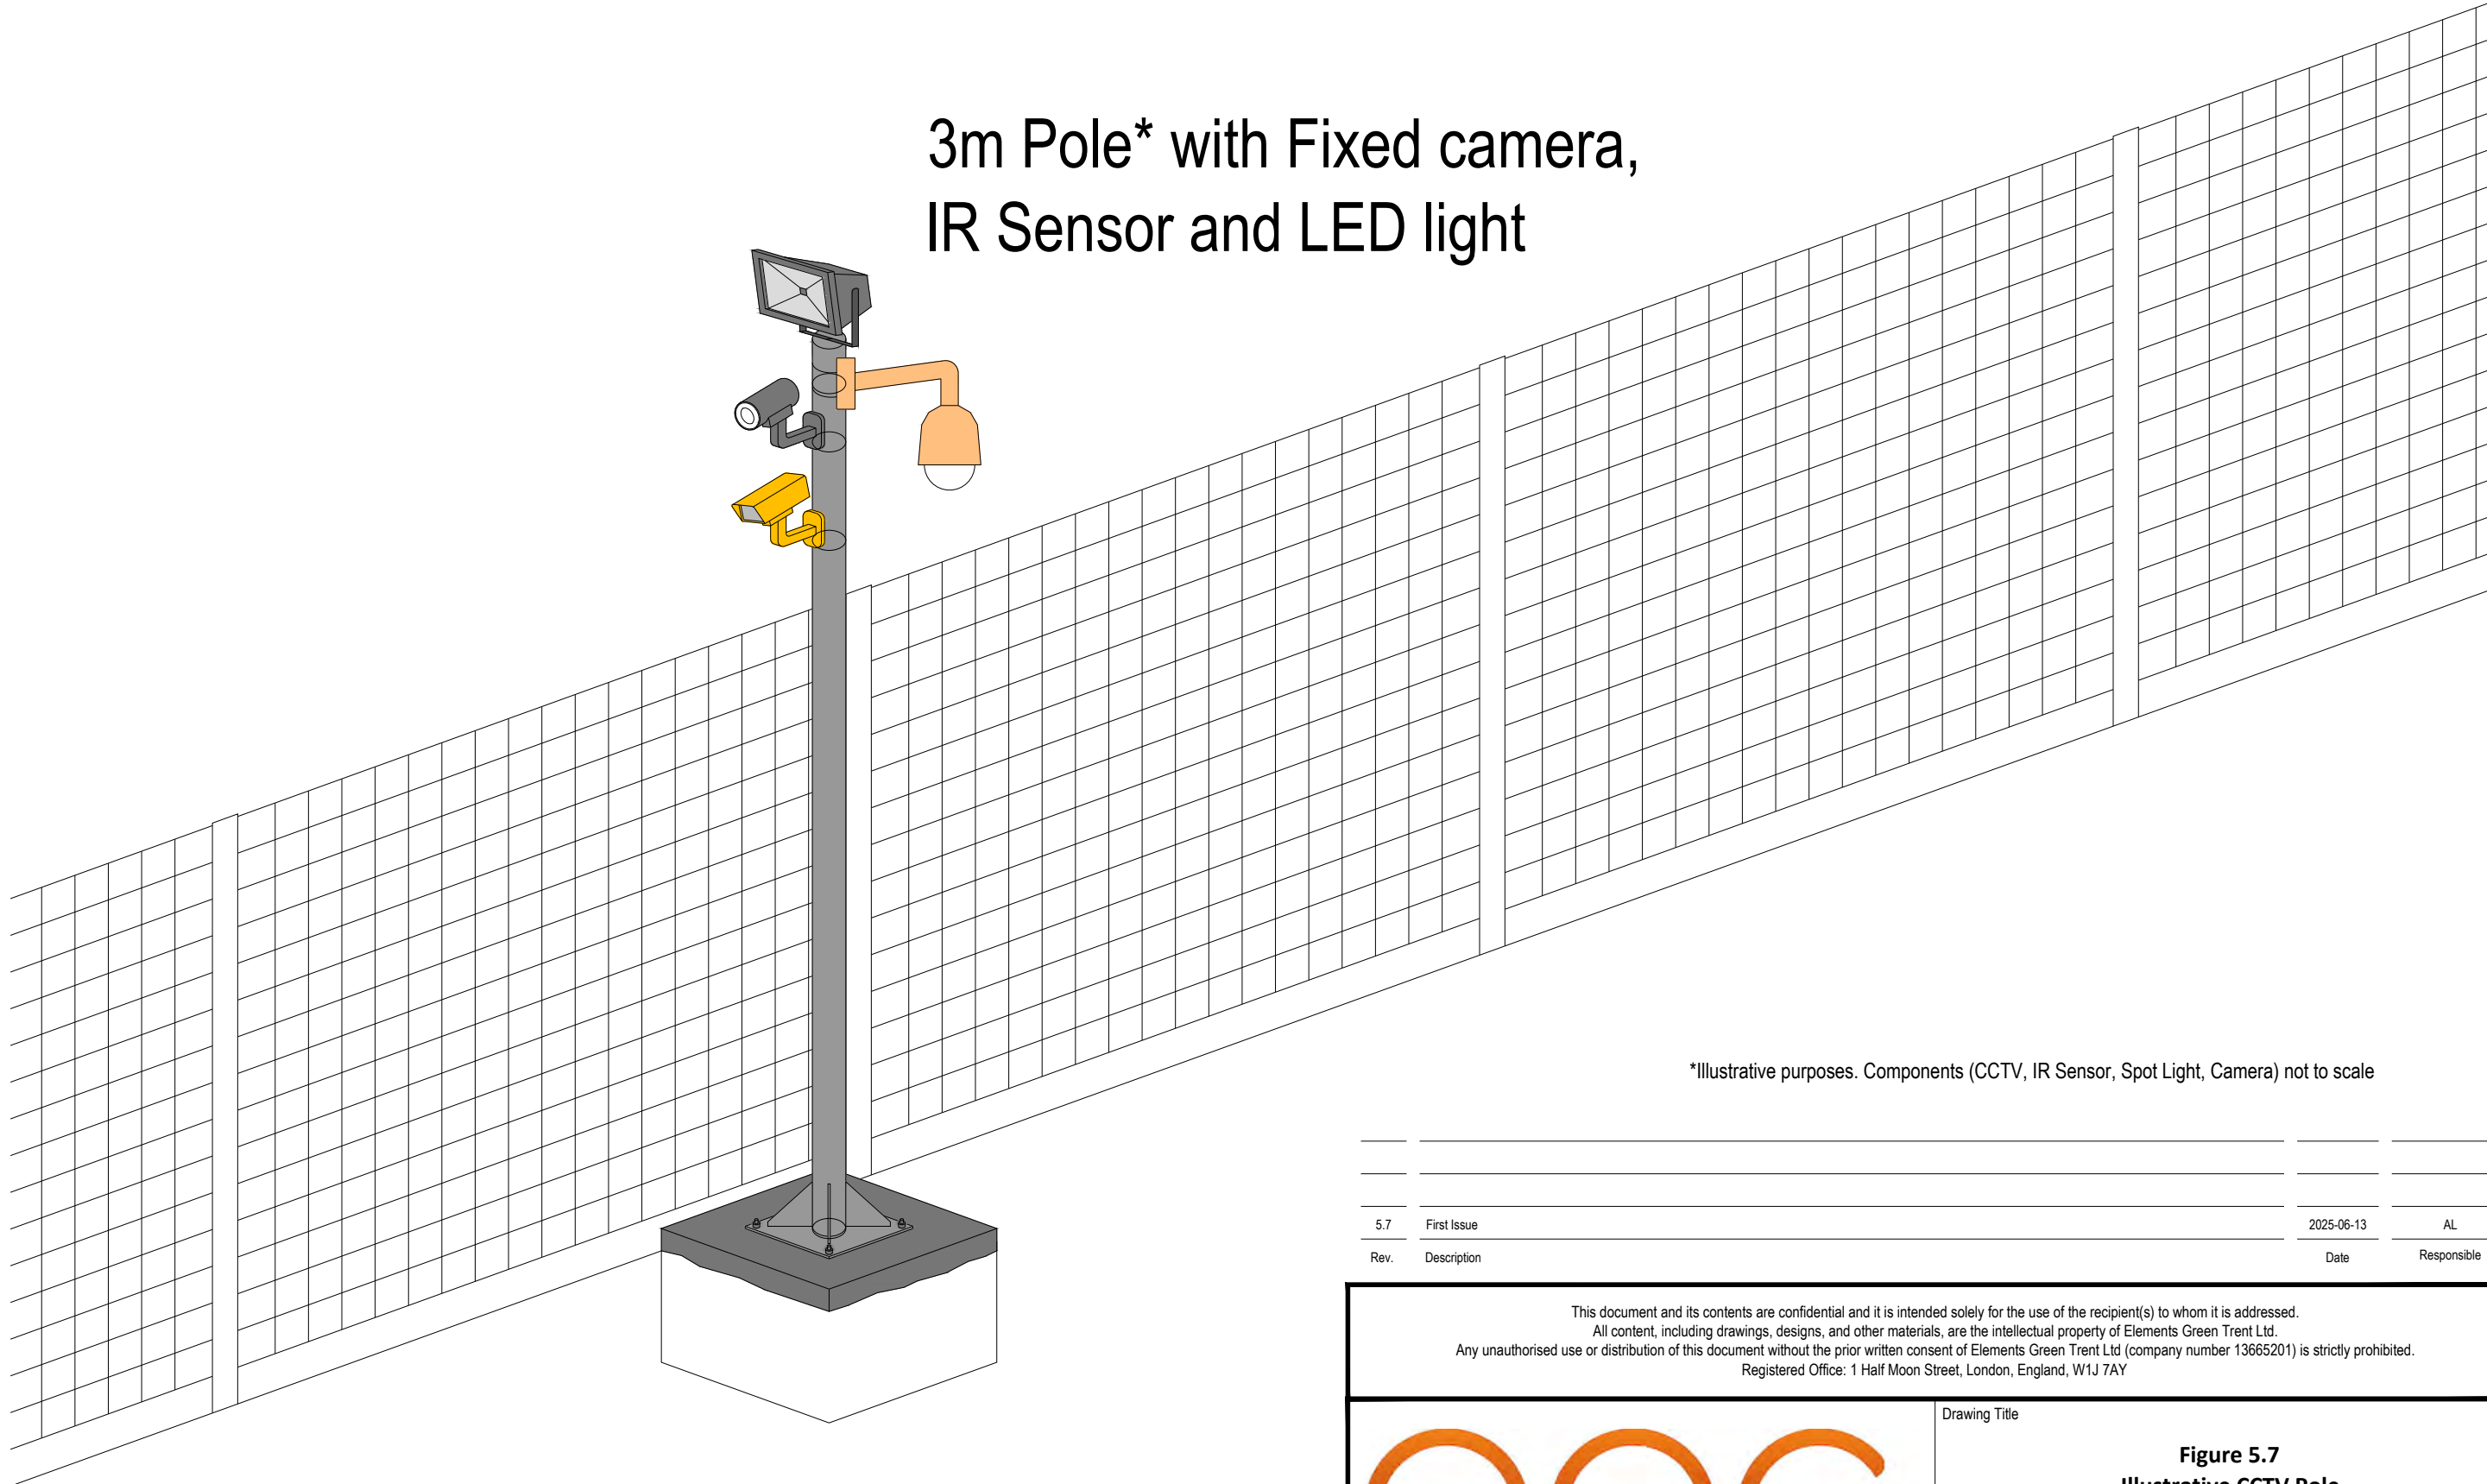

*Illustrative purposes. Components (CCTV, IR Sensor, Spot Light, Camera) not to scale

Rev.	Description	Date	Responsible
5.7	First Issue	2025-06-13	AL


This document and its contents are confidential and it is intended solely for the use of the recipient(s) to whom it is addressed.
 All content, including drawings, designs, and other materials, are the intellectual property of Elements Green Trent Ltd.
 Any unauthorised use or distribution of this document without the prior written consent of Elements Green Trent Ltd (company number 13665201) is strictly prohibited.
 Registered Office: 1 Half Moon Street, London, England, W1J 7AY




Drawing Title
**Figure 5.7
 Illustrative CCTV Pole**

Illustrative Purposes Only

Drawing No.
UK003-PV-ENG-0-460-R00-5.07

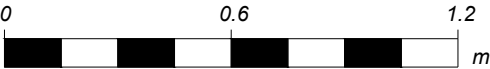


Designed by	Approved by	Date	Scale	Dimensions in	Paper Size	Sheet
AL	OC	2025-06-13	NA	-	A3 (420x297)	1/1

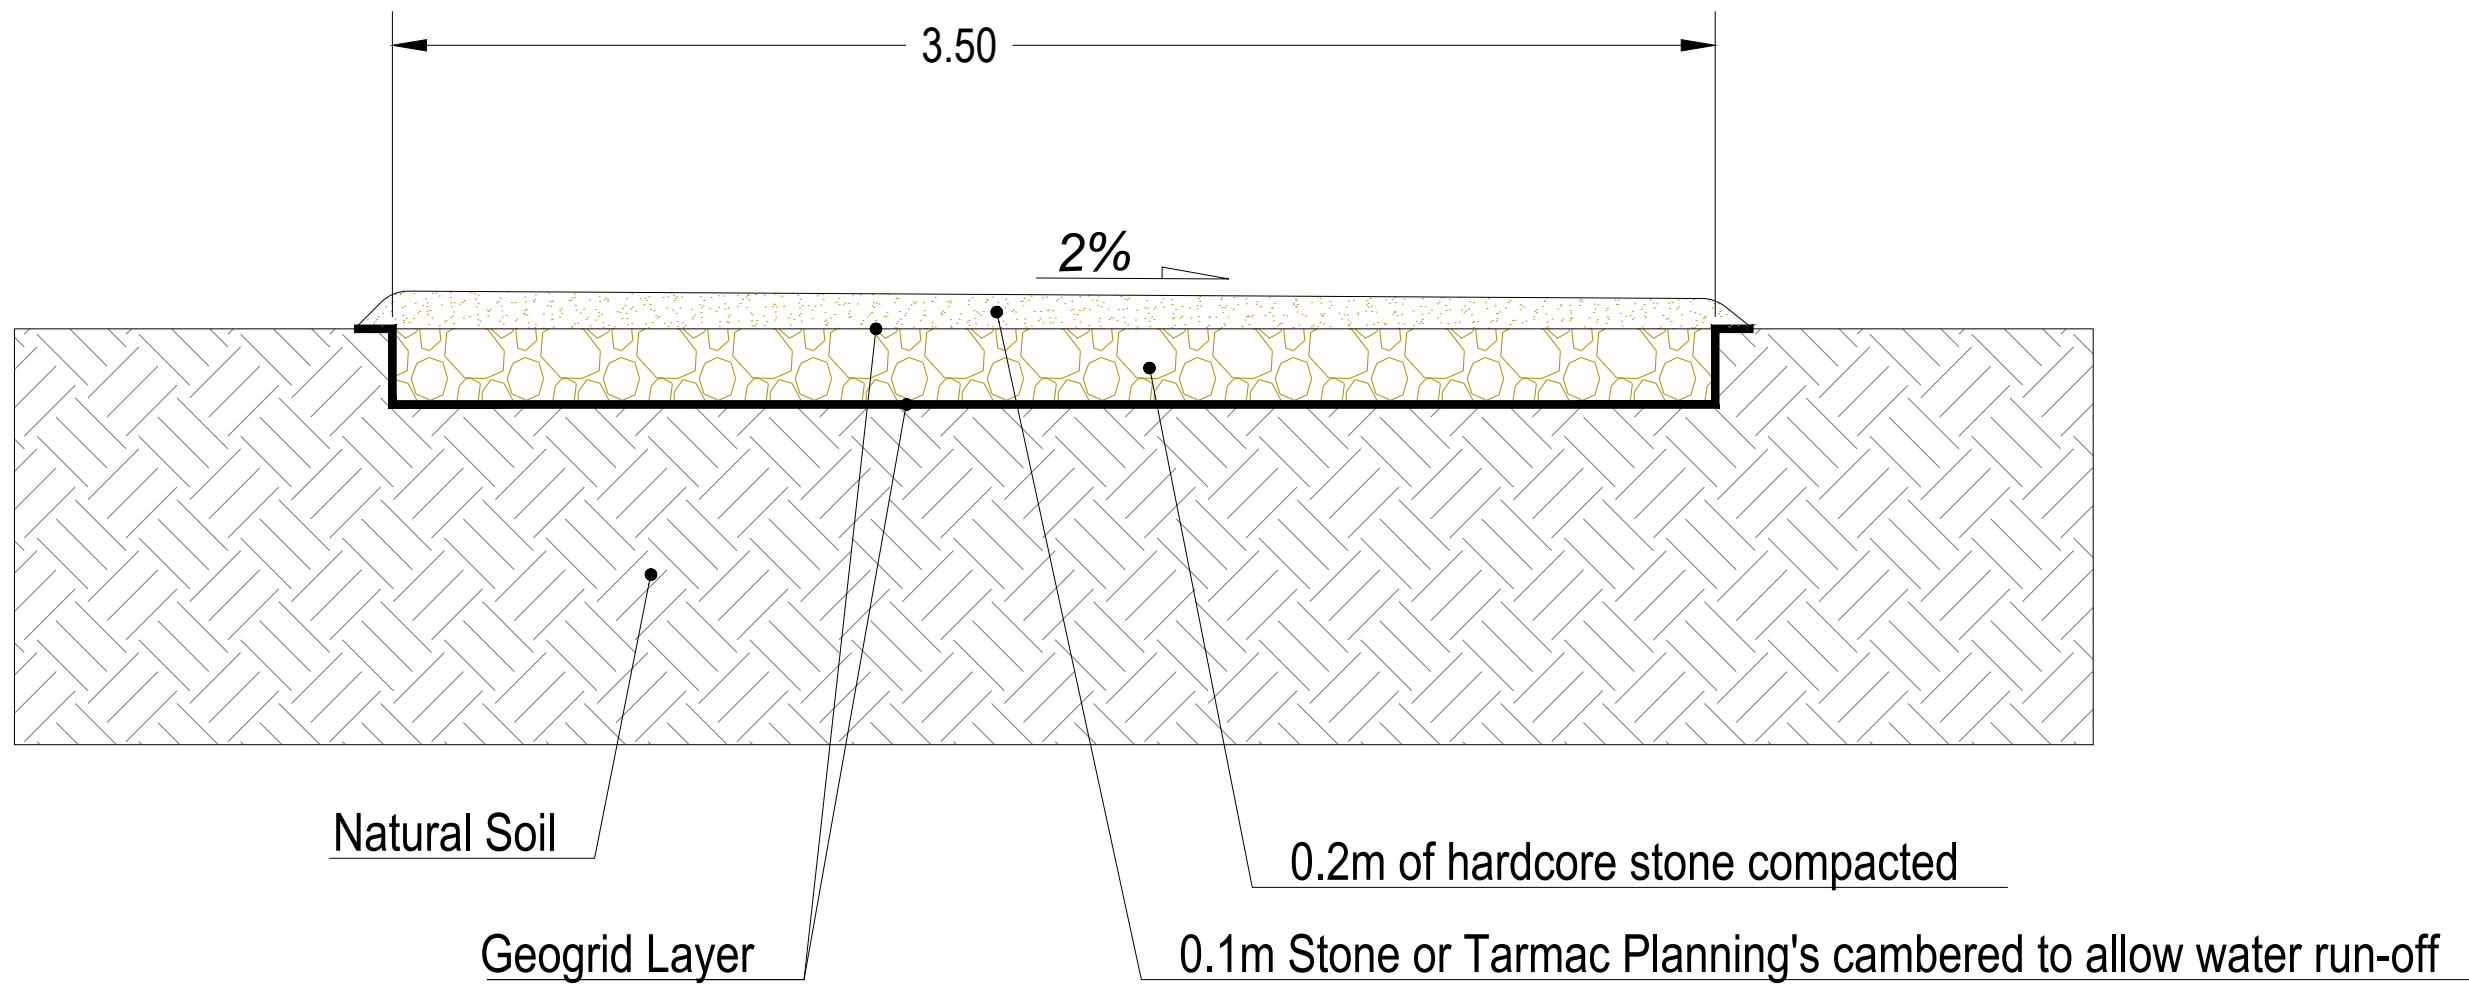

Rev.	Description	Date	Responsible
R01	First Issue	2025-06-13	AL

This document and its contents are confidential and it is intended solely for the use of the recipient(s) to whom it is addressed.
 All content, including drawings, designs, and other materials, are the intellectual property of Elements Green Trent Ltd.
 Any unauthorised use or distribution of this document without the prior written consent of Elements Green Trent Ltd (company number 13665201) is strictly prohibited.
 Registered Office: 1 Half Moon Street, London, England, W1J 7AY

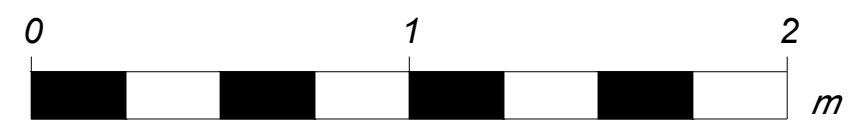

Solar & Biodiversity Park

Drawing Title


Figure 5.8
Illustrative Access Track Cross-Section

Illustrative Purposes Only


Drawing No. **UK003-PV-ENG-0-460-R00-5.08**

Designed by	Approved by	Date	Scale	Dimensions in	Paper Size	Sheet
AL	OC	2025-06-13	1:20	m	A3 (420x297)	1/1


LV Cable Route Trench
5 to 10 Circuits

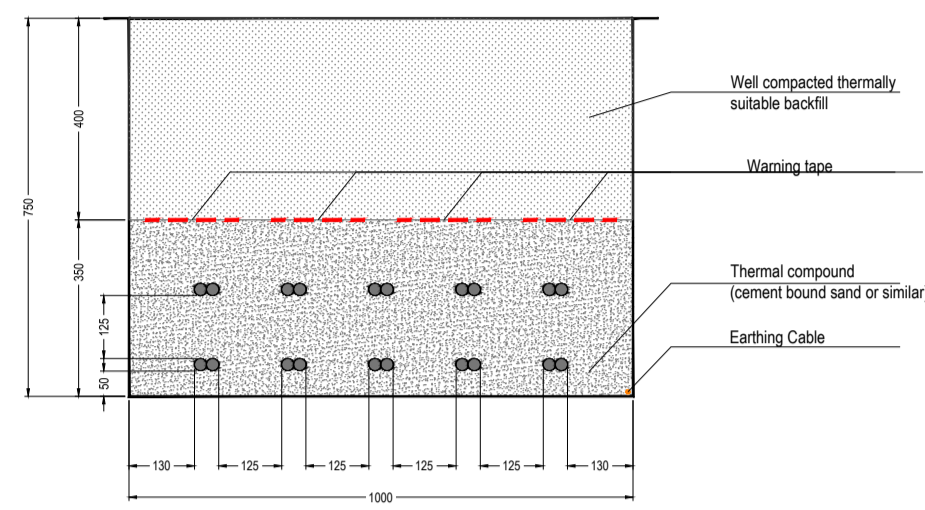


LV Cable Route Trench
1 to 5 Circuits

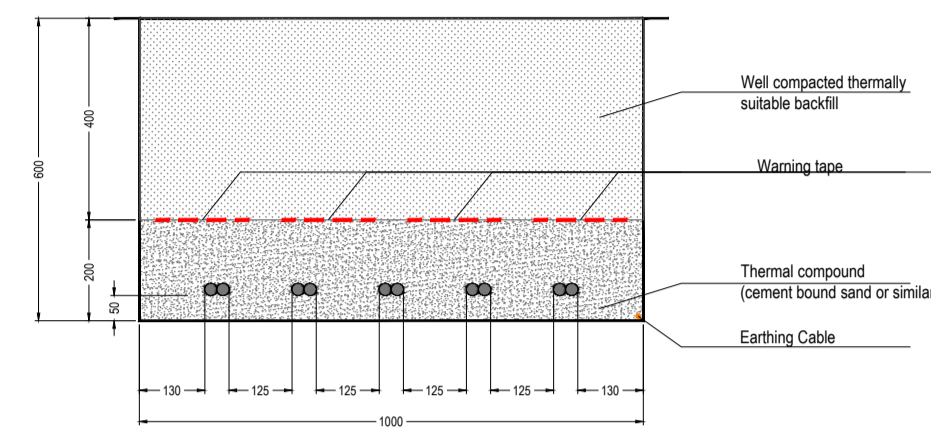

33kV Cable Route Trench
1 to 4 Circuits

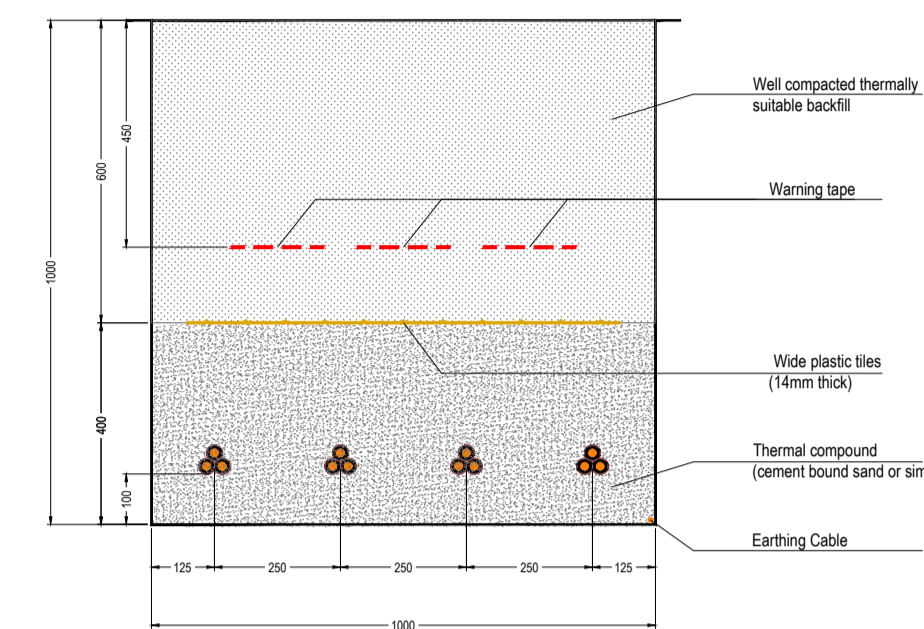


33kV Cable Route Trench
5 to 8 Circuits

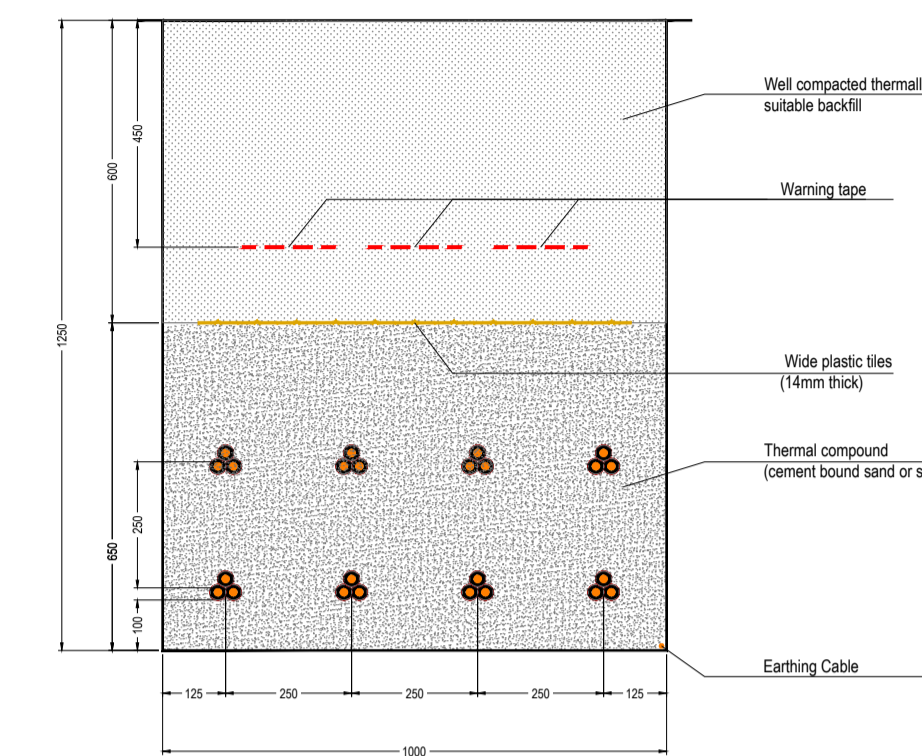


33kV Cable Route Trench (max. 7 circ.)

132kV Cable Route Trench (max. 4 circ.)

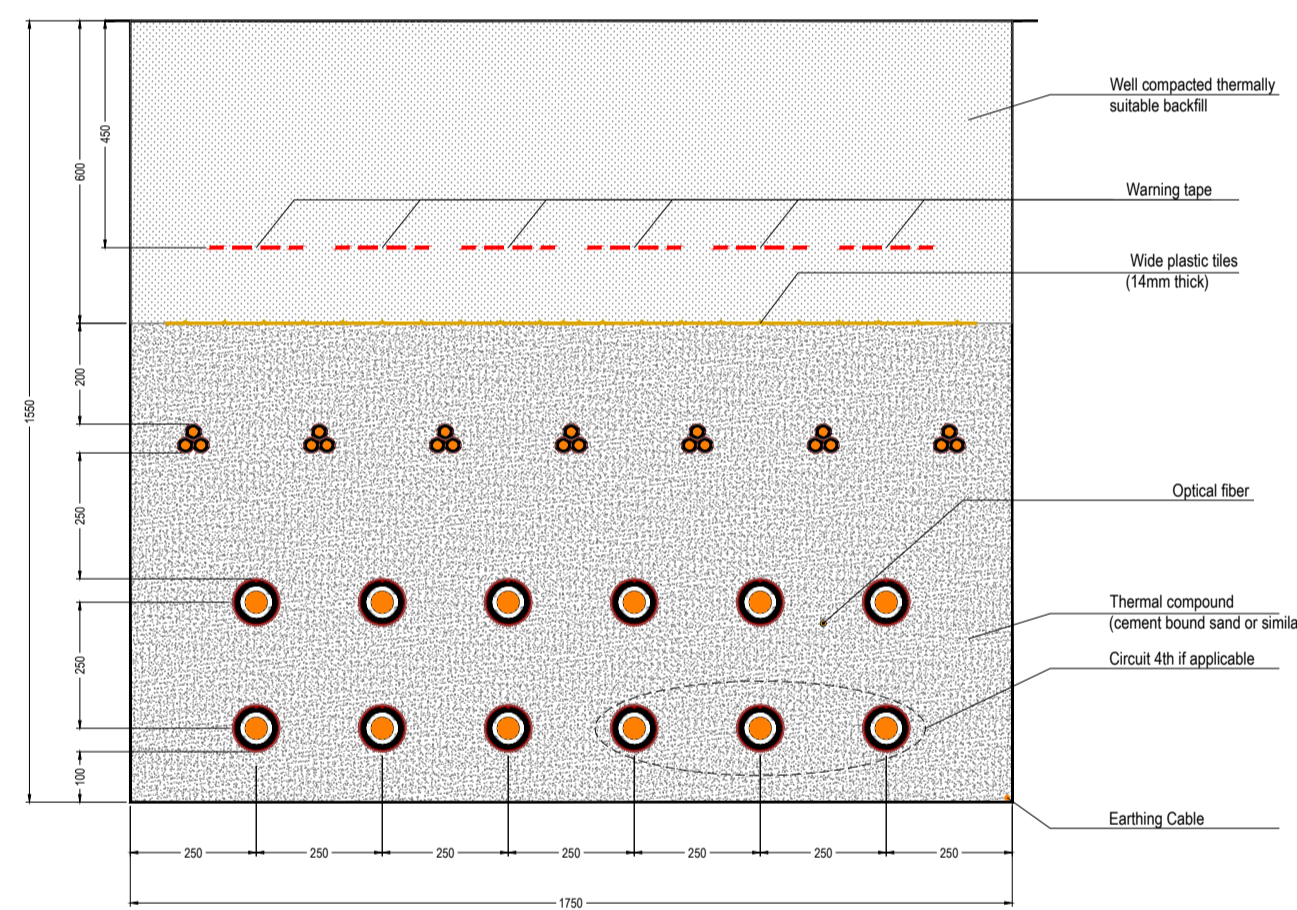


33kV Cable Route Trench (max. 7 circ.)

132kV Cable Route Trench (max. 2 circ.)

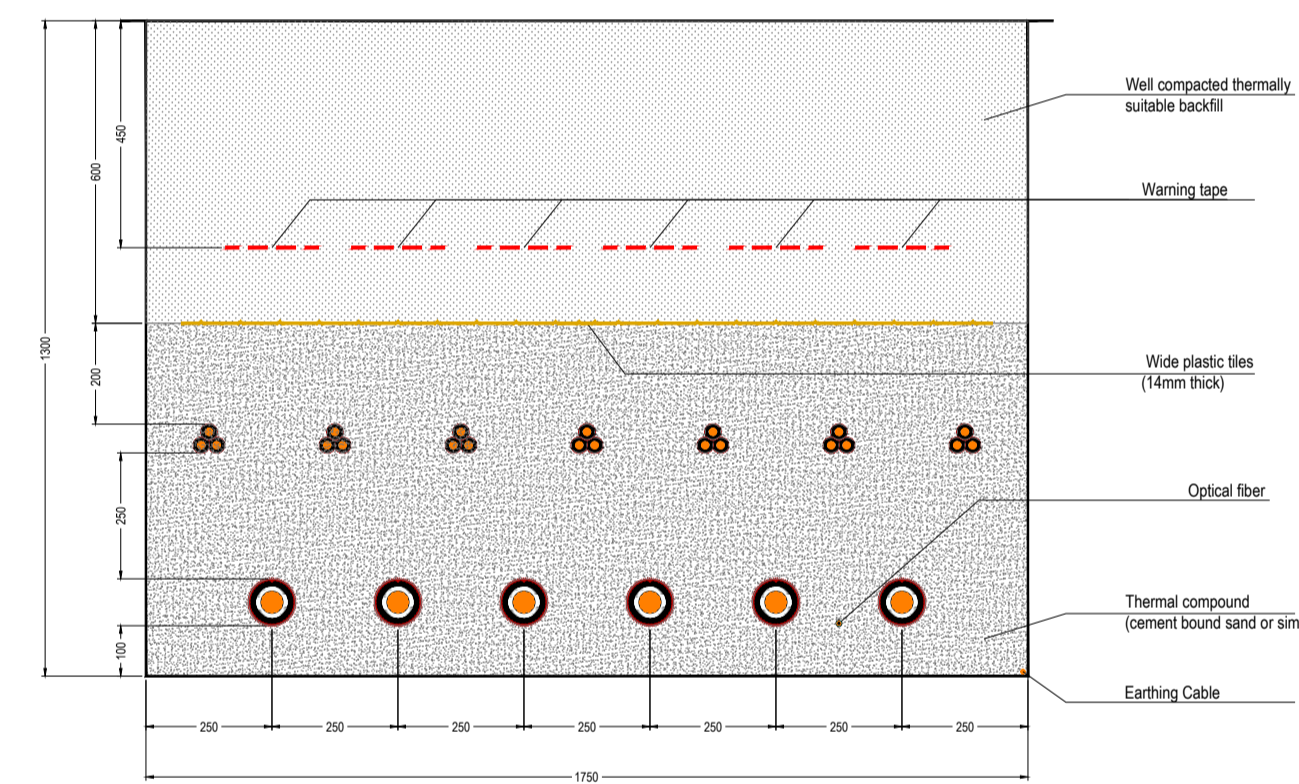


33kV Cable Route Trench


132kV Cable Route Trench

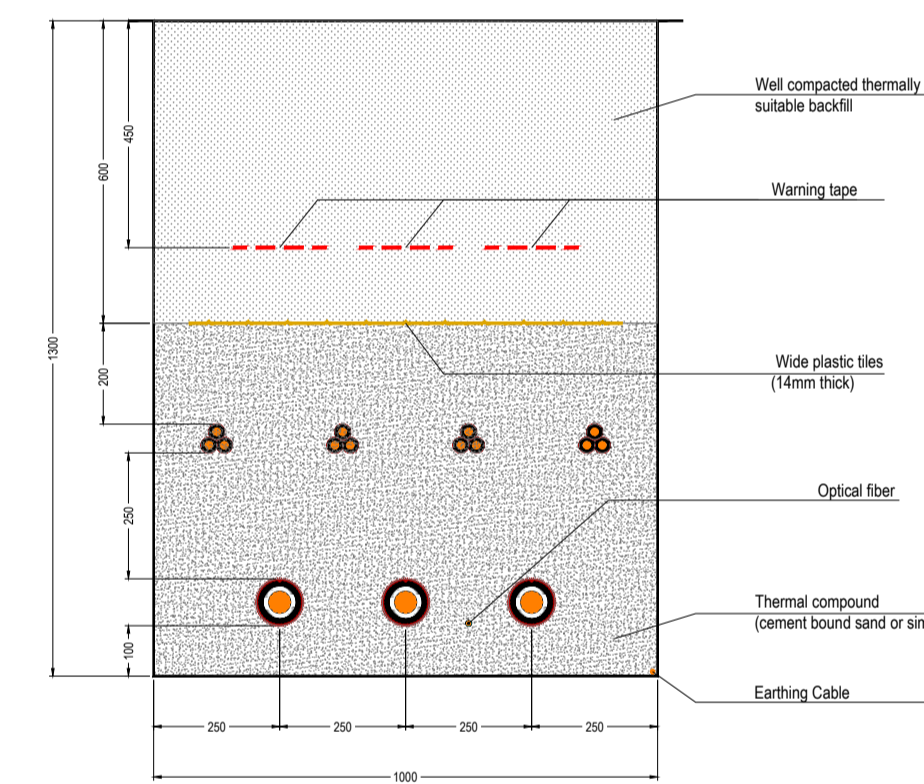


400kV Cable Route Trench

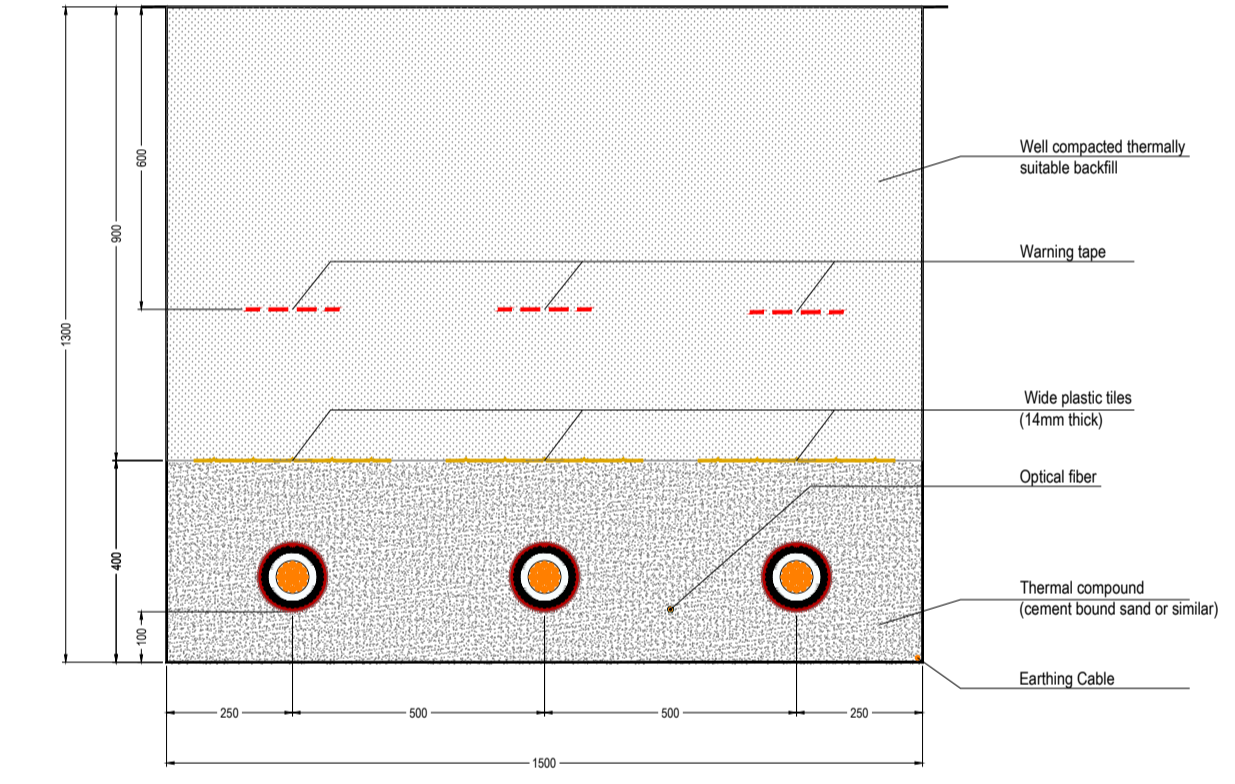


132kV Cable Route Trench
1 Circuit

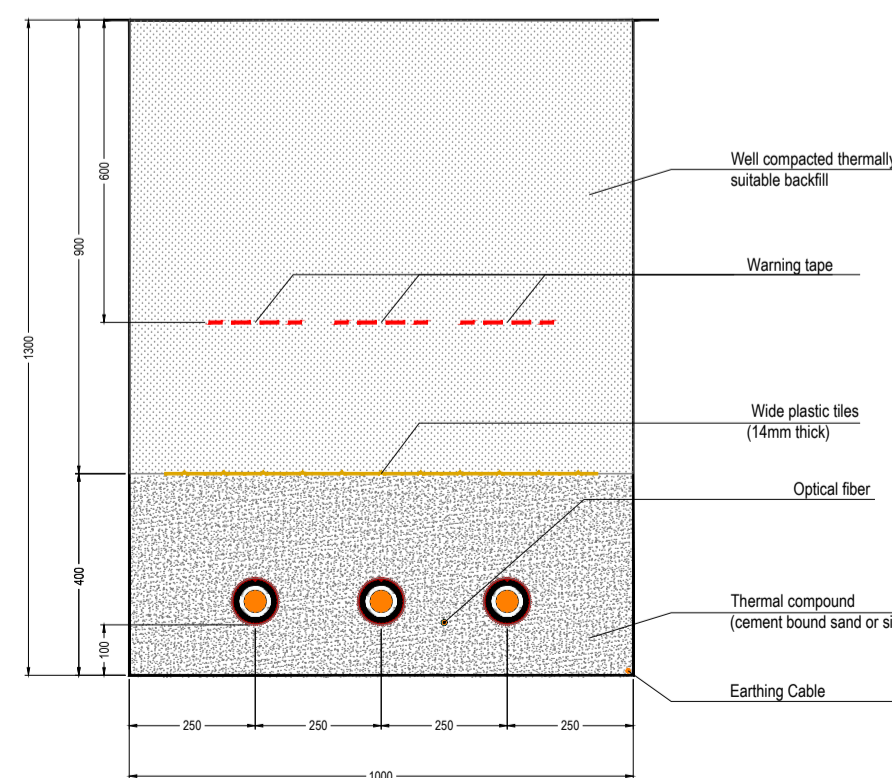

132kV Cable Route Trench
2 Circuits

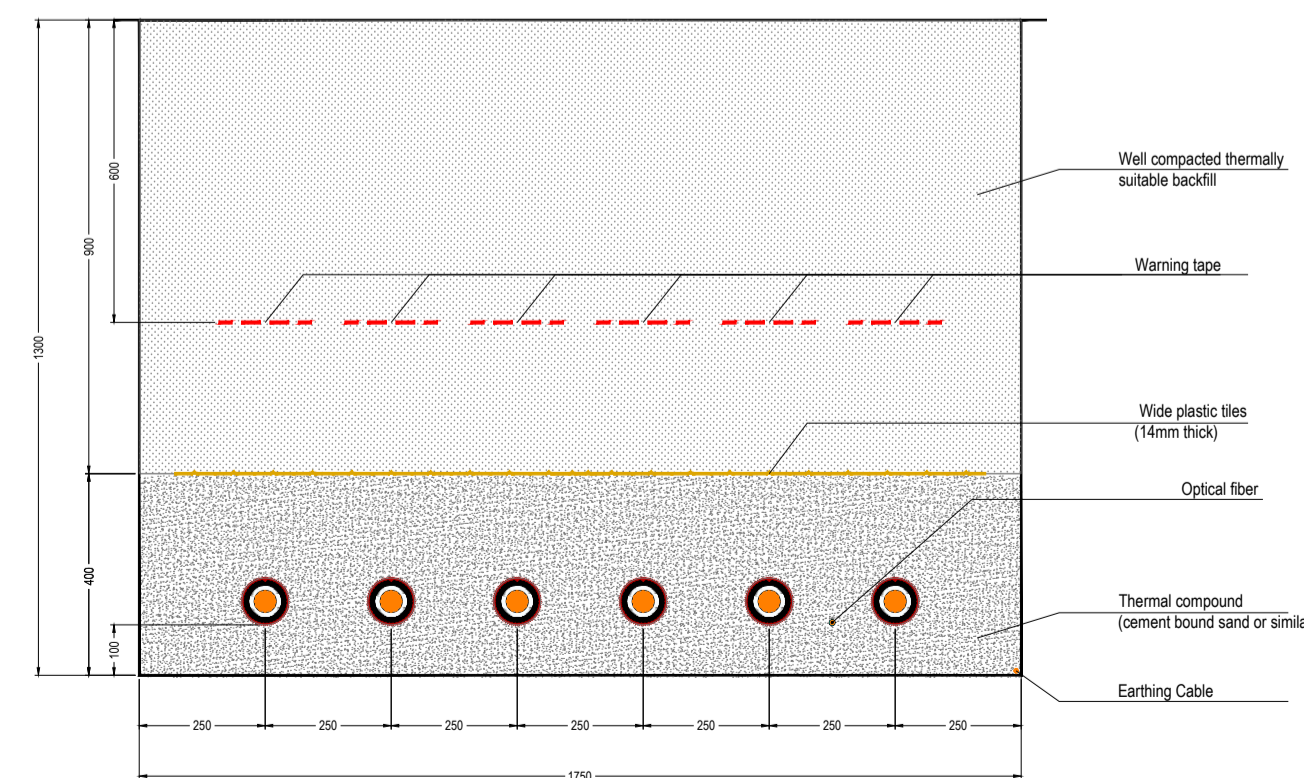

132kV Cable Route Trench
3 to 4 Circuits

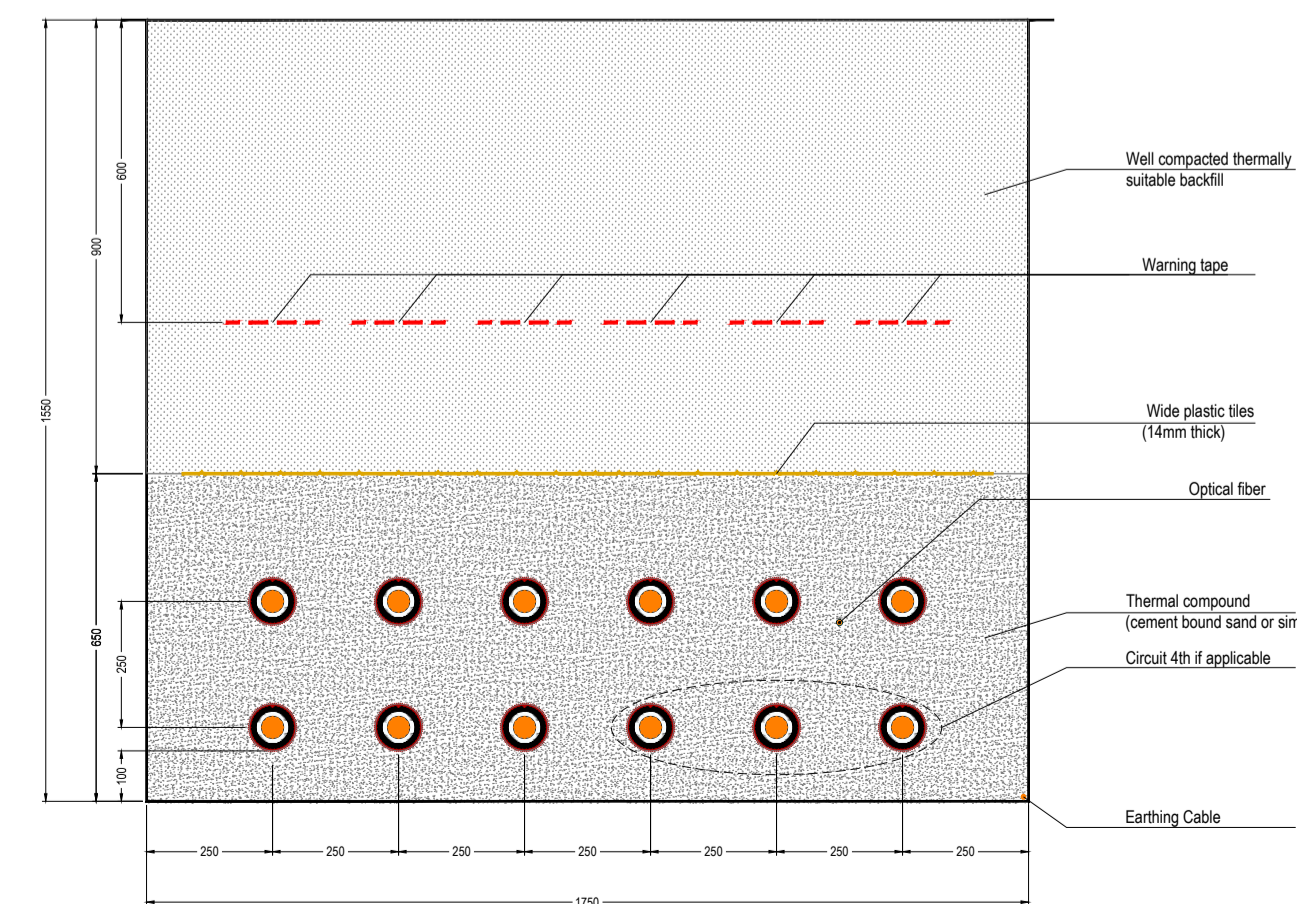




Rev	Description	Date	Responsible
R01	First Issue	2025-06-13	AL

This document and its contents are confidential and it is intended solely for the use of the recipient(s) to whom it is addressed. All content, including drawings, designs, and other materials, are the intellectual property of Elements Green Trent Ltd. Any unauthorised use or distribution of this document without the prior written consent of Elements Green Trent Ltd (company number 13062071) is strictly prohibited. Registered Office: 1 Half Moon Street, London, England, W1J 7AY

Figure 5.9
Illustrative Cable Trench Cross-Section

Illustrative Purposes Only

Drawing No: **UK003-PV-ENG-0-460-R00-5.09**

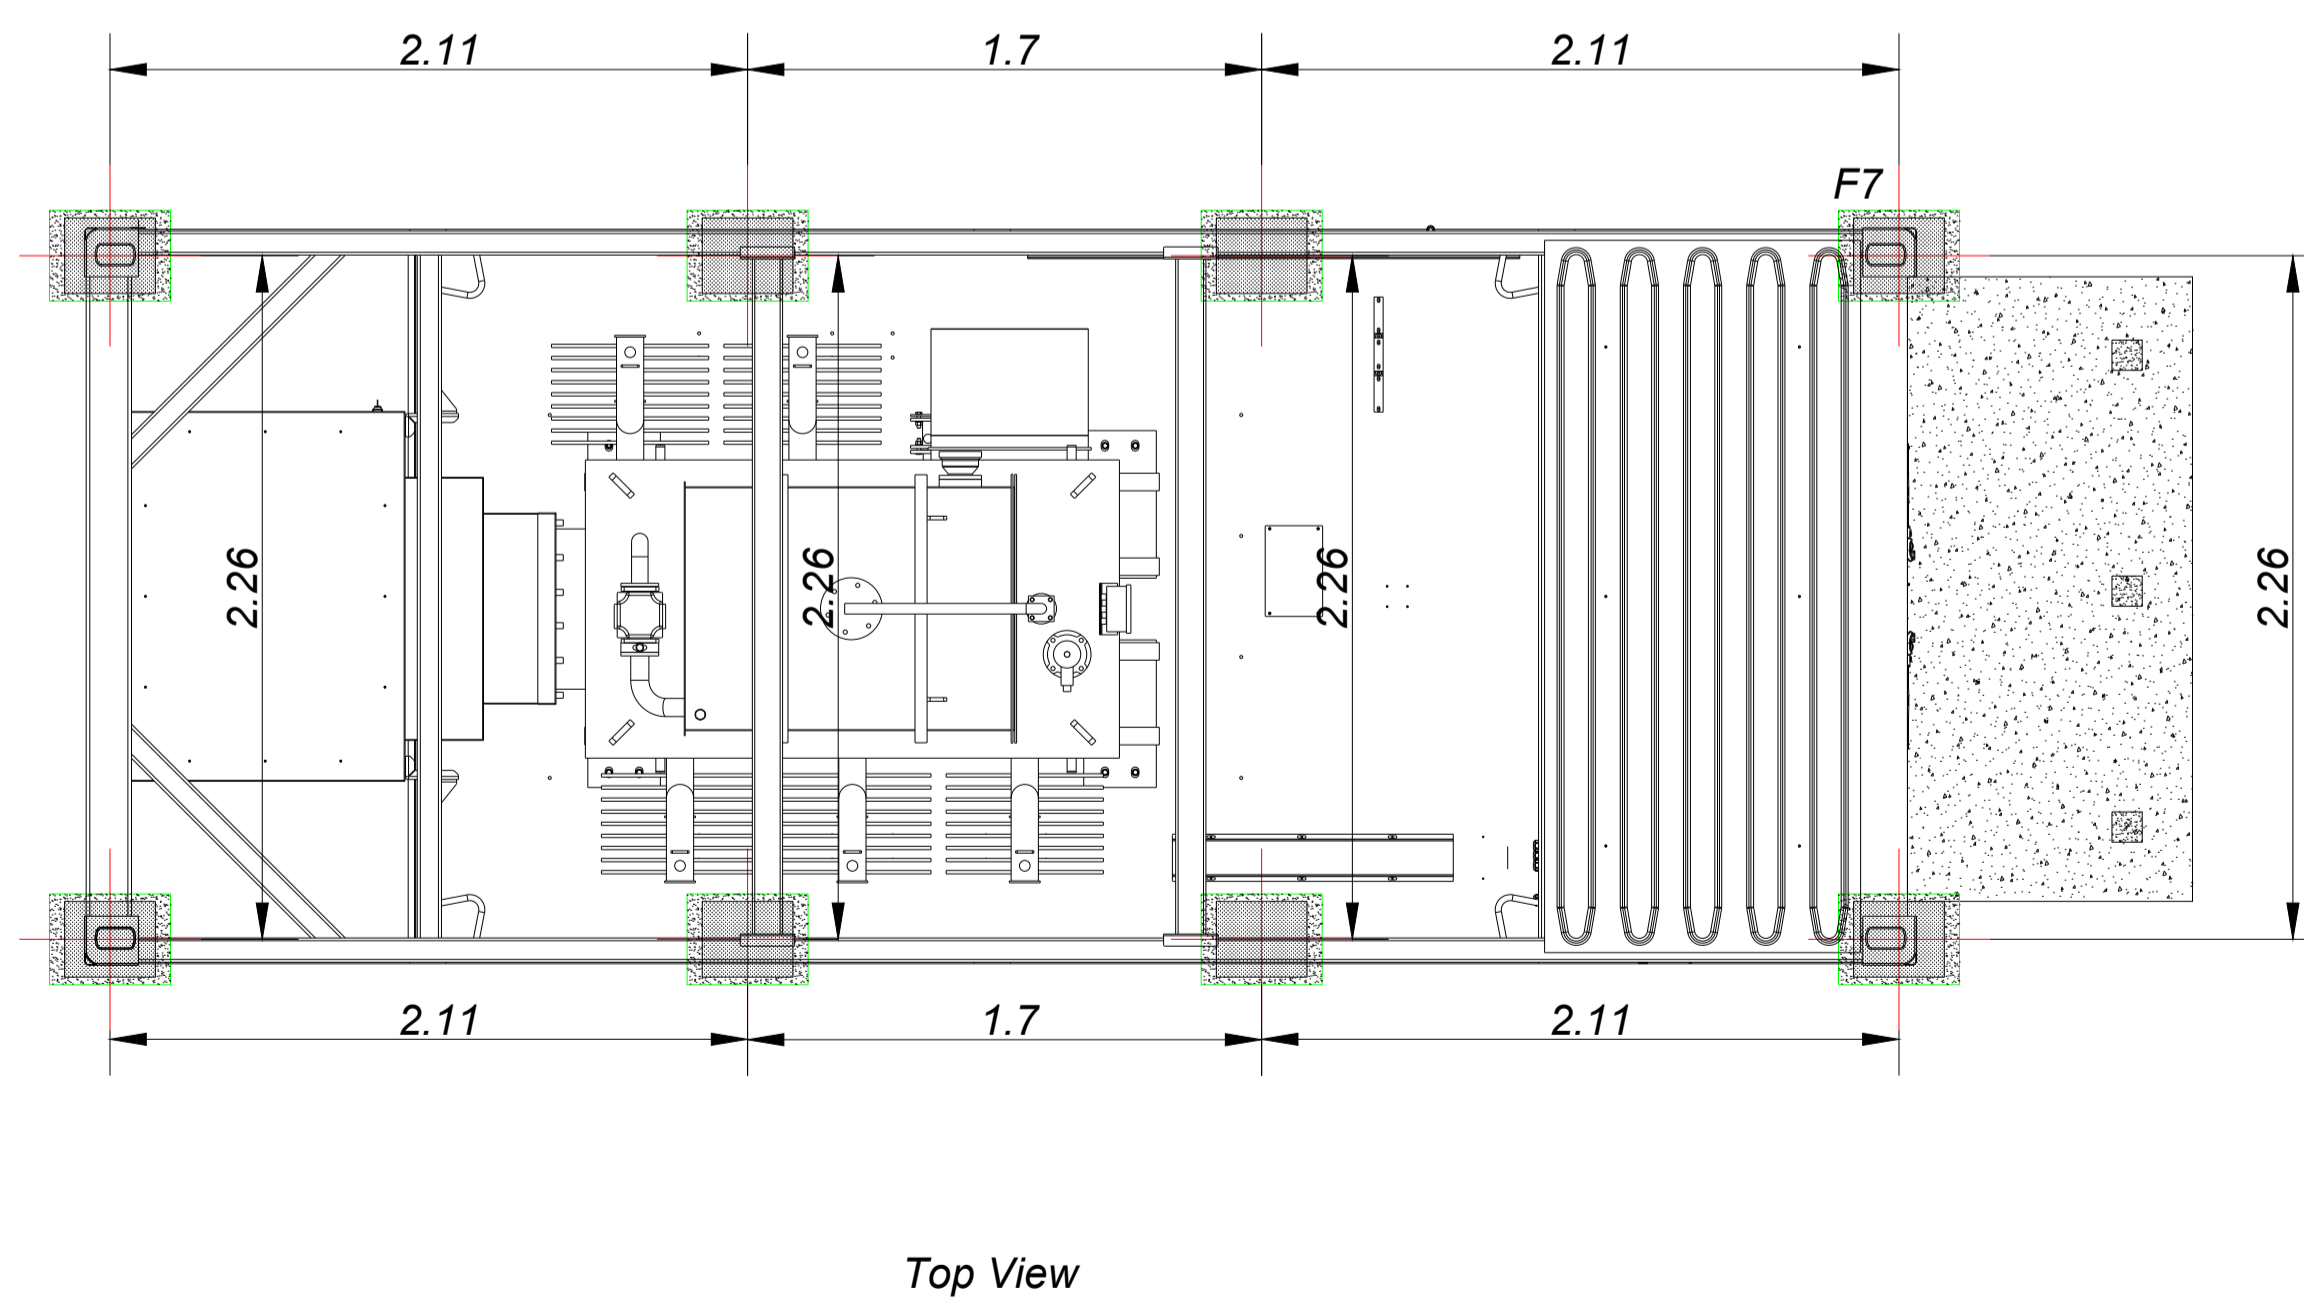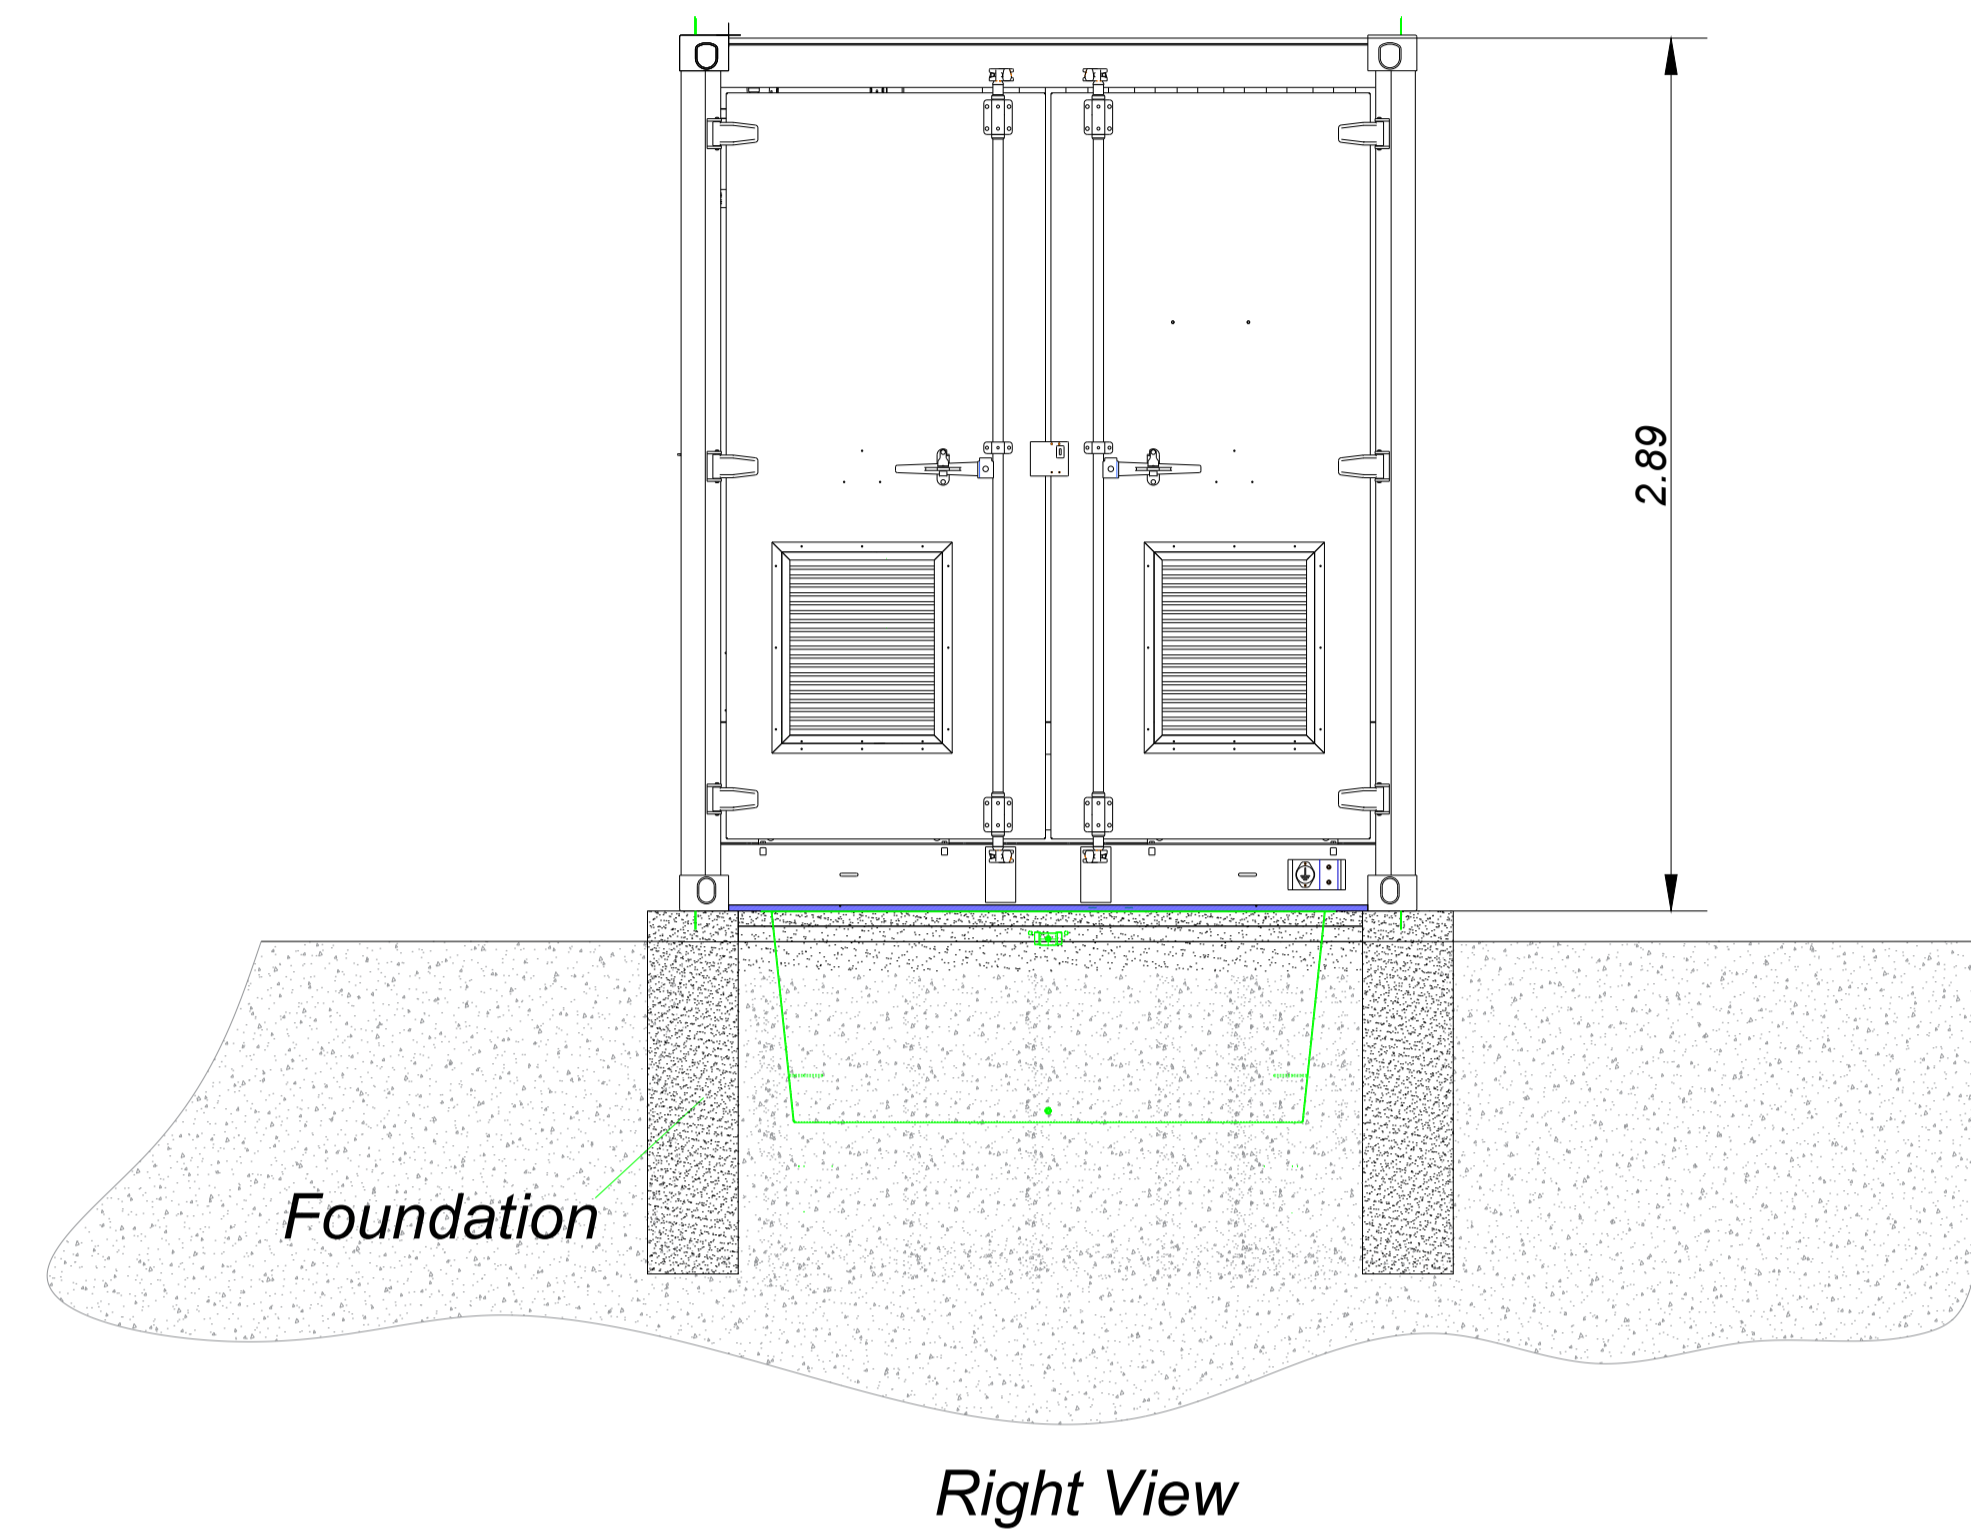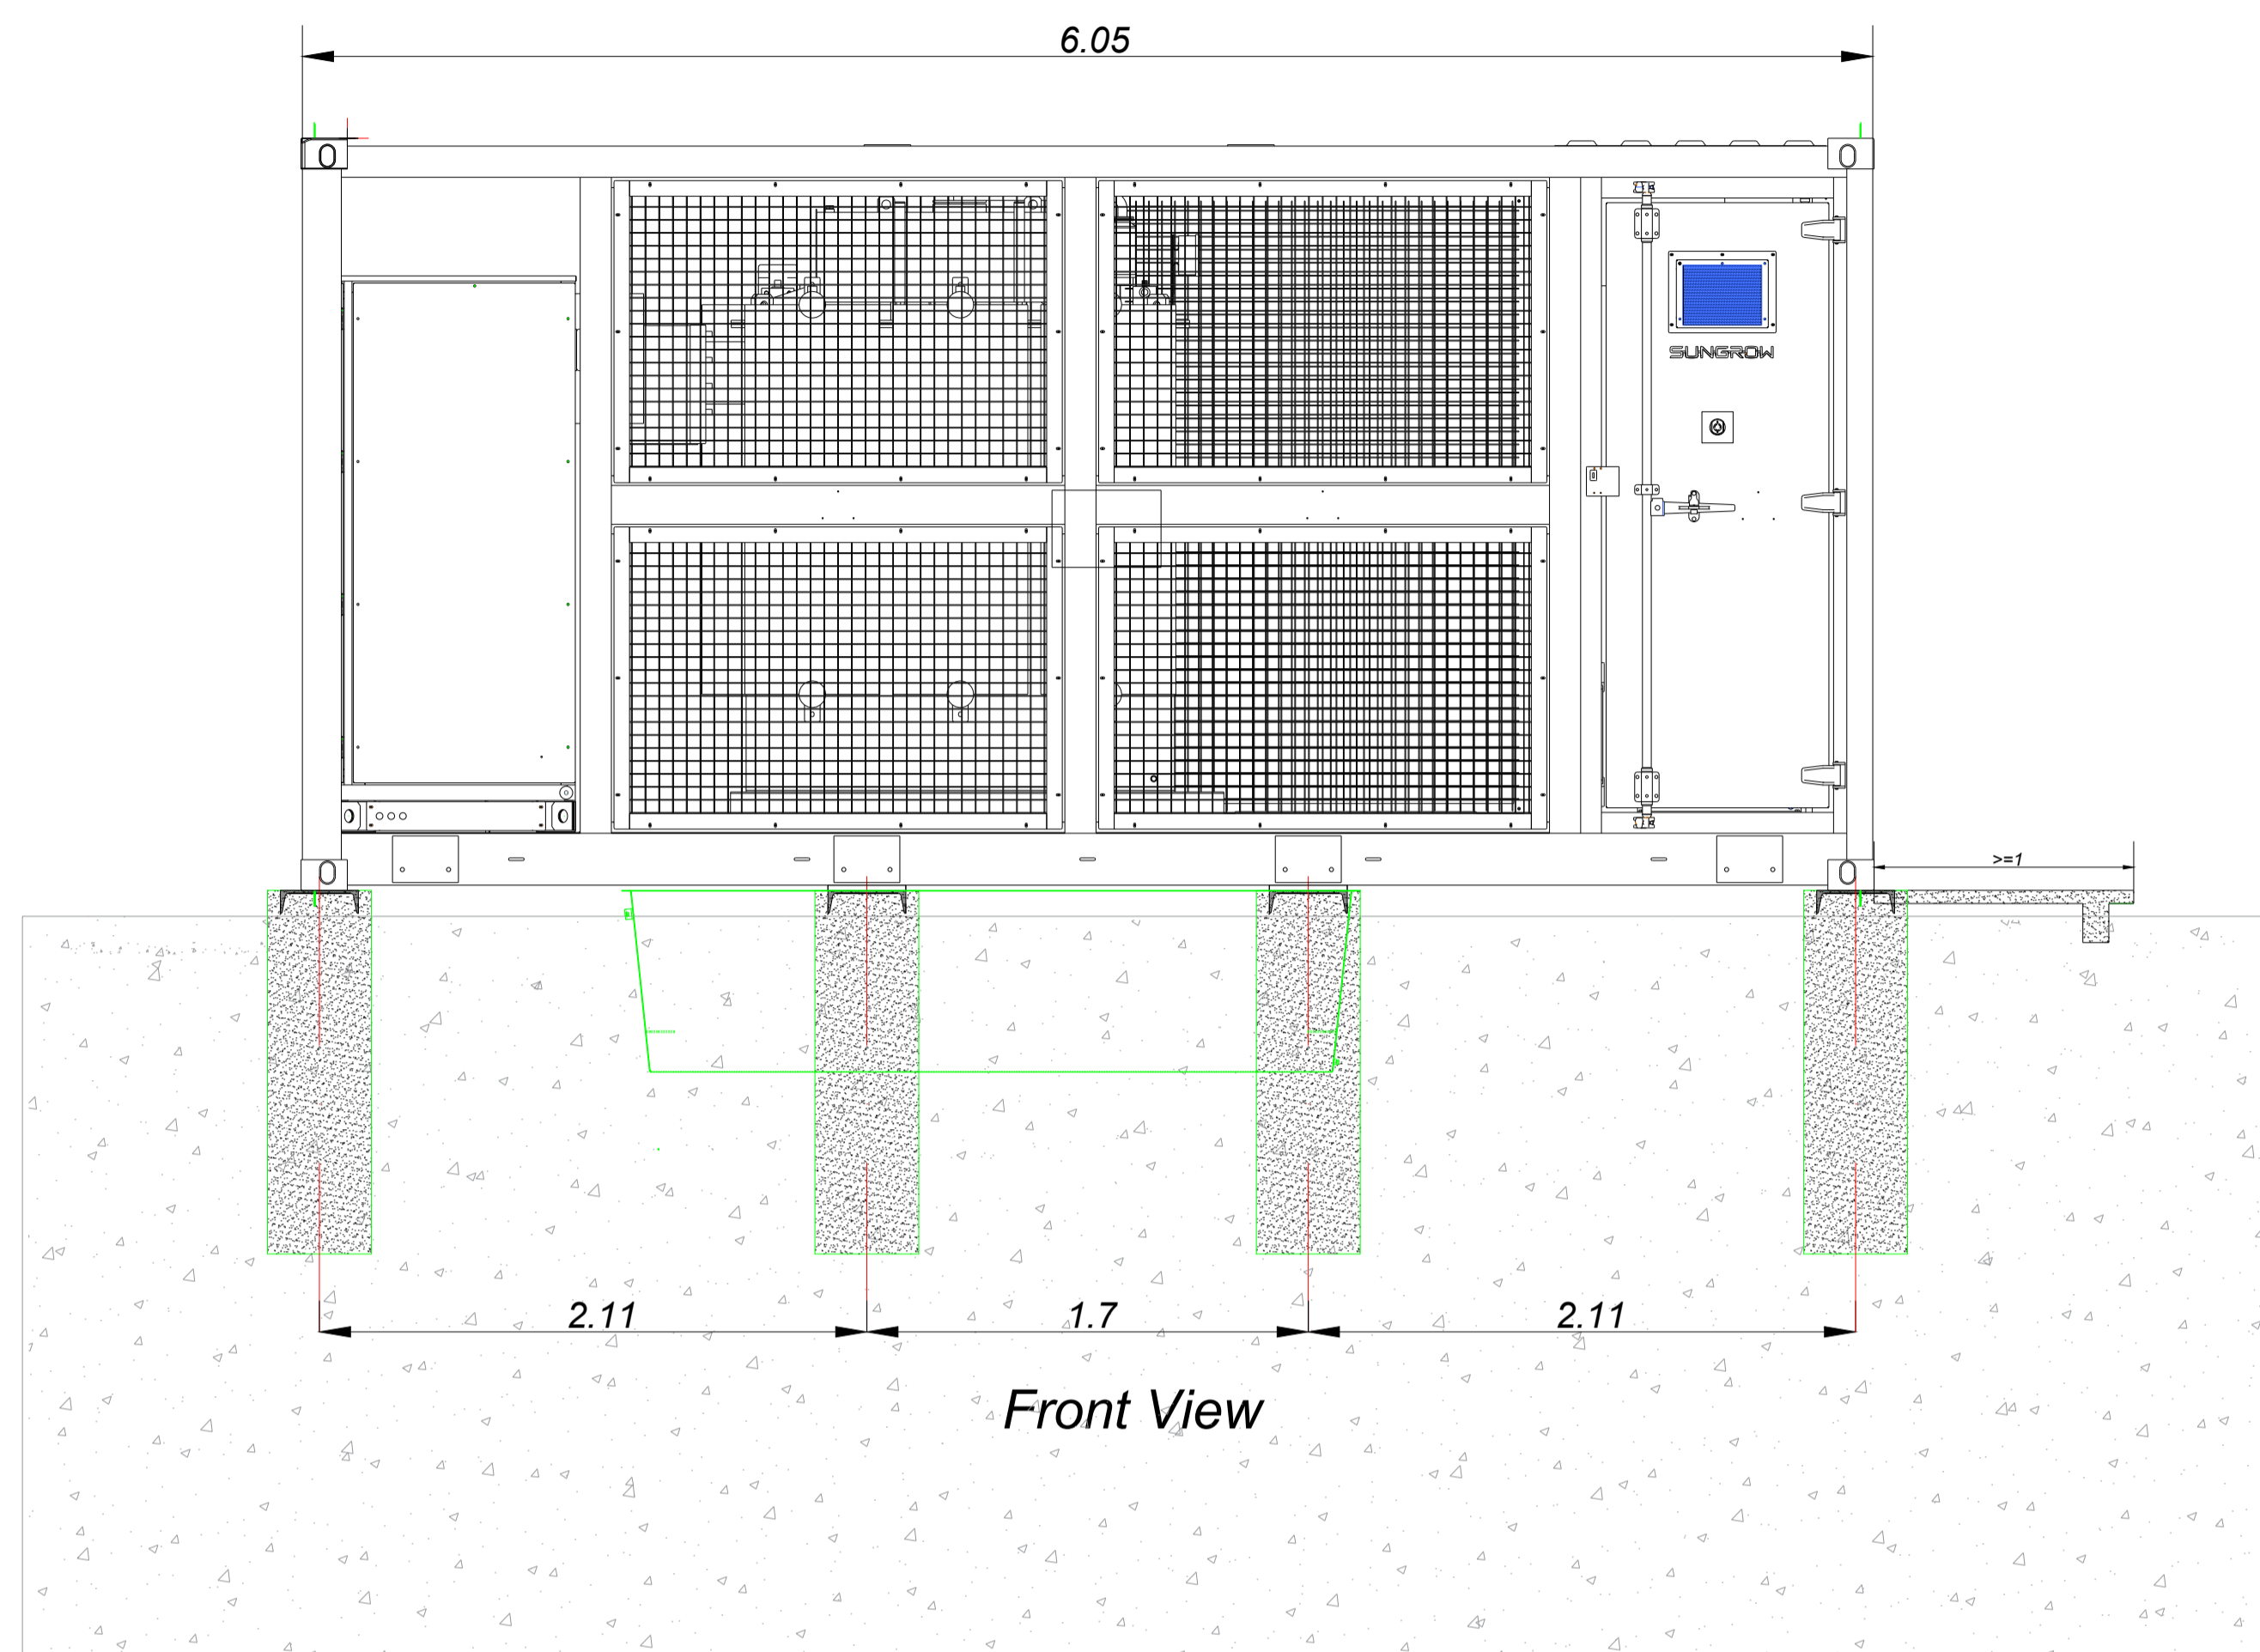

Rev.	Description	Date	Responsible
R01	First Issue	2025-06-16	AL

This document and its contents are confidential and it is intended solely for the use of the recipient(s) to whom it is addressed. All content, including drawings, designs, and other materials, are the intellectual property of Elements Green Trent Ltd. Any unauthorised use or distribution of this document without the prior written consent of Elements Green Trent Ltd (company number 13065201) is strictly prohibited. Registered Office: 1 Half Moon Street, London, England, W1J 7AY







Drawing Title

Figure 5.10
Illustrative Inverter/Transformer Elevations

Illustrative Purposes Only

Drawing No. **UK003-PV-ENG-0-460-R00-5.10**

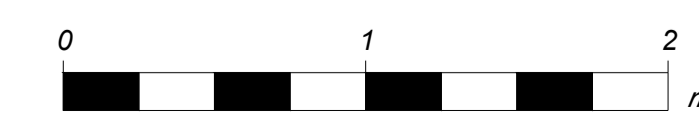

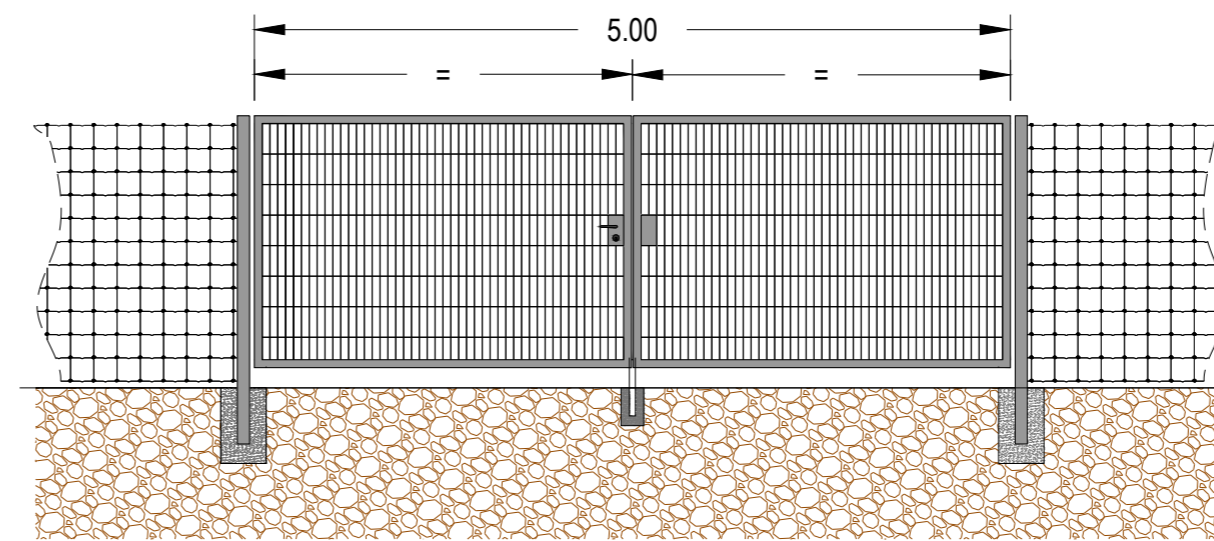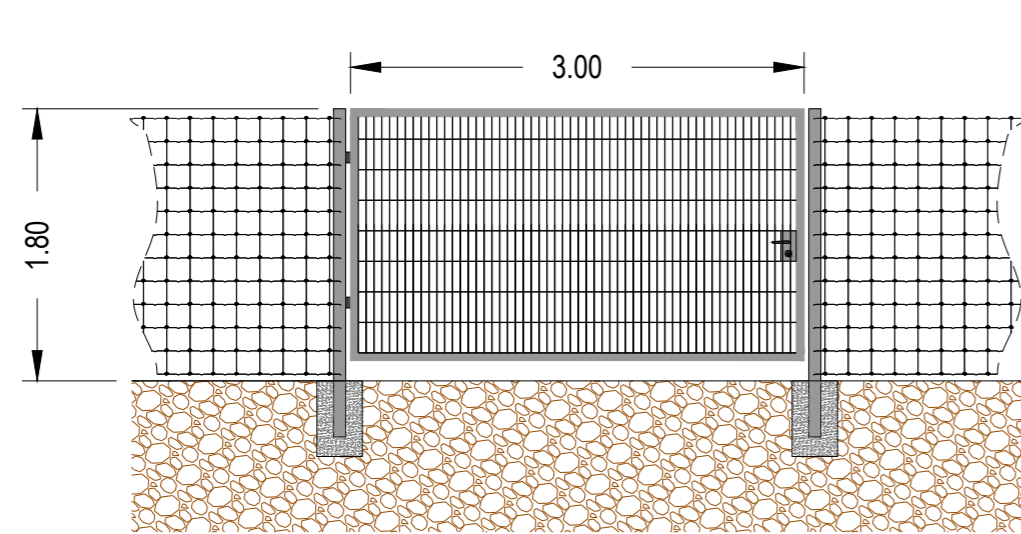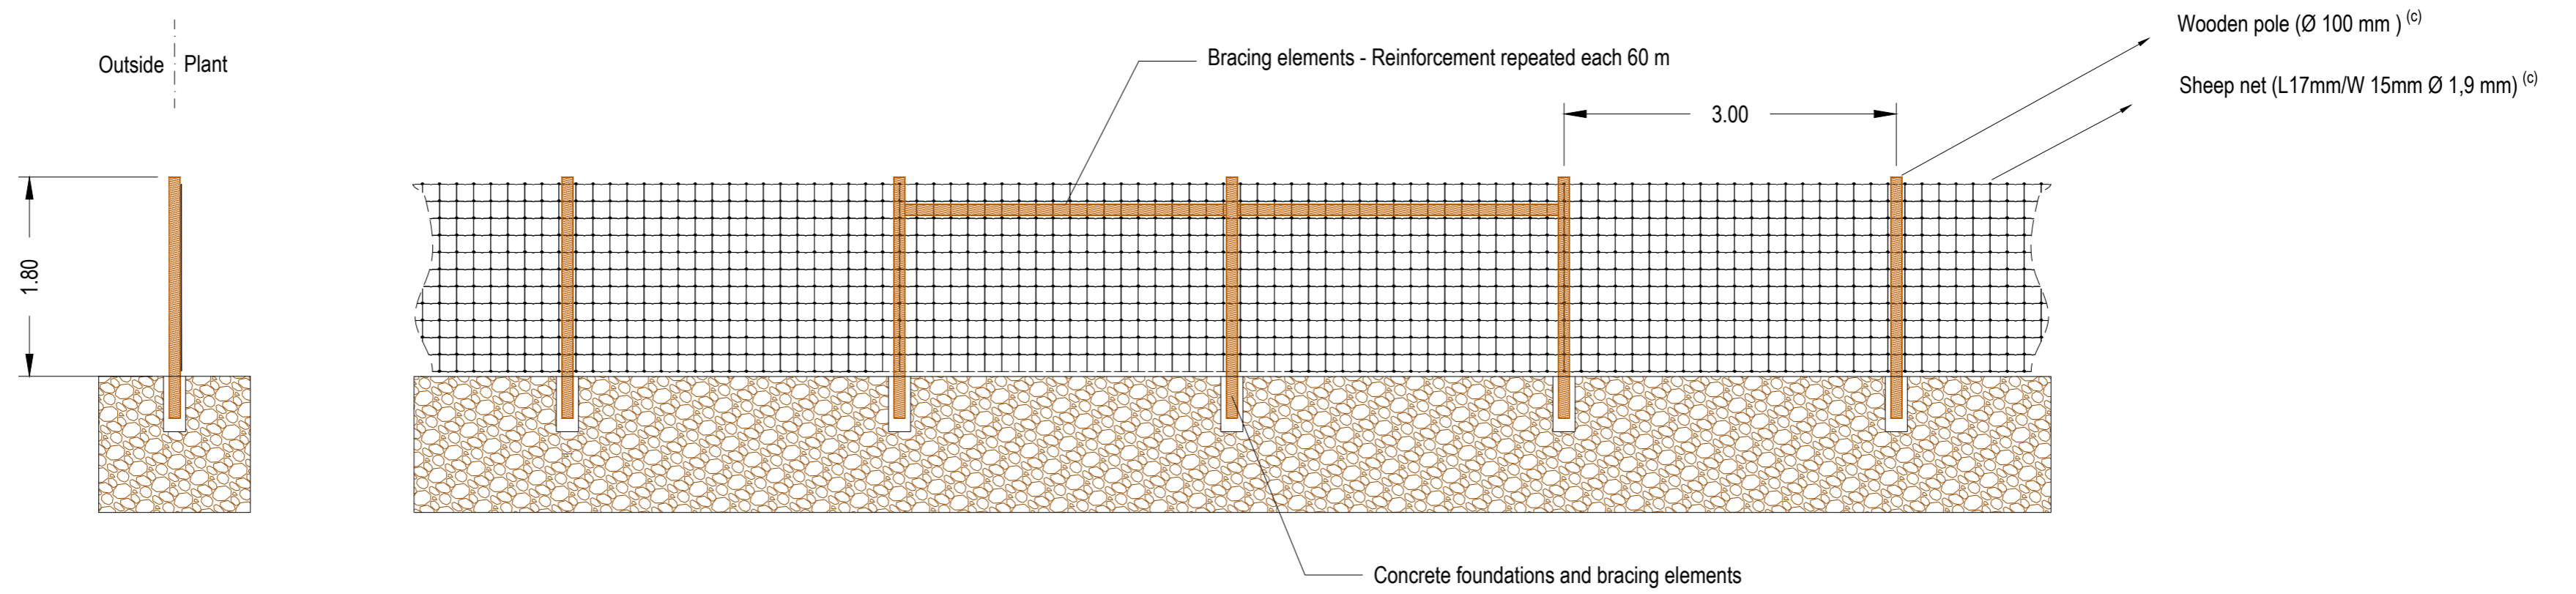

Rev.	Description	Date	Responsible
R01	First Issue	2025-06-12	AL

This document and its contents are confidential and it is intended solely for the use of the recipient(s) to whom it is addressed.
 All content, including drawings, designs, and other materials, are the intellectual property of Elements Green Trent Ltd.
 Any unauthorised use or distribution of this document without the prior written consent of Elements Green Trent Ltd (company number 13665201) is strictly prohibited.
 Registered Office: 1 Half Moon Street, London, England, W1J 7AY




Drawing Title
Figure 5.11
Illustrative Fence and Gate Elevations


Illustrative Purposes Only

Drawing No.
UK003-PV-ENG-0-460-R00-5.11

Designed by	Approved by	Date	Scale	Dimensions in	Paper Size	Sheet
AL	OC	2025-06-12	1:50	m	A2 (594x420)	1/1


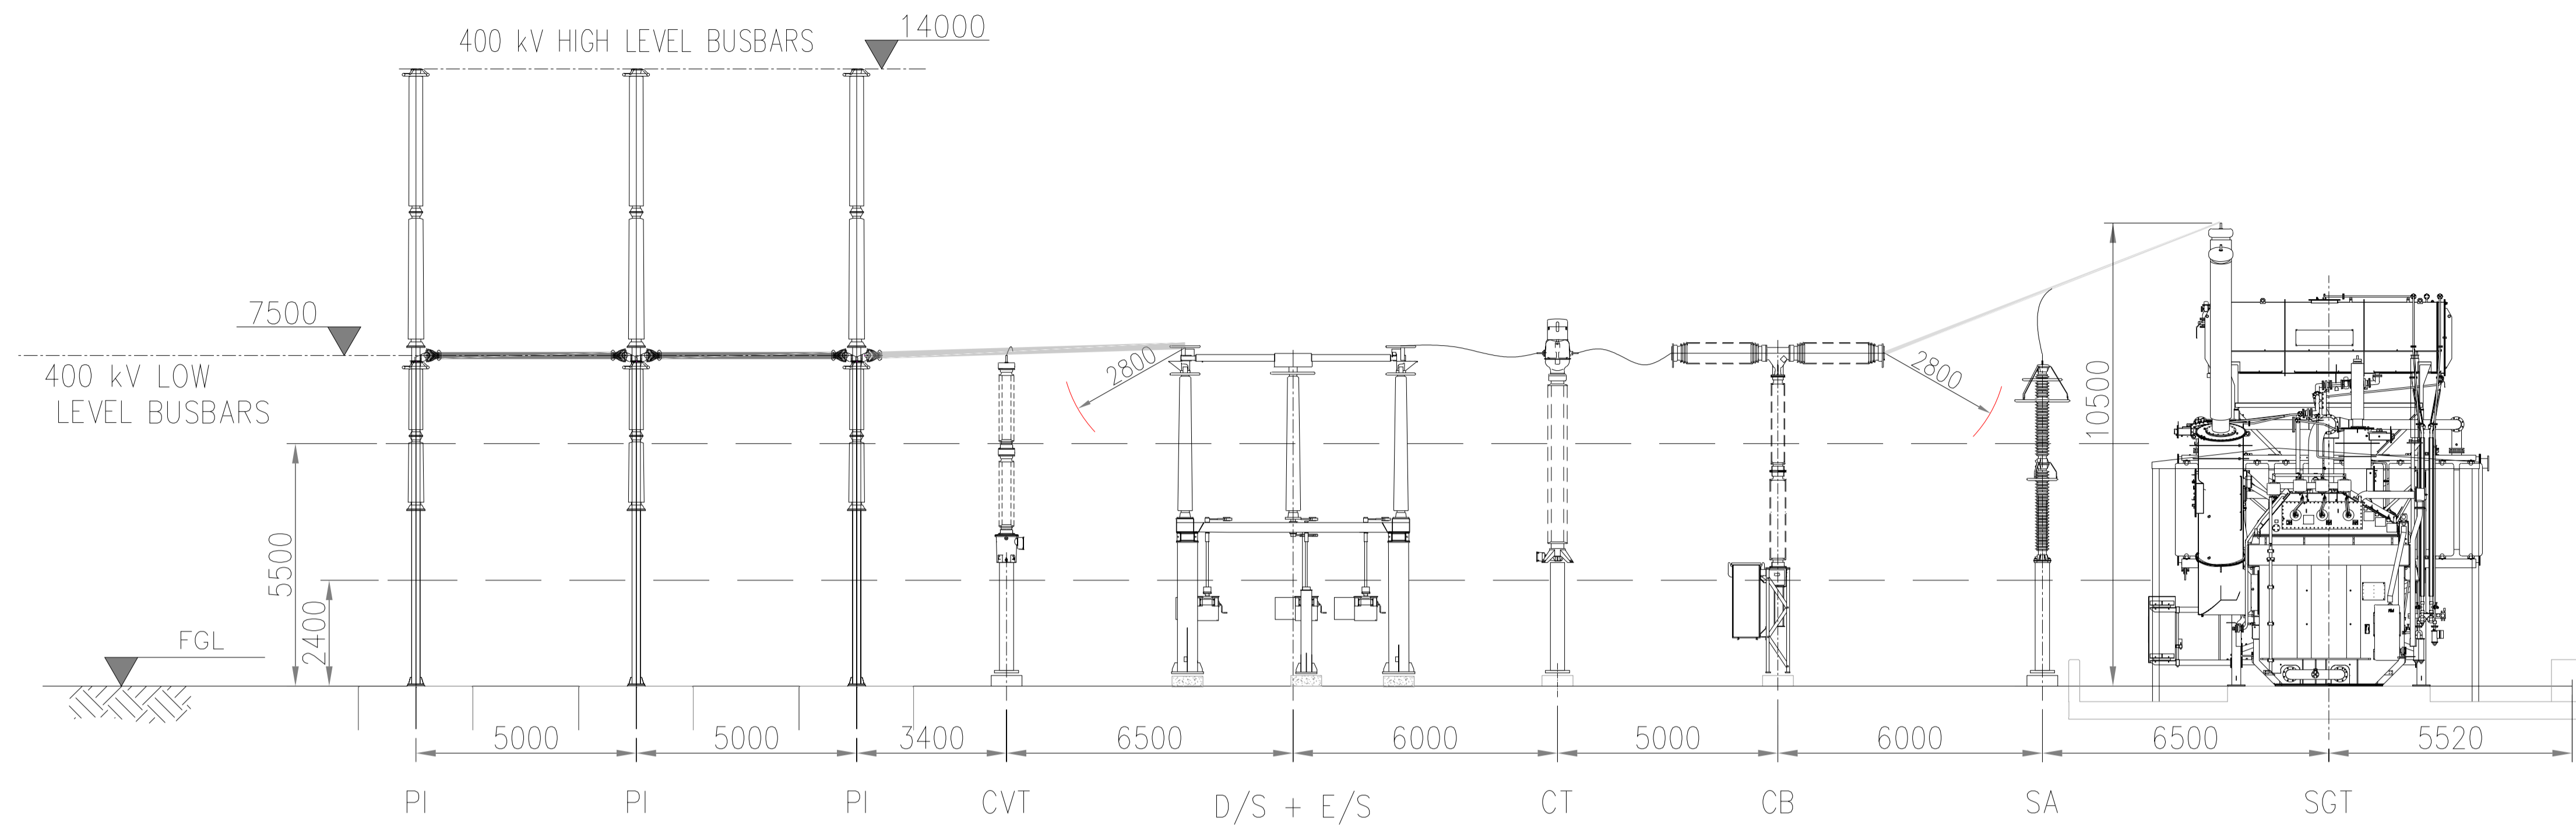


- ABBREVIATIONS:**
- CB CIRCUIT BREAKER
 - CSE CABLE SEALING END
 - CVT CAPACITIVE VOLTAGE TRANSFORMER
 - D/S DISCONNECTOR
 - E/S EARTH SWITCH
 - PI POST INSULATOR
 - SA SURGE ARRESTER
 - SGT SUPERGRID TRANSFORMER

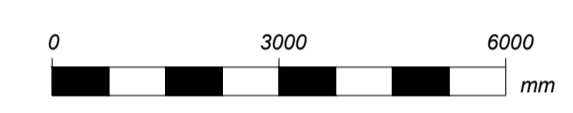

400kV COMPOUND ELEVATION VIEW

- ABBREVIATIONS:**
- | | | | |
|--------|-----------------------|-----|------------------|
| AUX TX | AUXILIARY TRANSFORMER | HL | HIGH LEVEL |
| CB | CIRCUIT BREAKER | LL | LOW LEVEL |
| CSE | CABLE SEALING END | PI | POST INSULATOR |
| D/S | DISCONNECTOR | SA | SURGE ARRESTER |
| E/S | EARTH SWITCH | GTX | GRID TRANSFORMER |

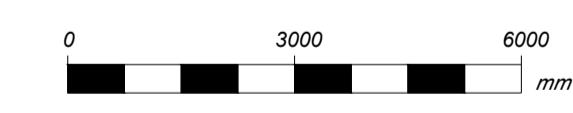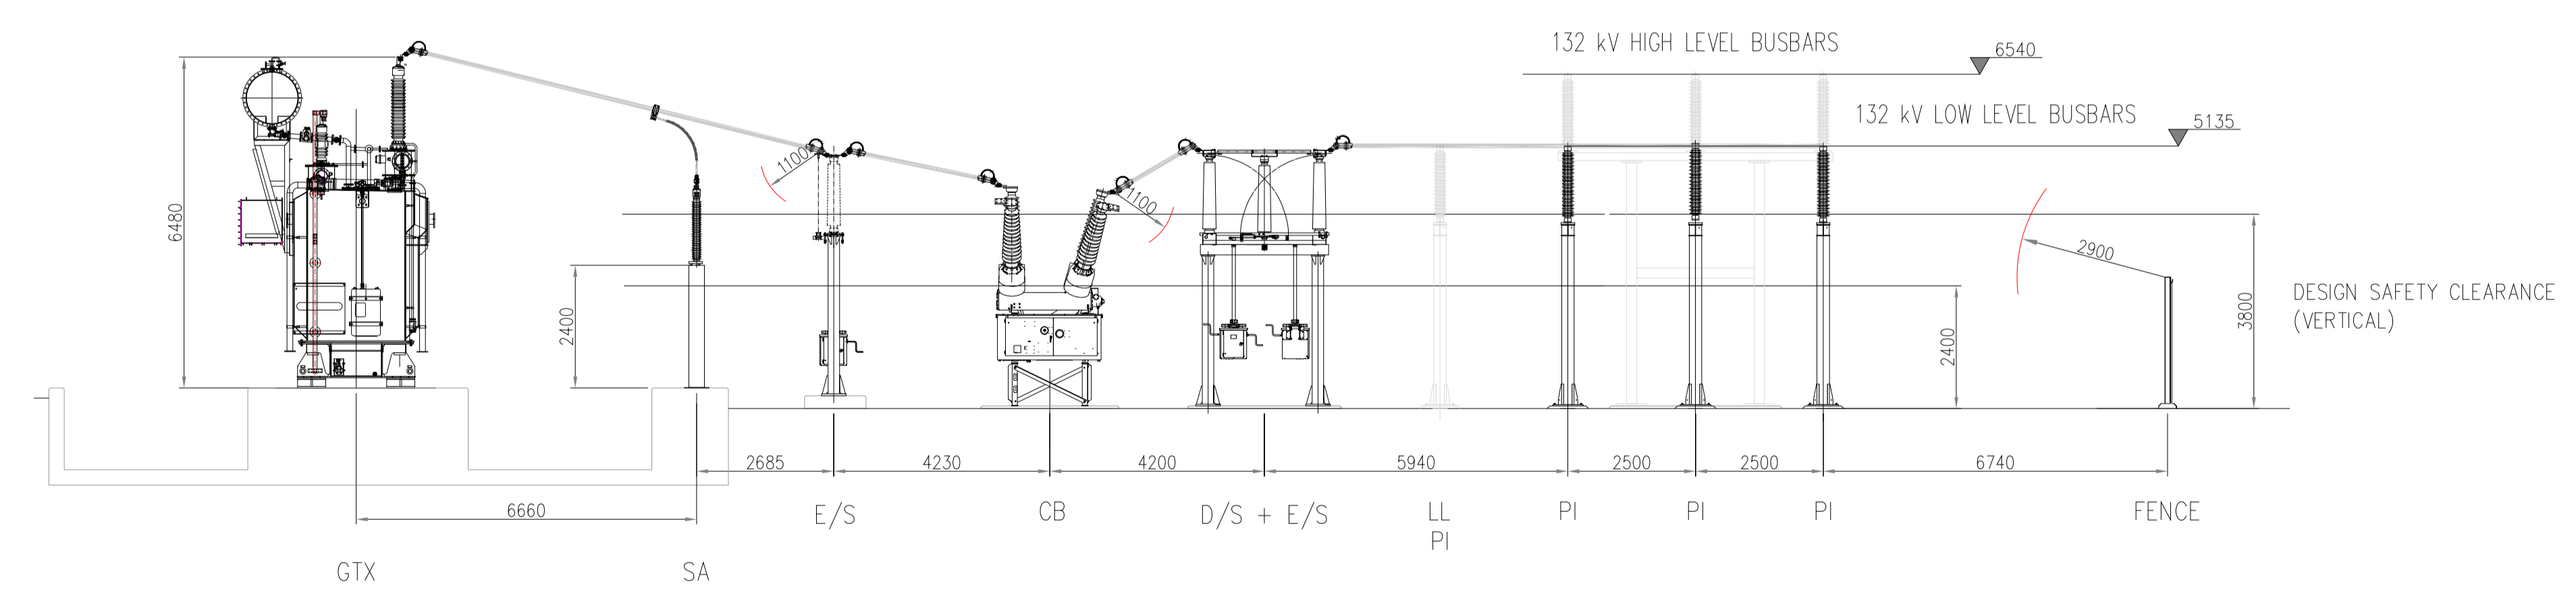

132kV COMPOUND ELEVATION VIEW
SCALE 1:150

R01 First Issue		2025-06-13	AL
Rev.	Description	Date	Responsible

This document and its contents are confidential and it is intended solely for the use of the recipient(s) to whom it is addressed. All content, including drawings, designs, and other materials, are the intellectual property of Elements Green Trent Ltd. Any unauthorised use or distribution of this document without the prior written consent of Elements Green Trent Ltd (company number 13065201) is strictly prohibited. Registered Office: 1 Half Moon Street, London, England, W1J 7AY


Solar & Biodiversity Park

Drawing Title: **Figure 5.12 Illustrative Substation Layout 400kV and 132kV Elevations**

Drawing No: **UK003-PV-ENG-0-460-R00-5.12**

Designed by: **AL** Approved by: **OC** Date: **2025-06-13** Scale: **1:150** Dimensions in: **mm** Paper Size: **A1 (841x594)** Sheet: **1/1**

PV SITE COMPOUND AREA LAYOUT

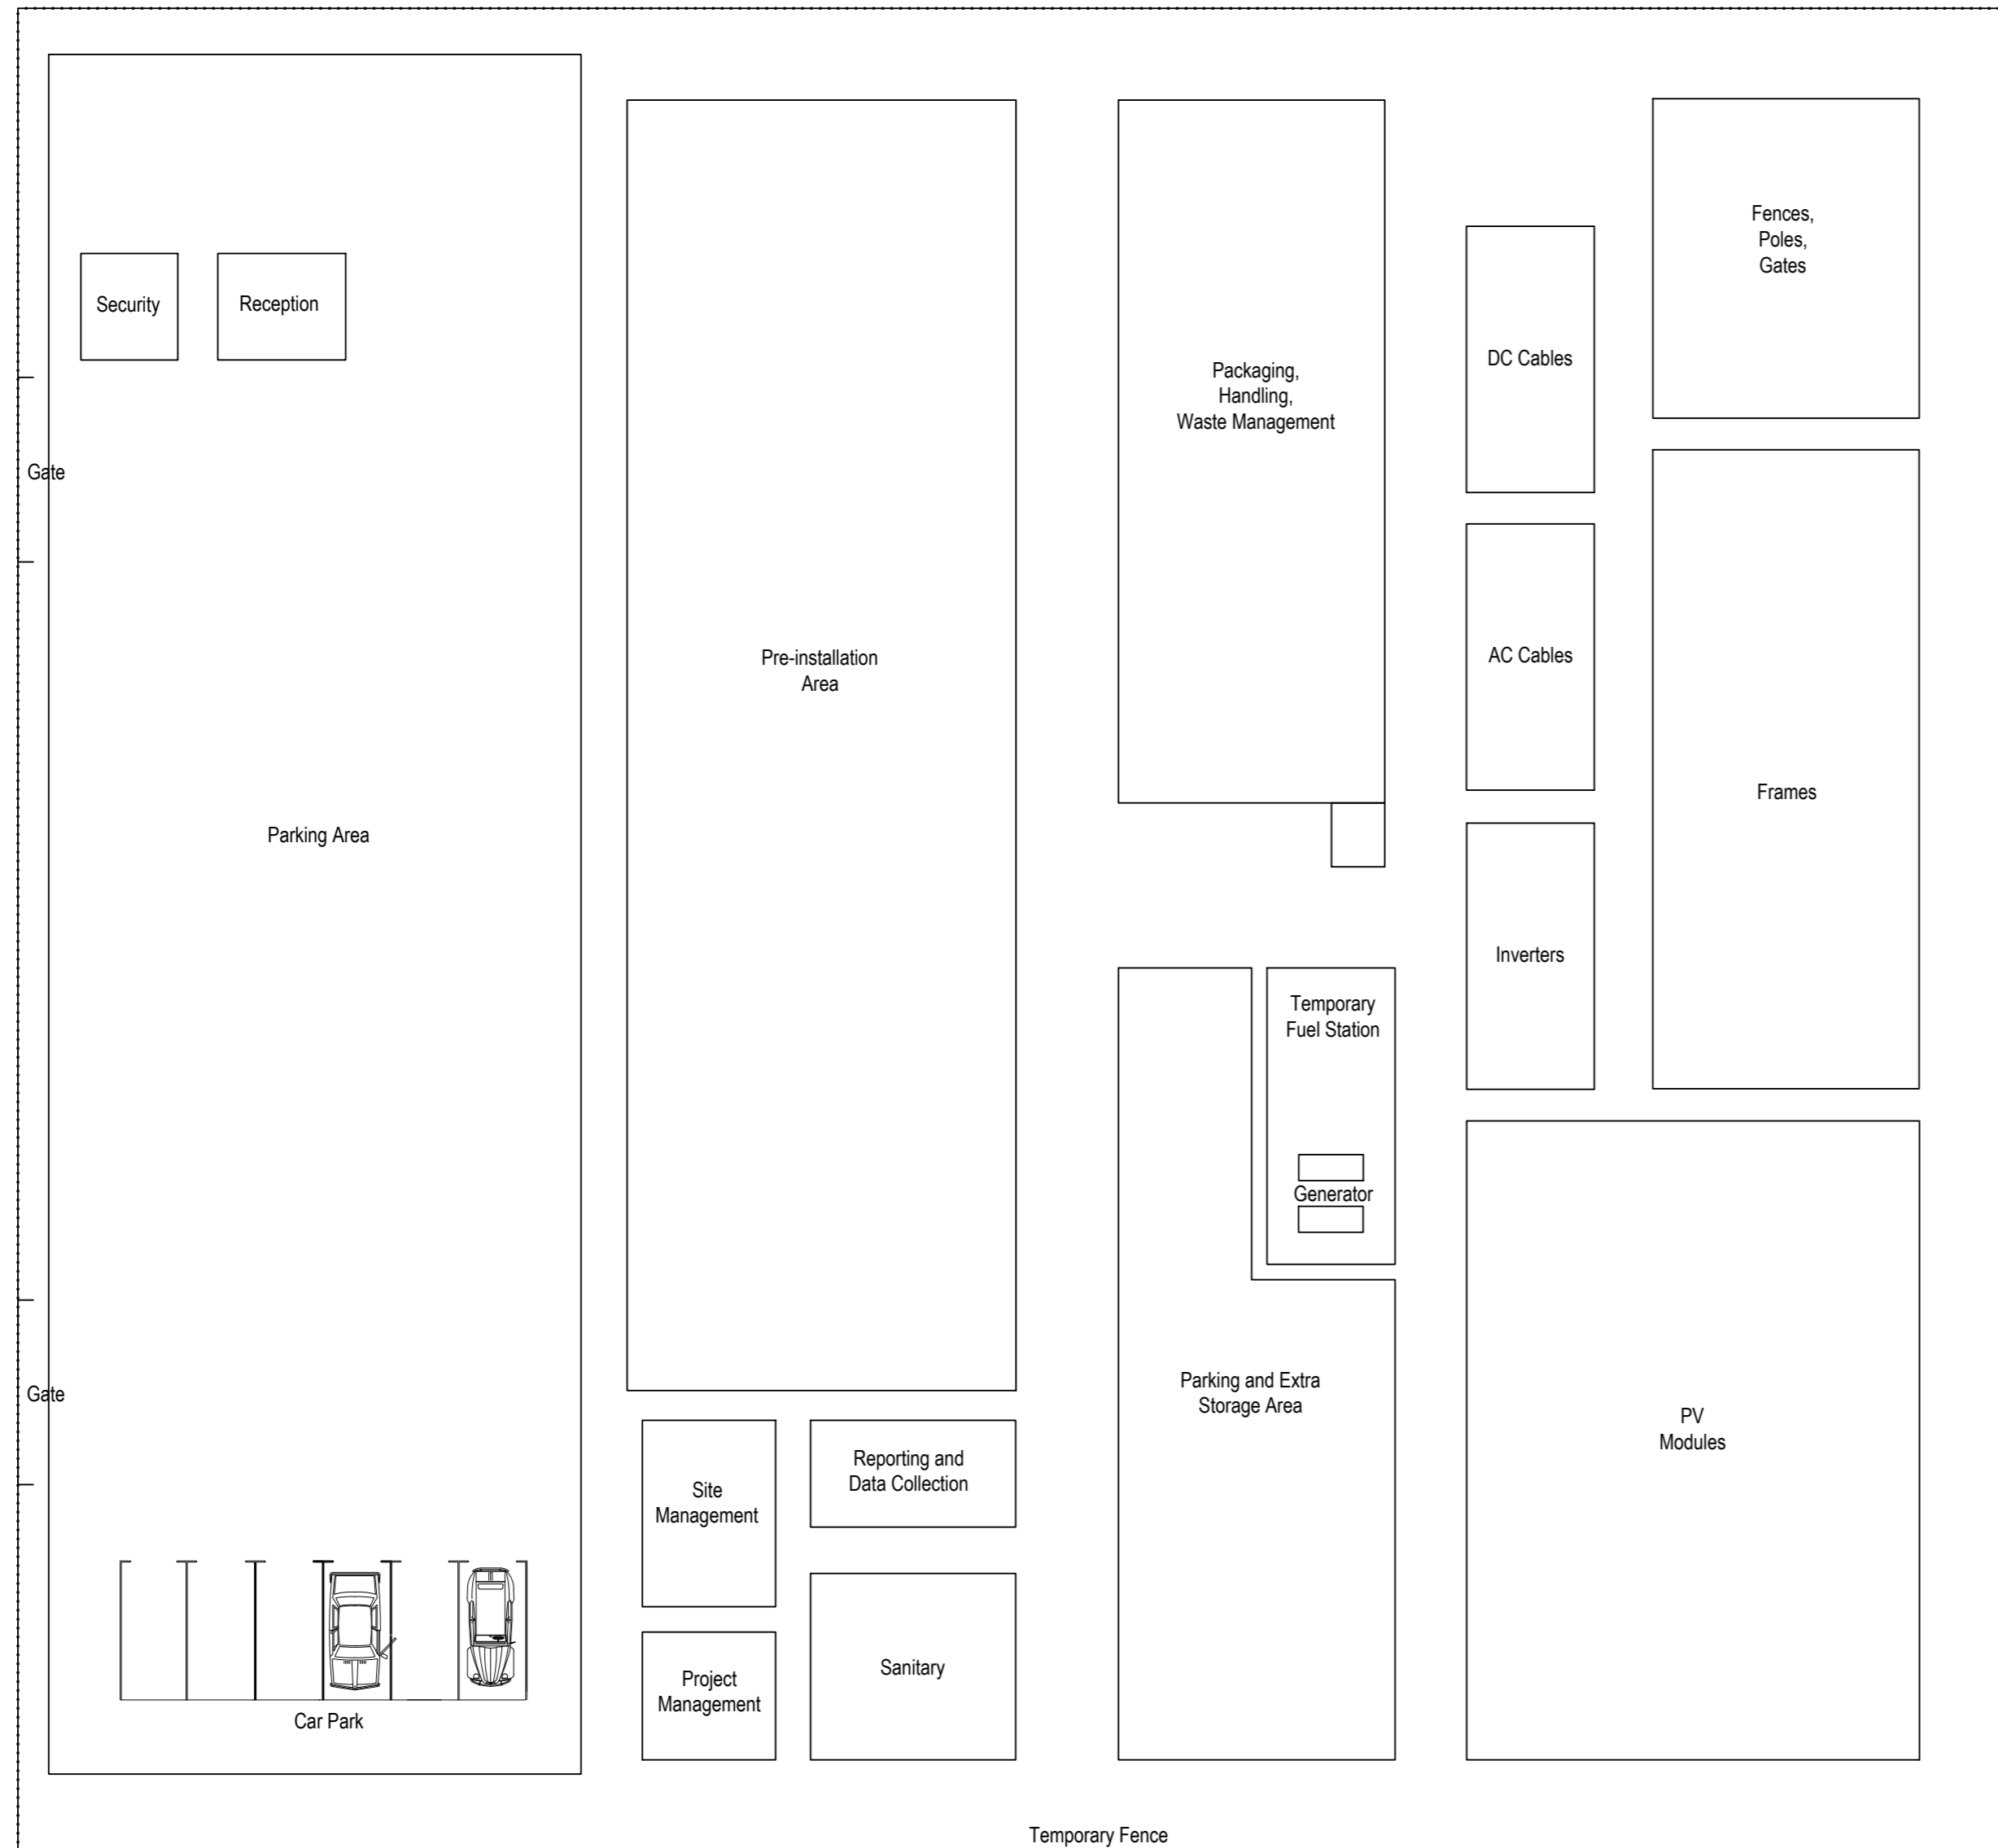

Rev.	Description	Date	Responsible
R01	First Issue	2025-06-13	BA

This document and its contents are confidential and it is intended solely for the use of the recipient(s) to whom it is addressed. All content, including drawings, designs, and other materials, are the intellectual property of Elements Green Trent Ltd. Any unauthorised use or distribution of this document without the prior written consent of Elements Green Trent Ltd (company number 13665201) is strictly prohibited. Registered Office: 1 Half Moon Street, London, England, W1J 7AY

Solar & Biodiversity Park

Drawing Title
**Figure 5.13
Illustrative Construction Compound Layout**


Illustrative Purposes Only

Drawing No. **UK003-PV-ENG-0-460-R00-5.13.1**





Designed by	Approved by	Date	Scale	Dimensions in	Paper Size	Sheet
BA	OC	2025-06-13	1:200	m	A2 (594x420)	1/2

HDD COMPOUND LAYOUT - RIG SIDE

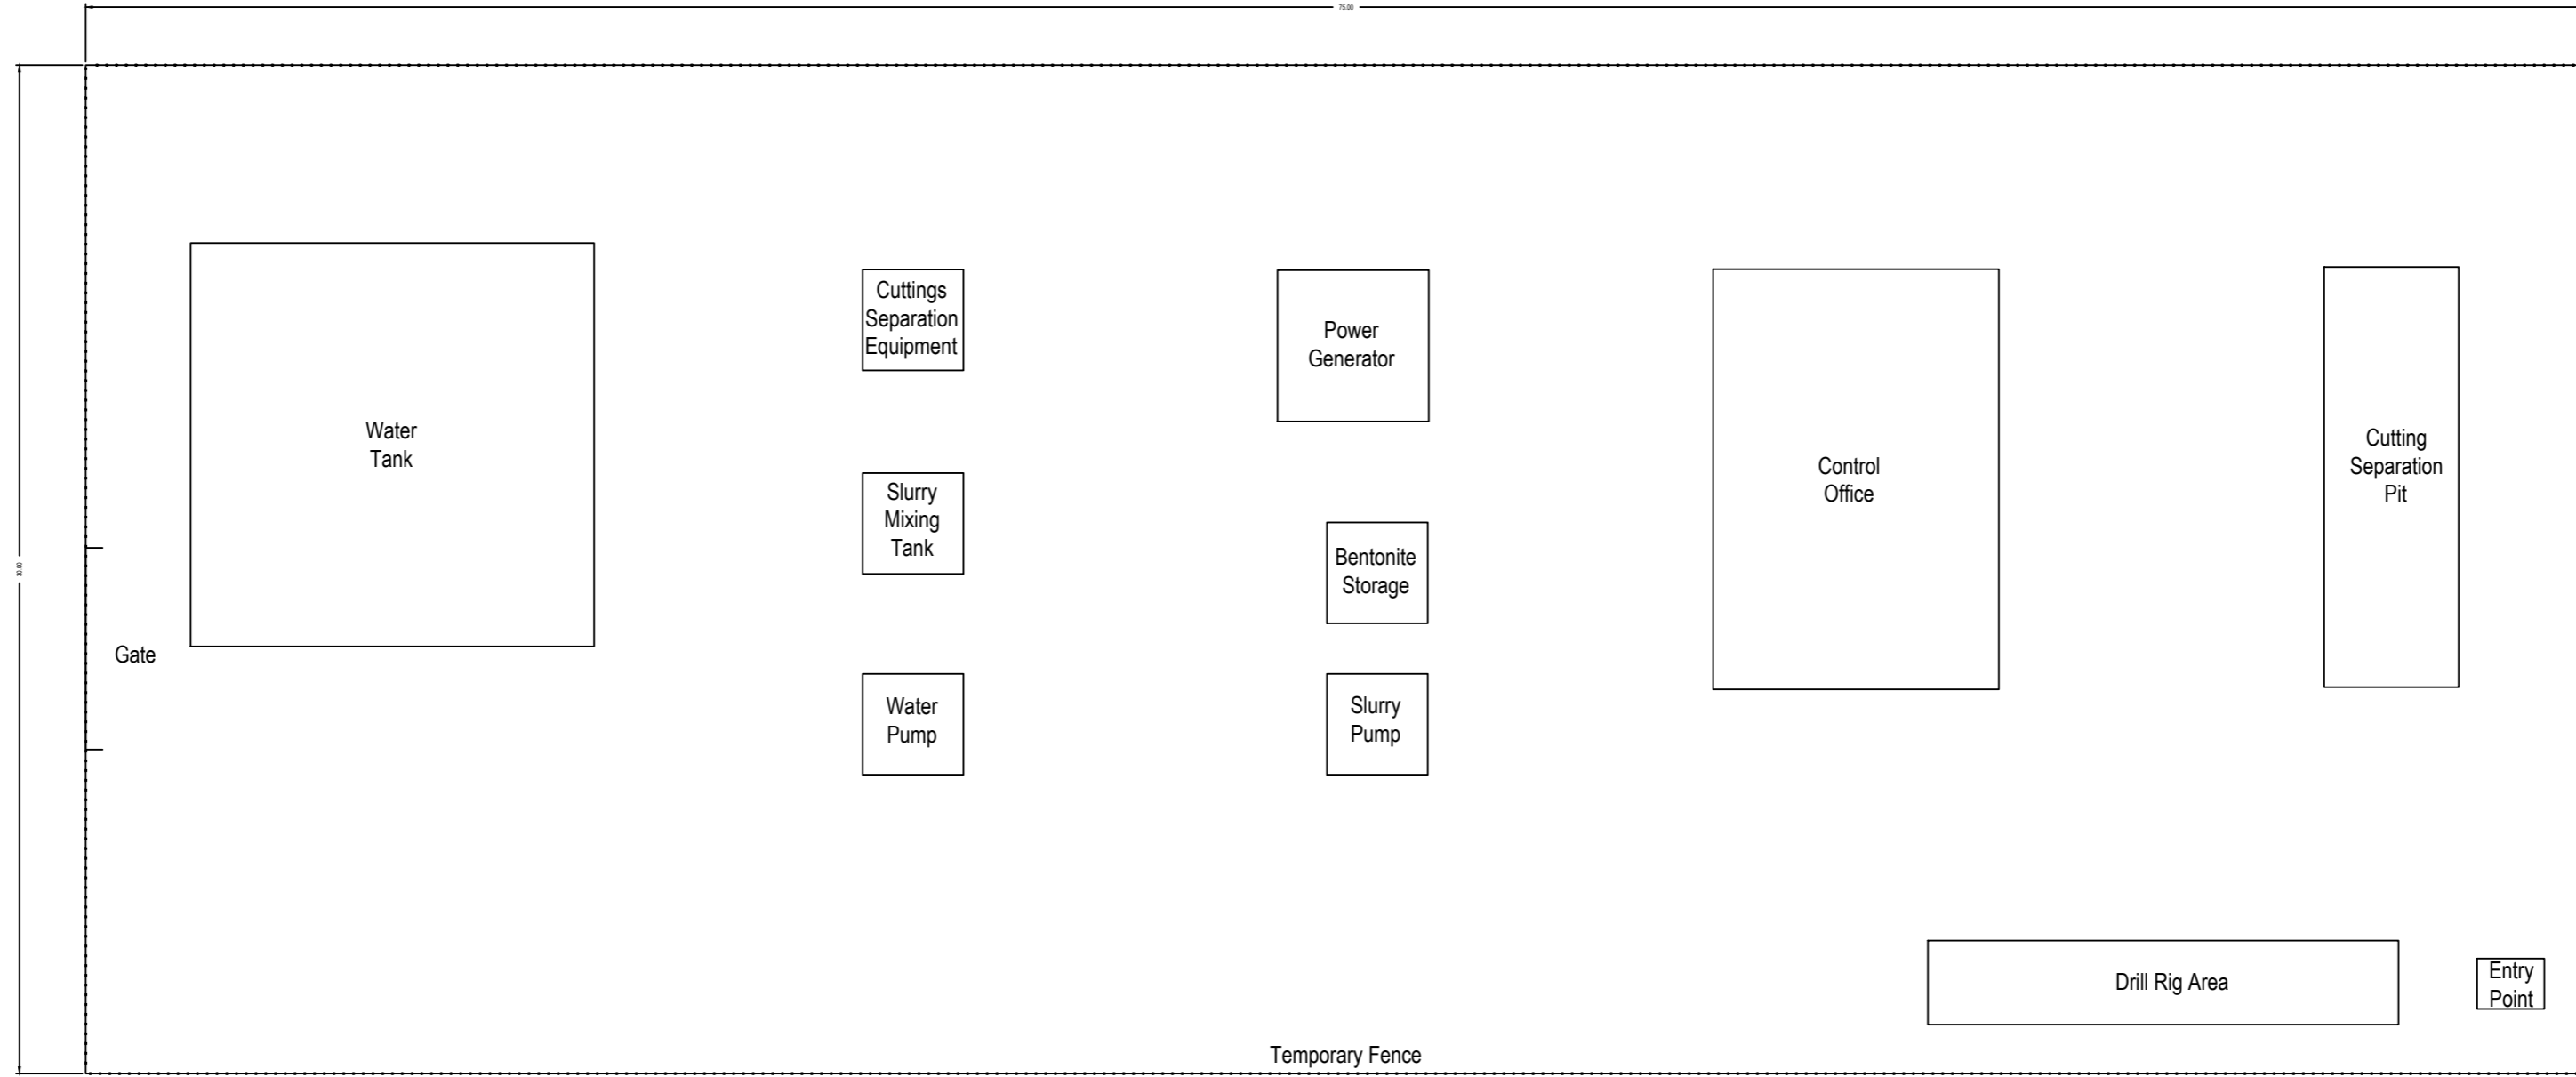


HDD COMPOUND LAYOUT - PULL BACK SIDE

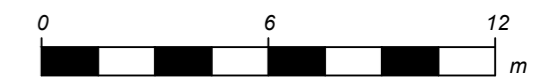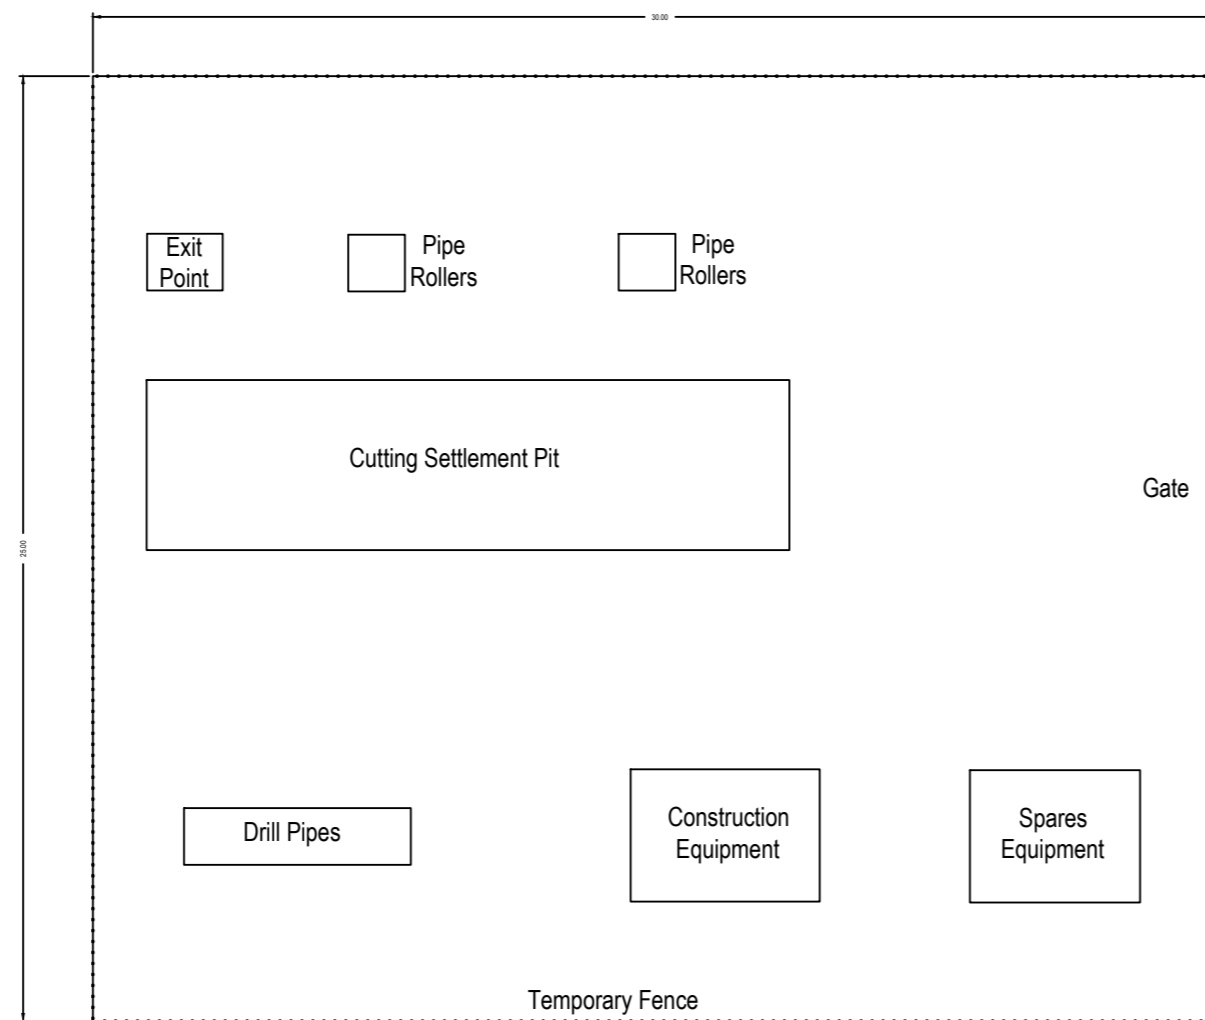

Rev.	Description	Date	Responsible
R01	First Issue	2025-06-13	BA


This document and its contents are confidential and it is intended solely for the use of the recipient(s) to whom it is addressed.
 All content, including drawings, designs, and other materials, are the intellectual property of Elements Green Trent Ltd.
 Any unauthorised use or distribution of this document without the prior written consent of Elements Green Trent Ltd (company number 13665201) is strictly prohibited.
 Registered Office: 1 Half Moon Street, London, England, W1J 7AY

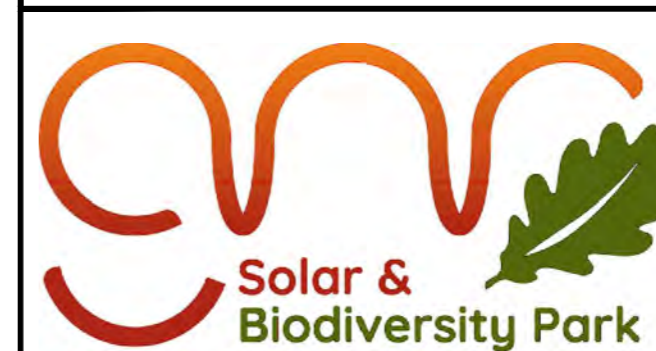

Drawing Title
Figure 5.13
Illustrative Construction Compound Layout

Illustrative Purposes Only


Drawing No. **UK003-PV-ENG-0-460-R00-5.13.2**

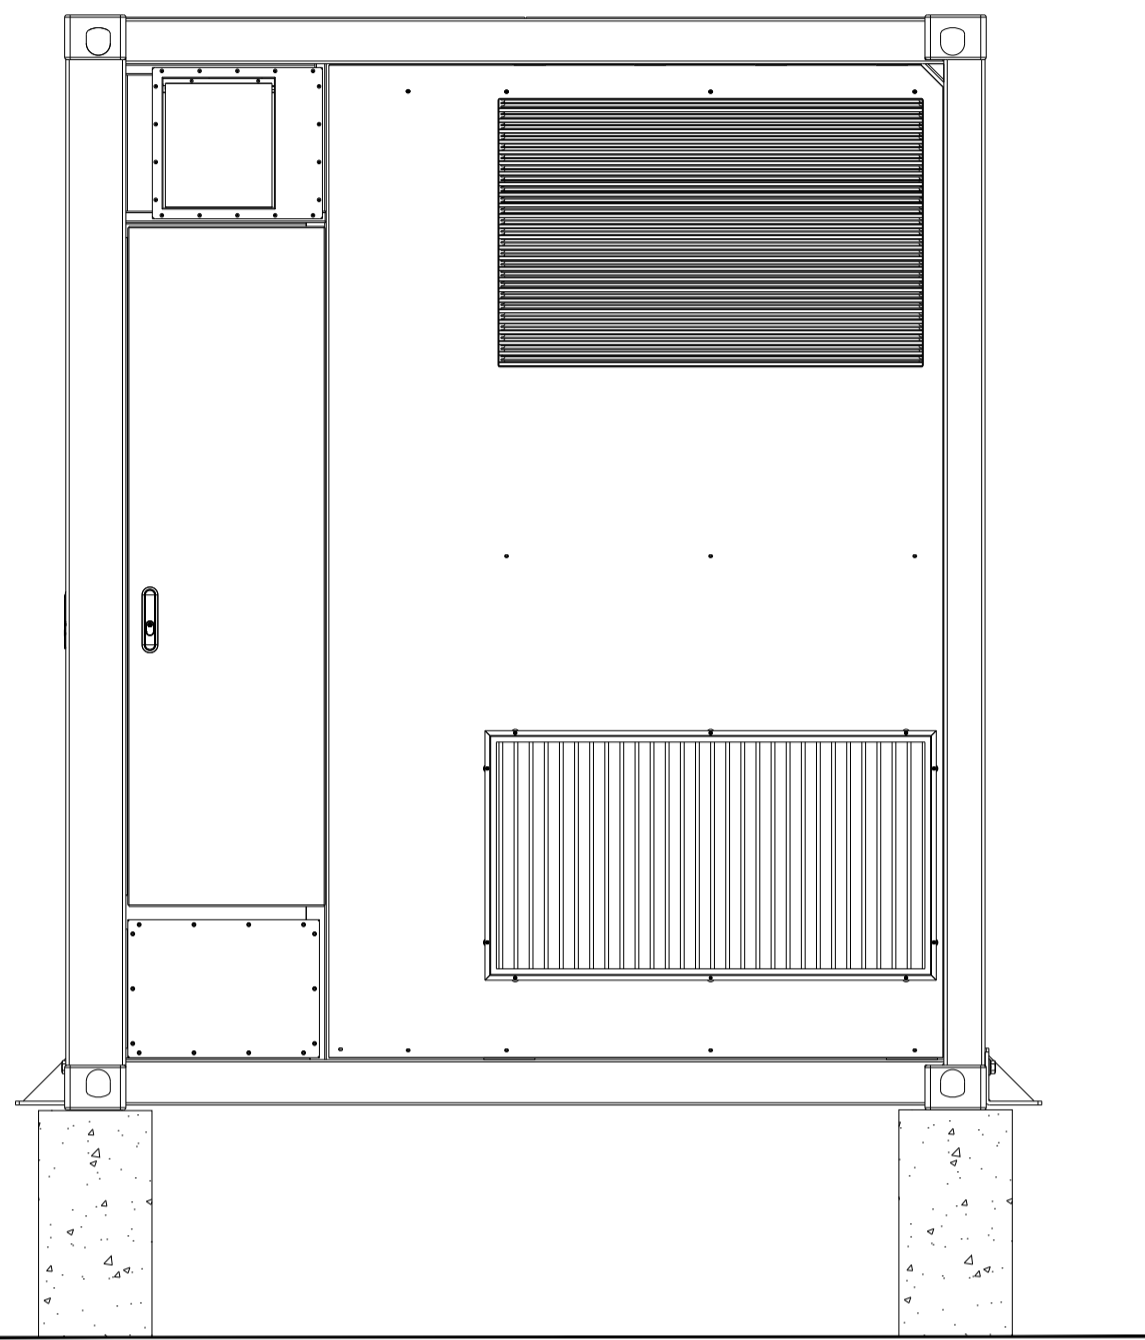

Right view




Front view

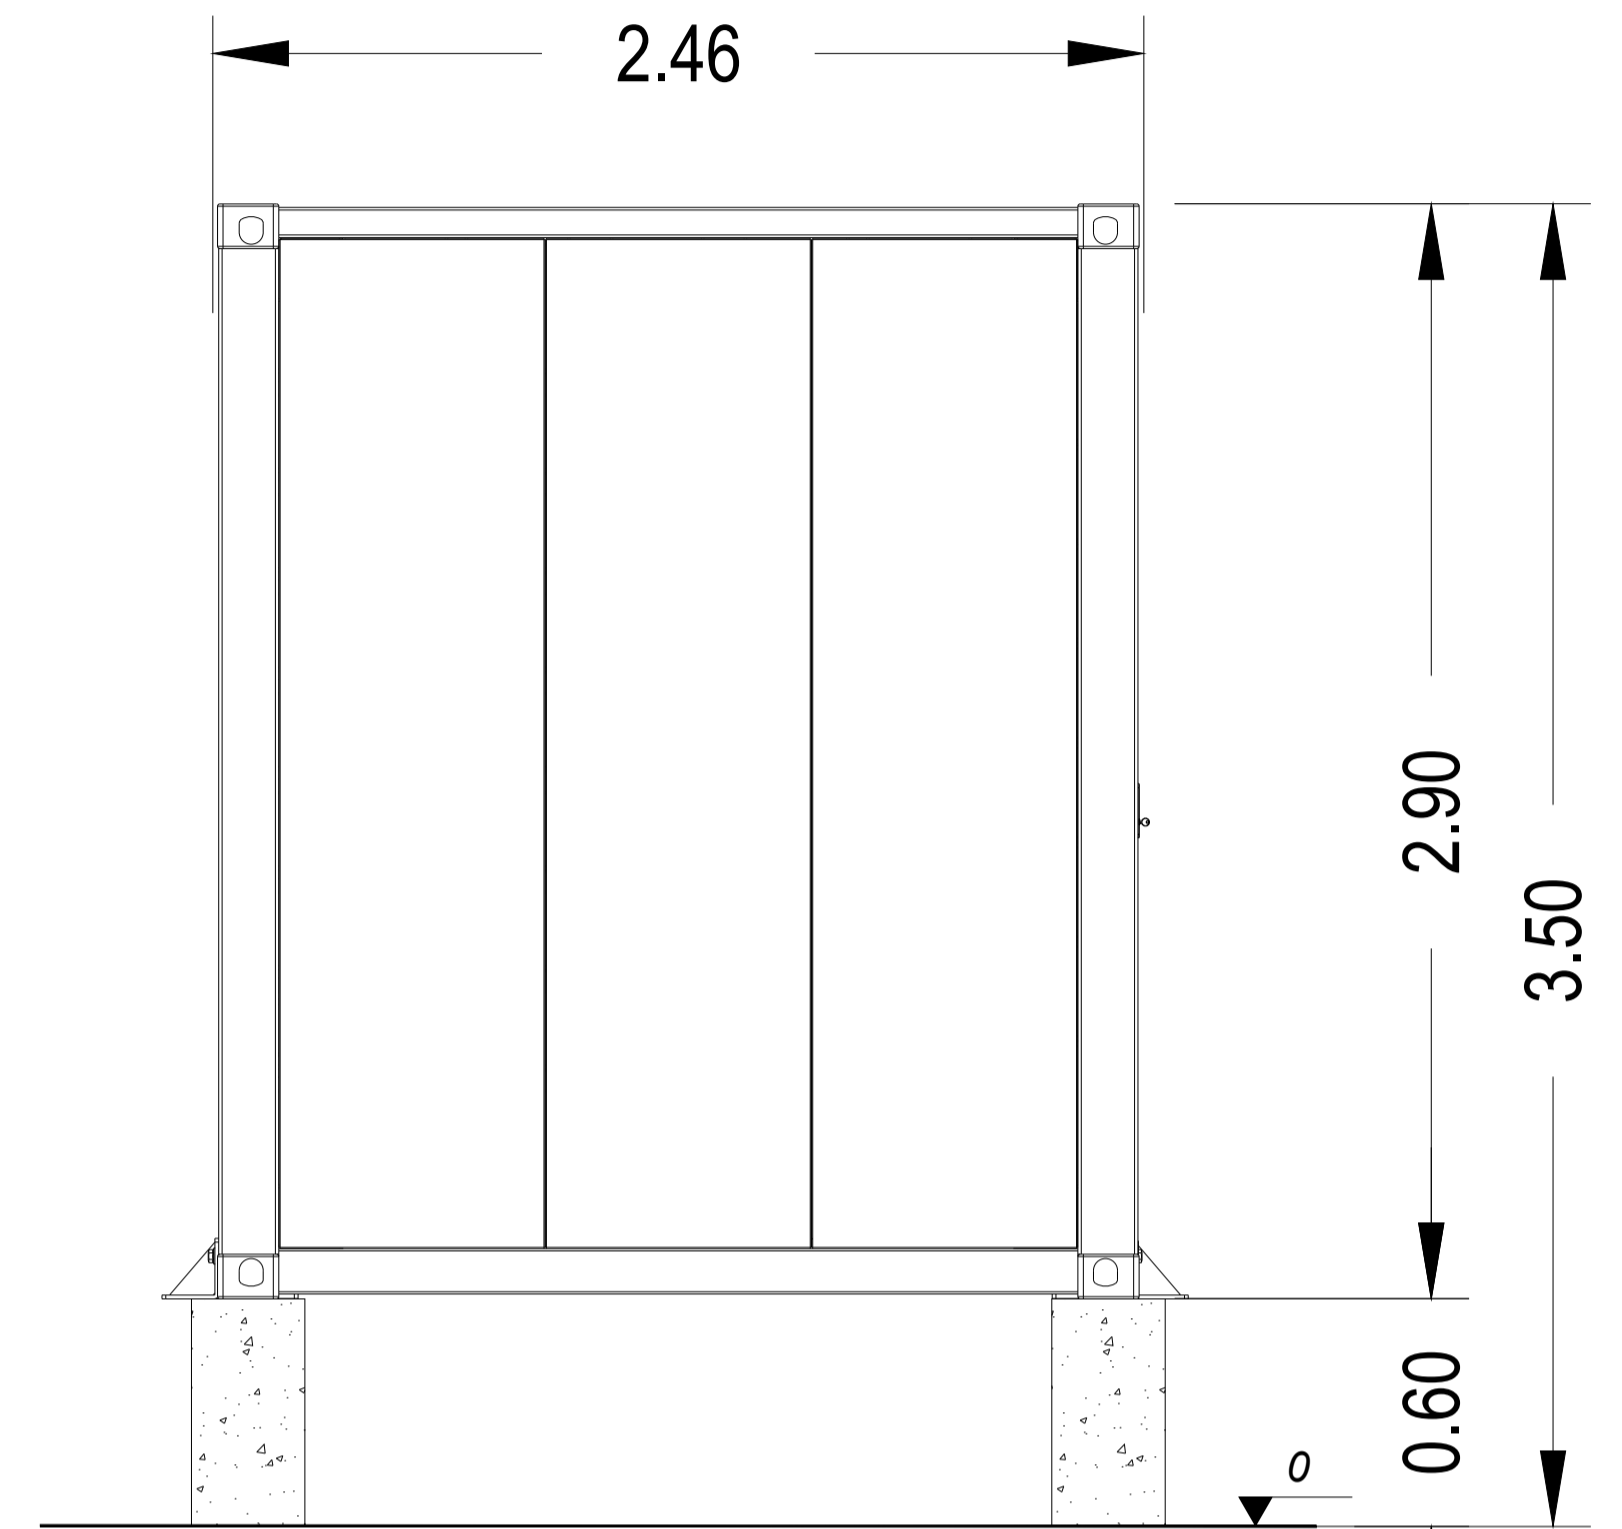


Left view

Reinforced concrete

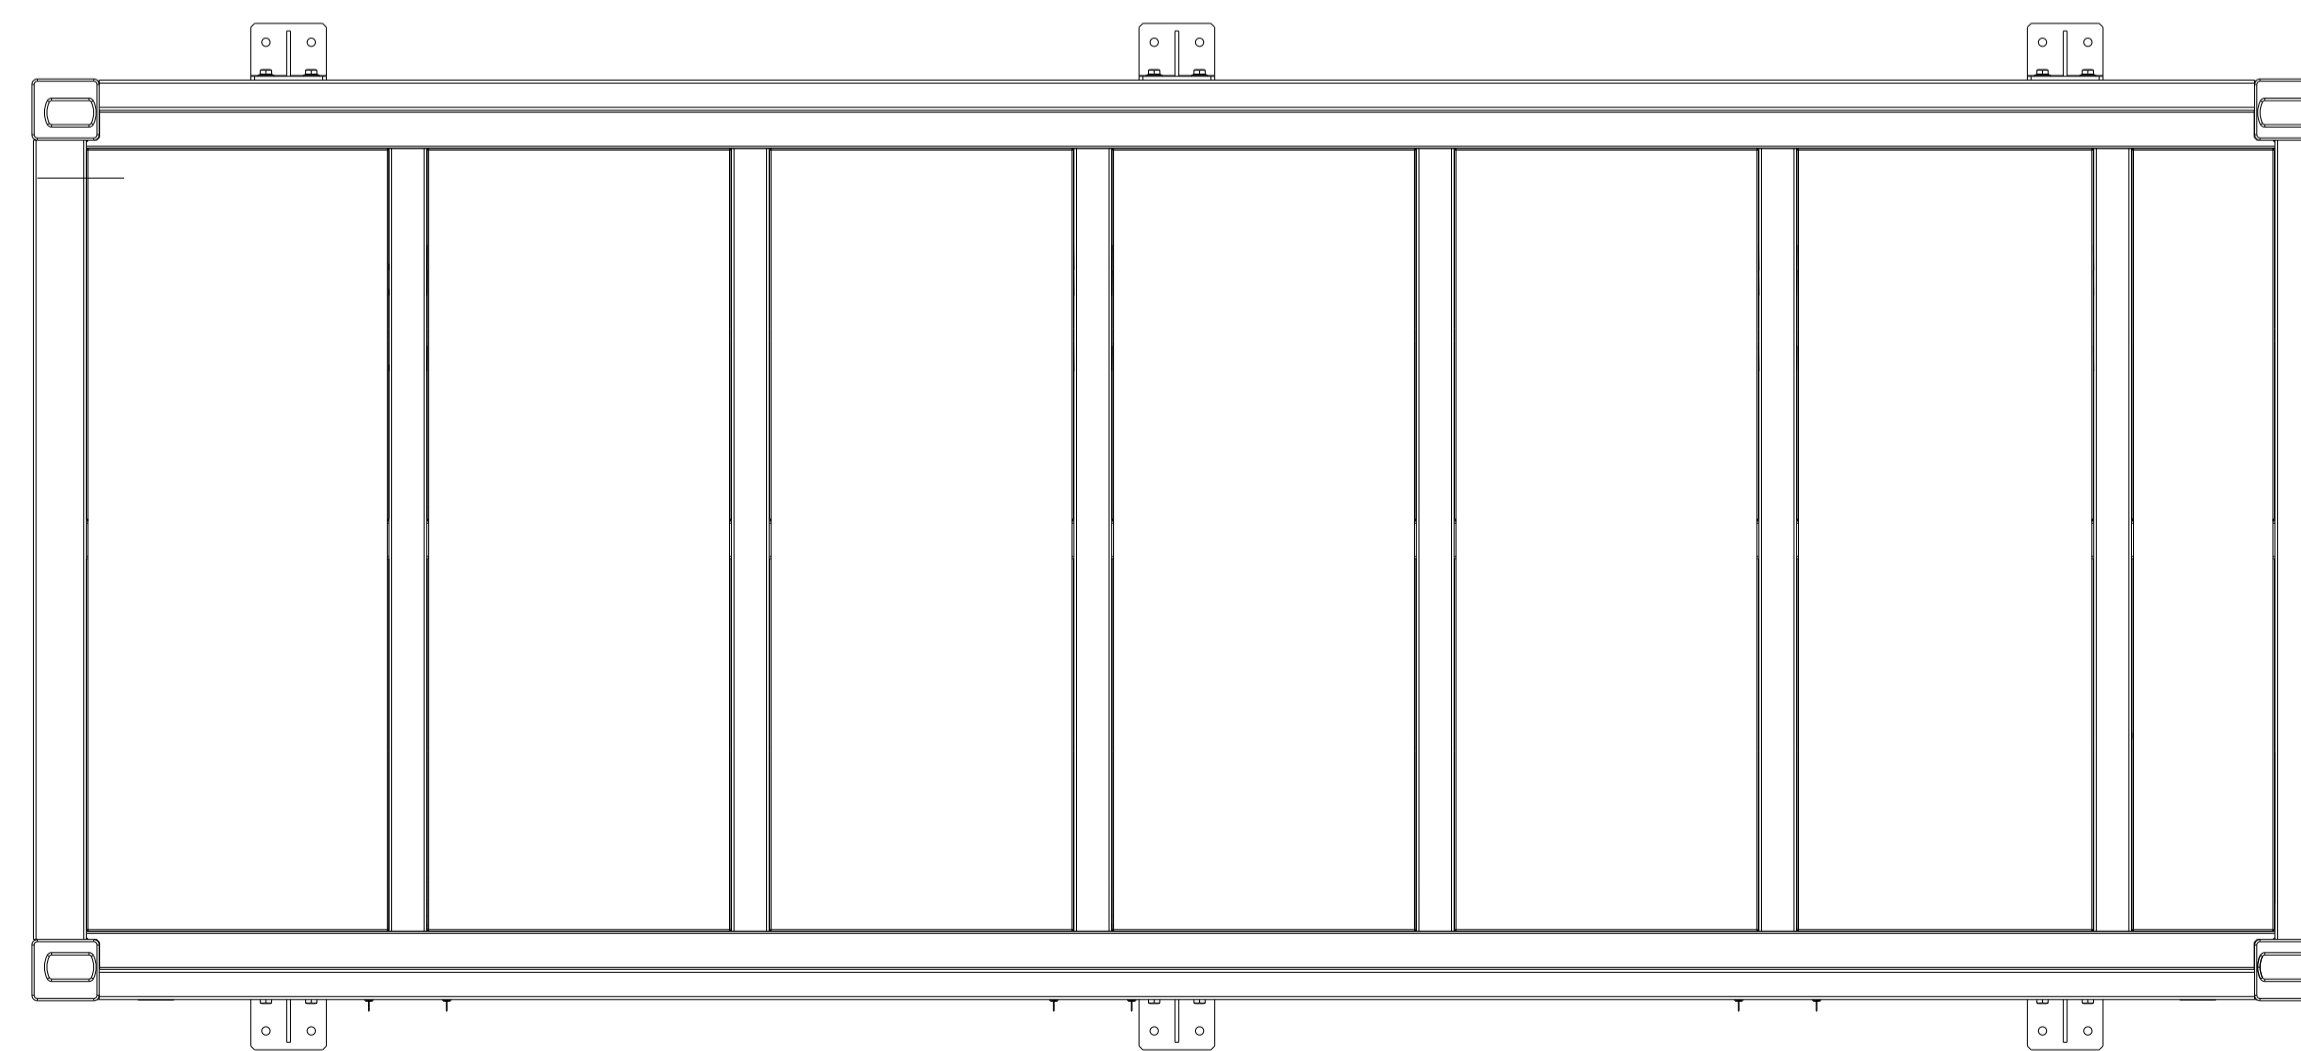

Top view

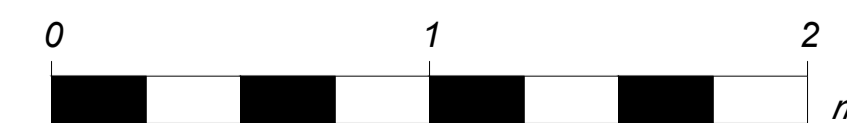

Rev.	Description	Date	Responsible
R01	First issue	2025-06-13	AL


This document and its contents are confidential and it is intended solely for the use of the recipient(s) to whom it is addressed. All content, including drawings, designs, and other materials, are the intellectual property of Elements Green Trent Ltd (company number 13065201). Any unauthorised use or distribution of this document without the prior written consent of Elements Green Trent Ltd (company number 13065201) is strictly prohibited. Registered Office: 1 Half Moon Street, London, England, W1J 7AY




Figure 5.14
Illustrative BESS Elevations

Illustrative Purposes Only

Drawing No: **UK003-PV-ENG-0-460-R00-5.14**

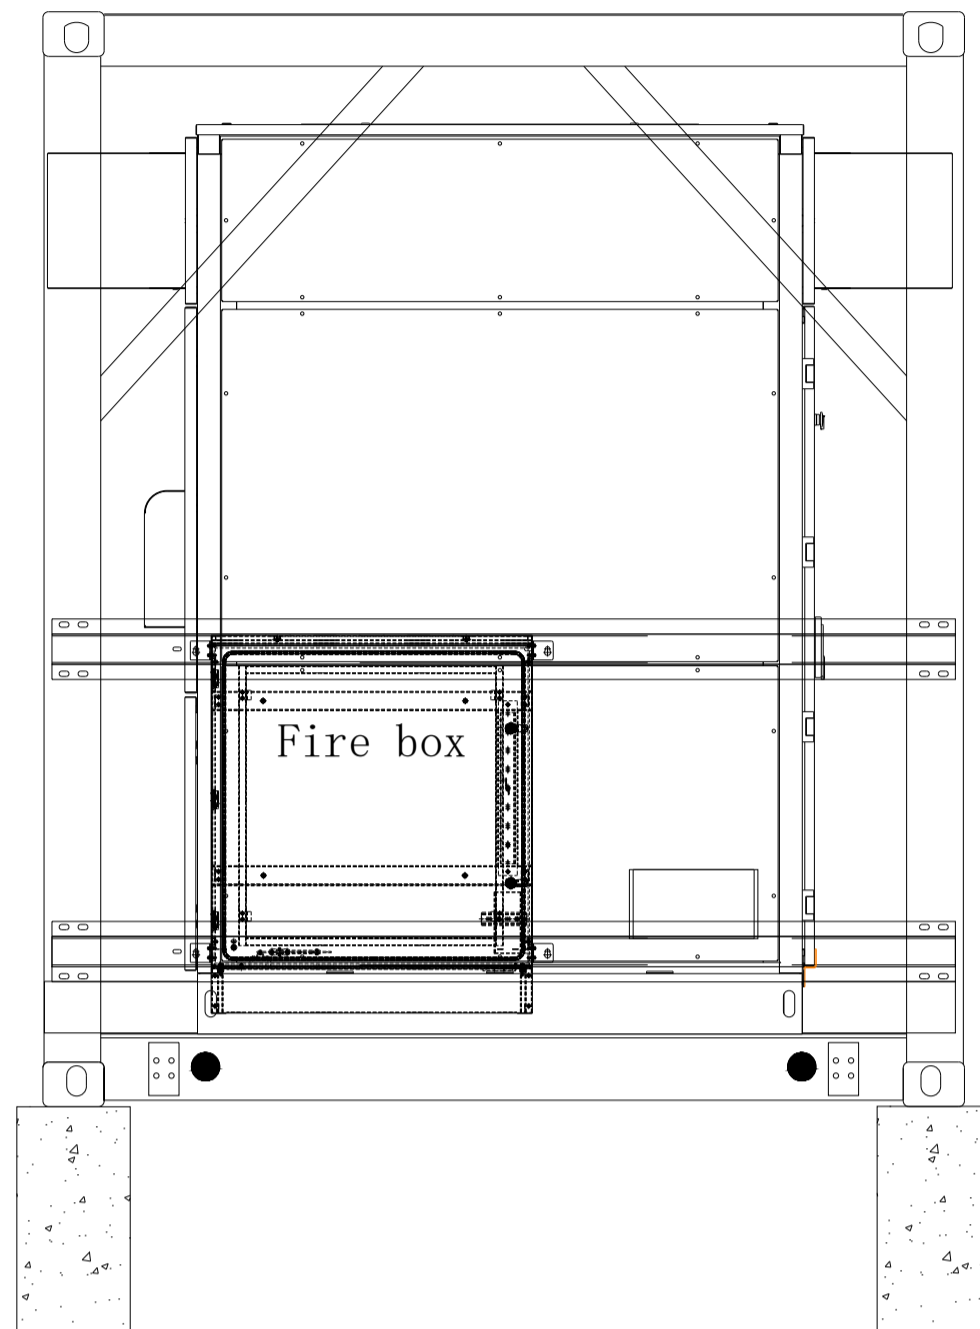


Right view

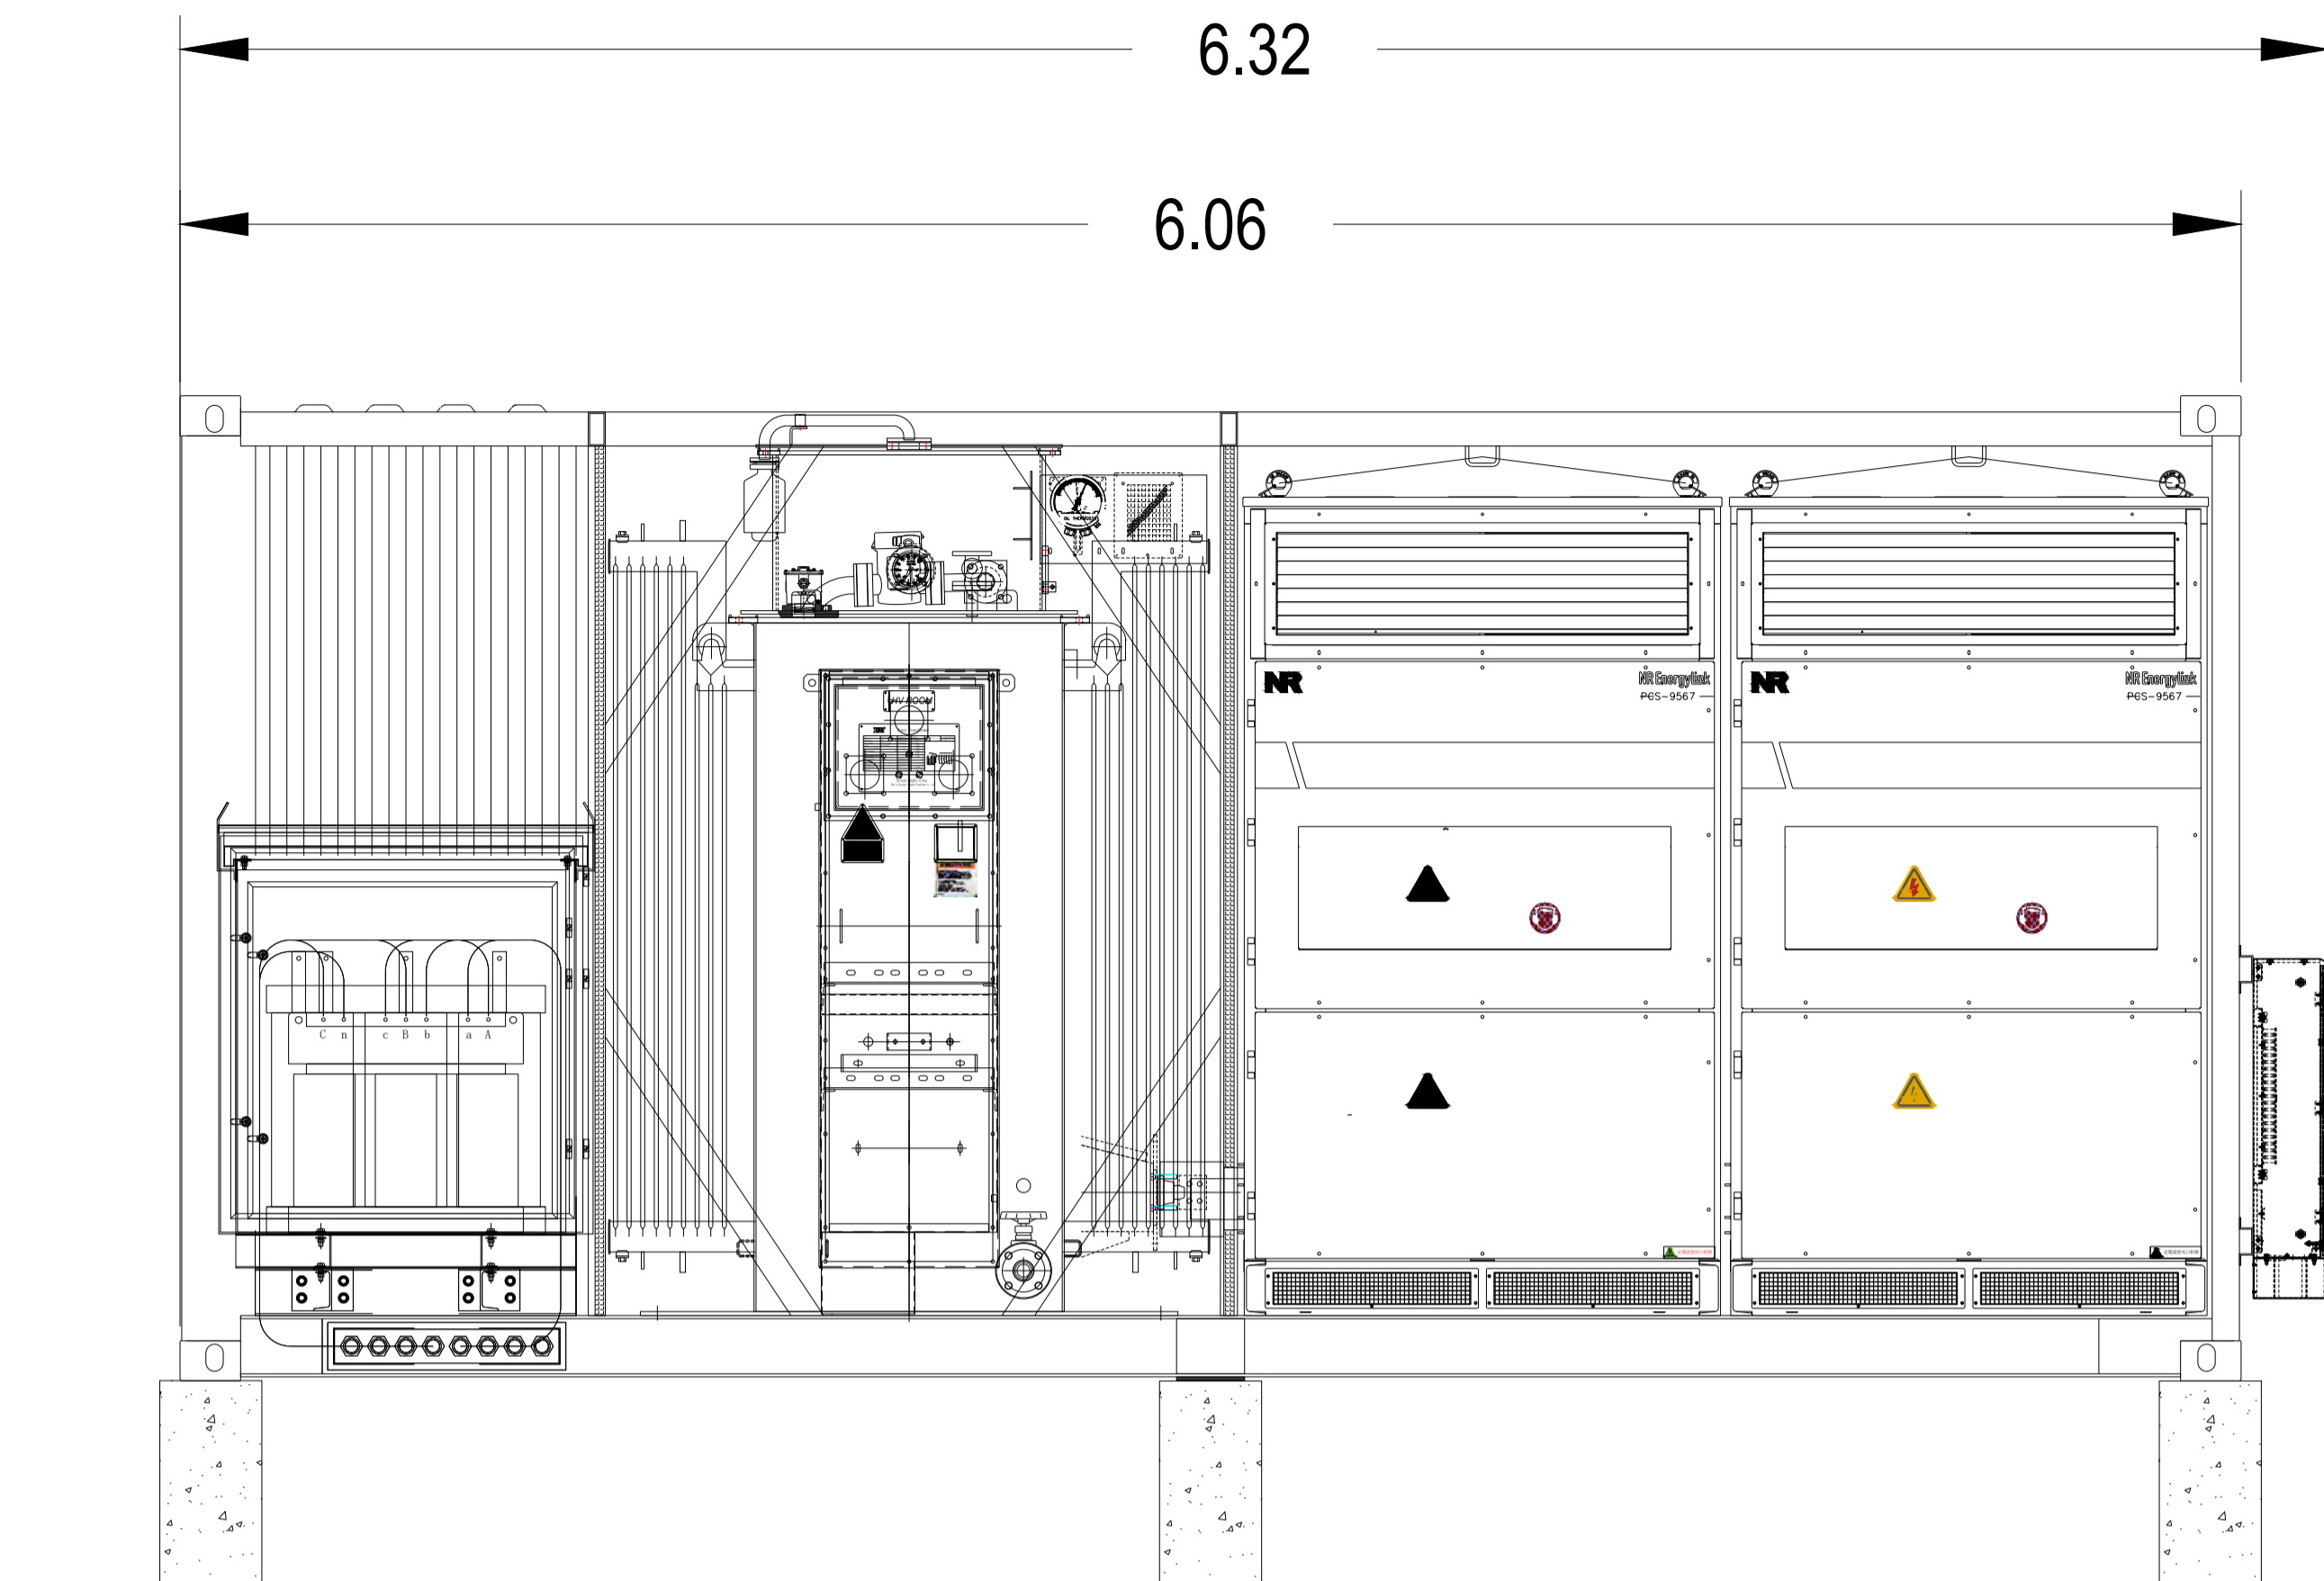


Front view


Reinforced concrete

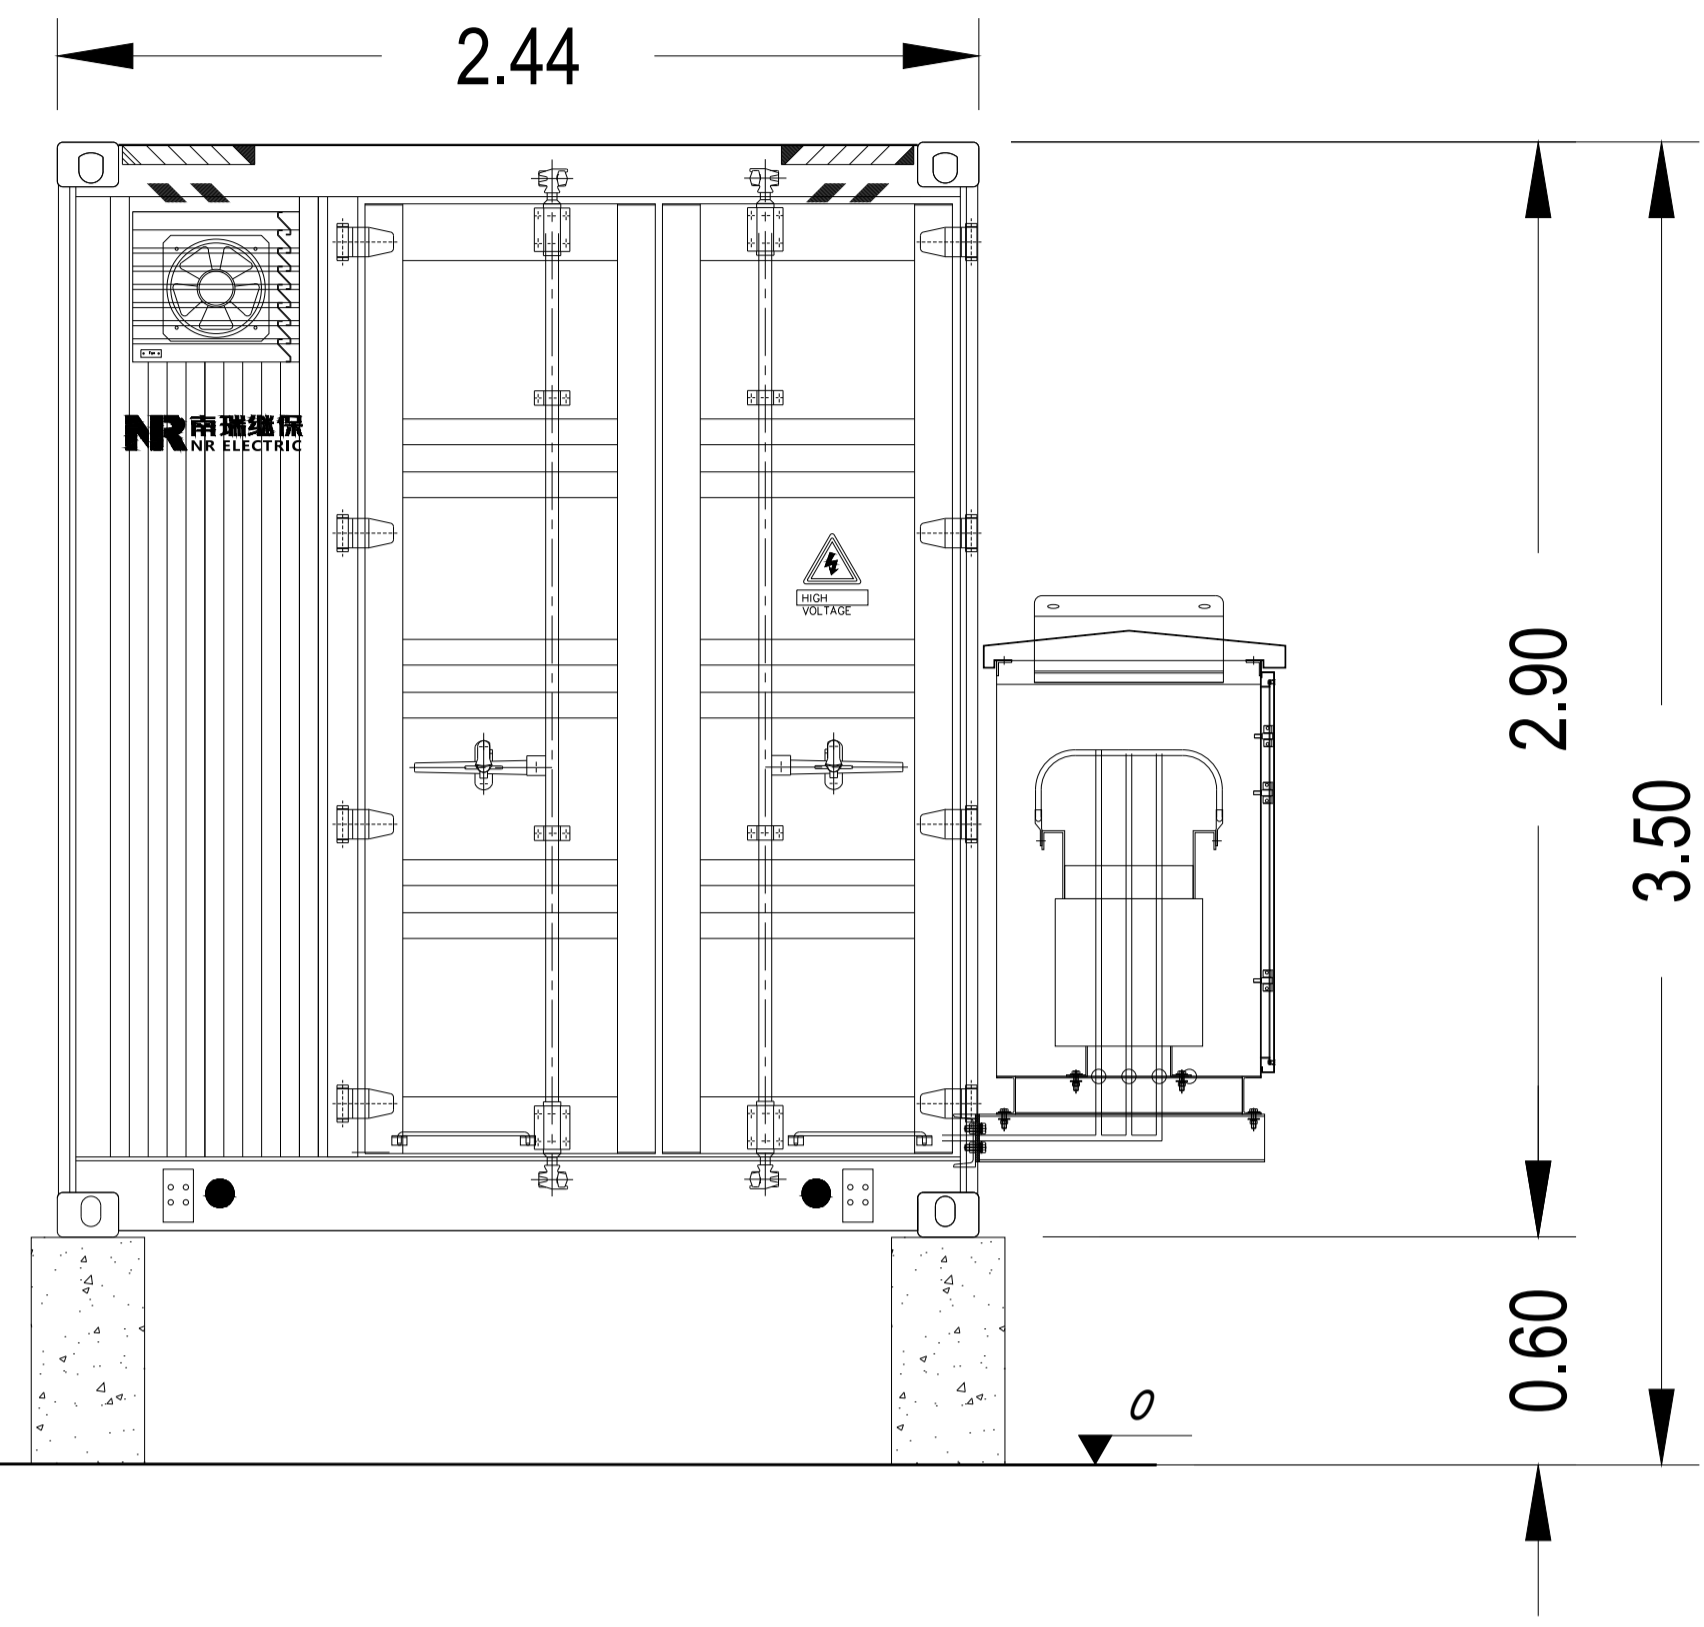

Left view

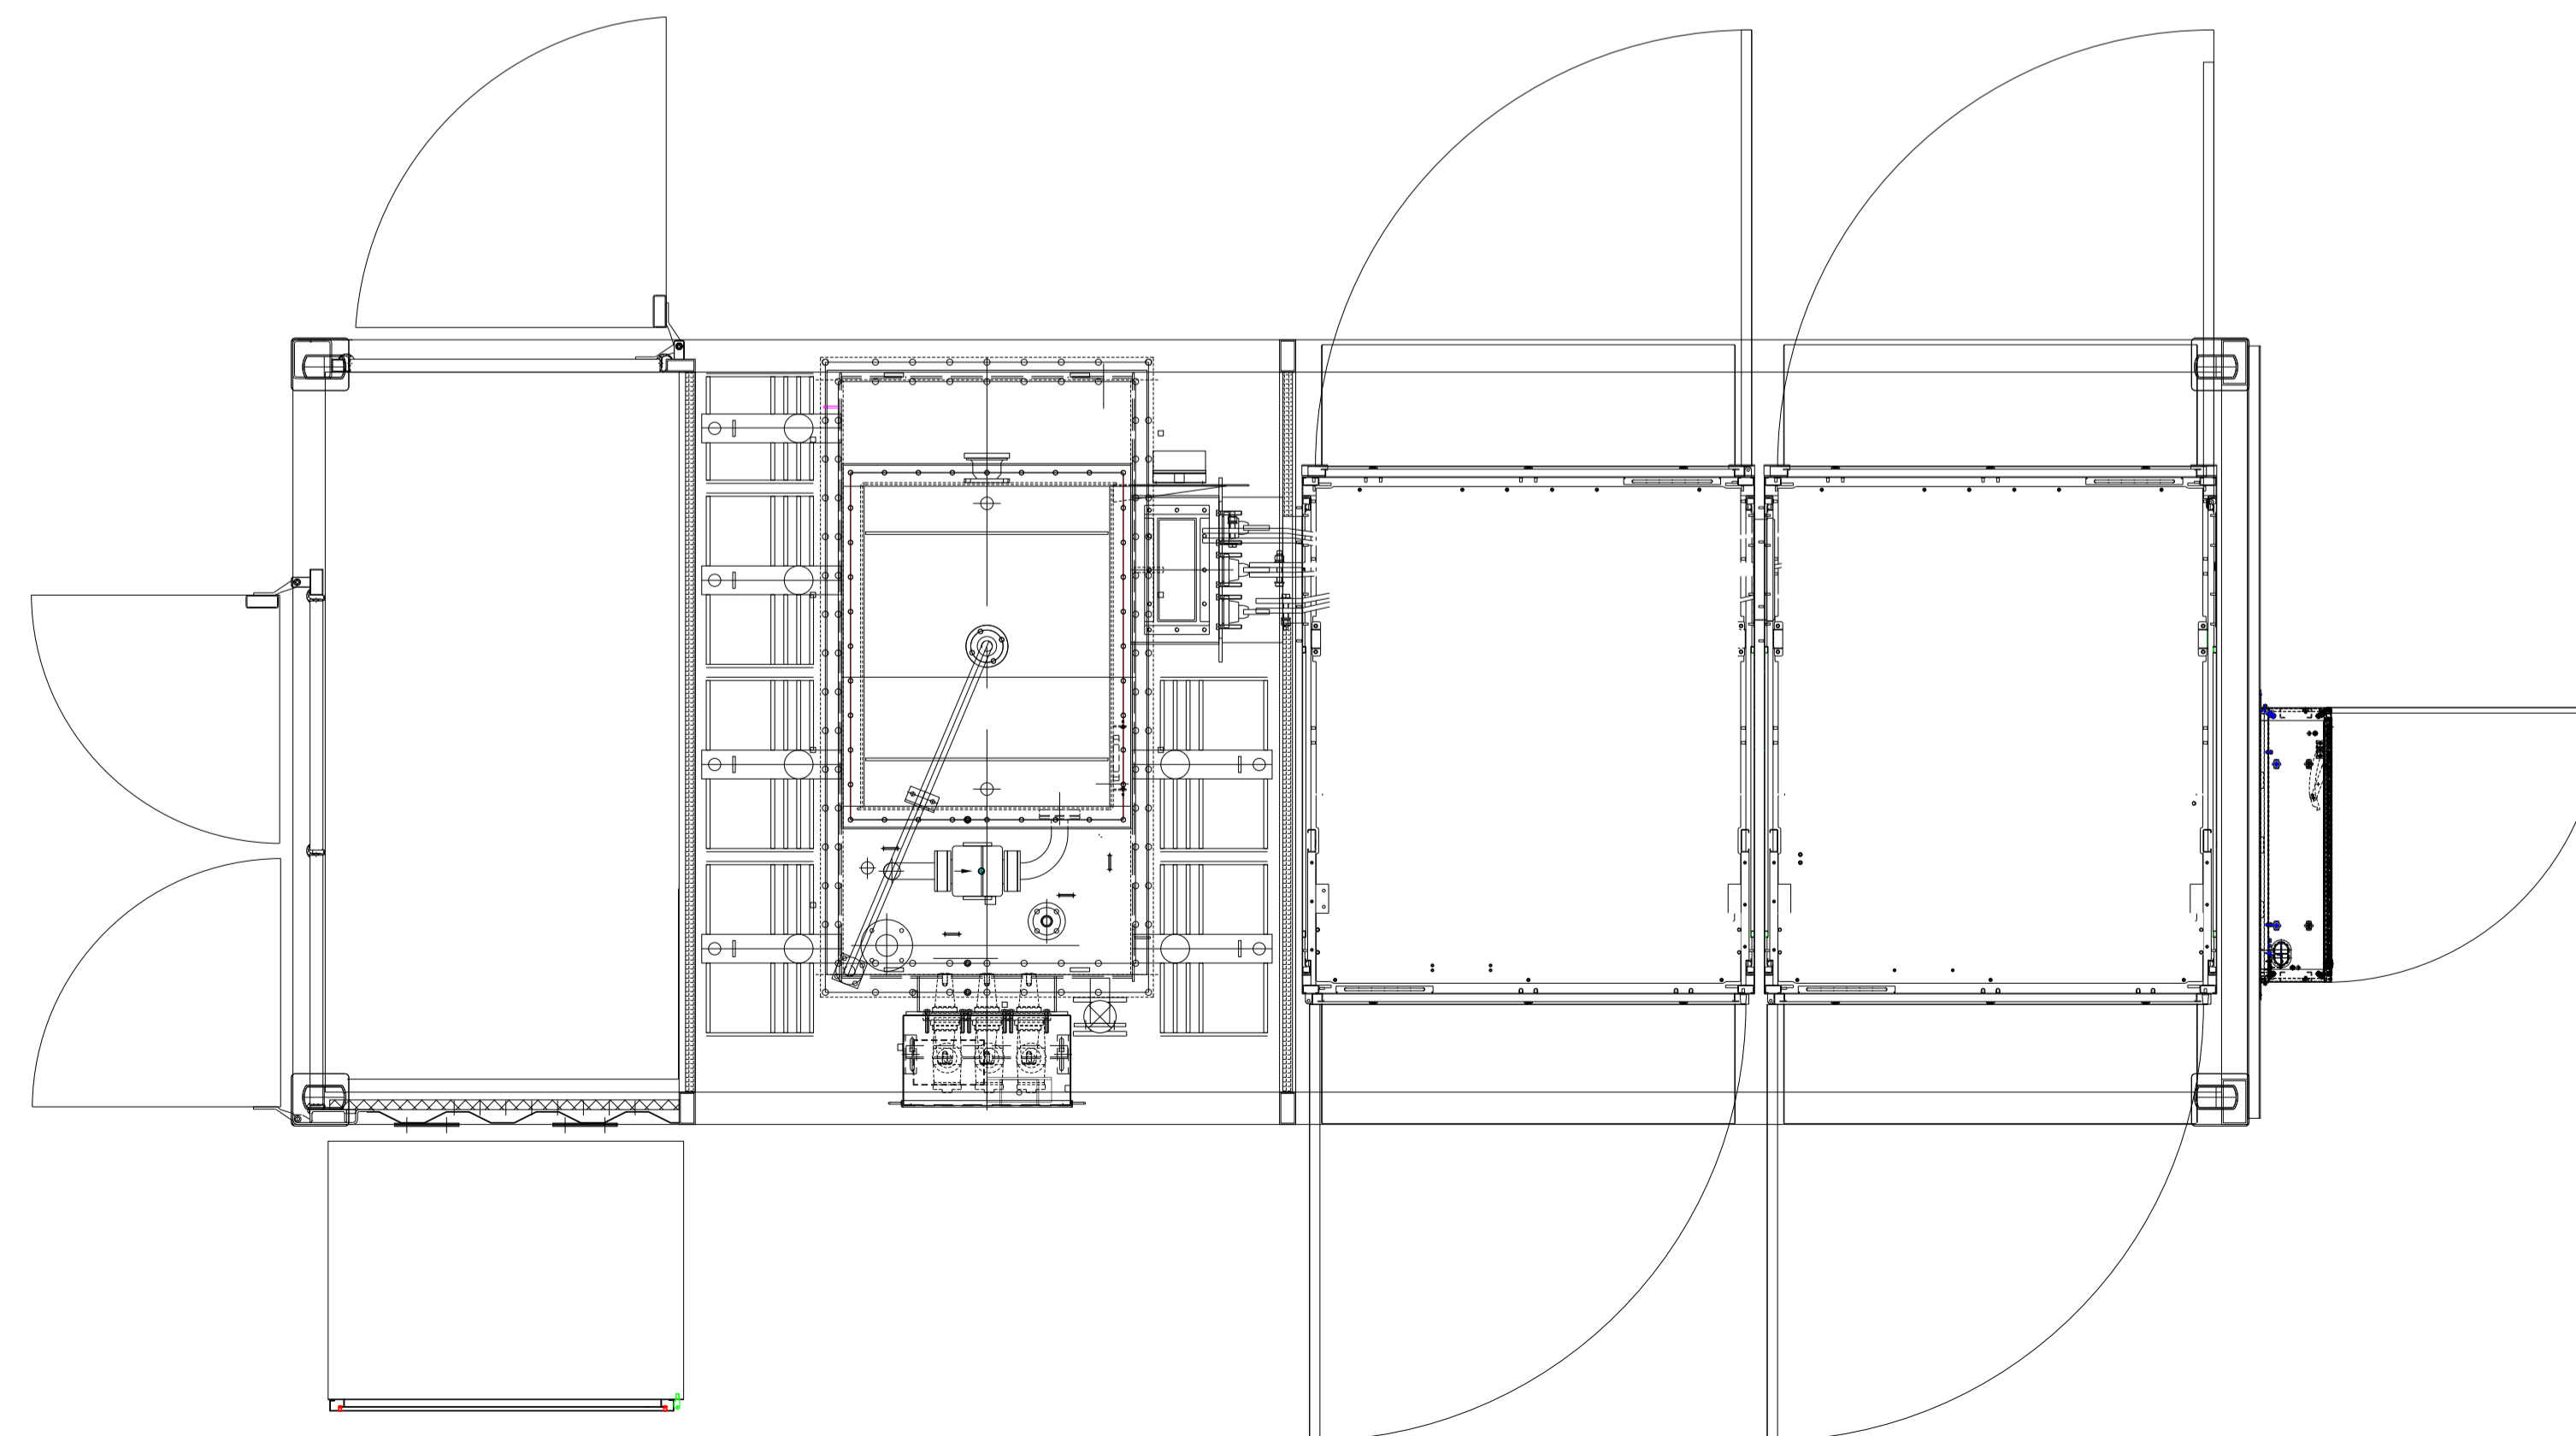

Top view

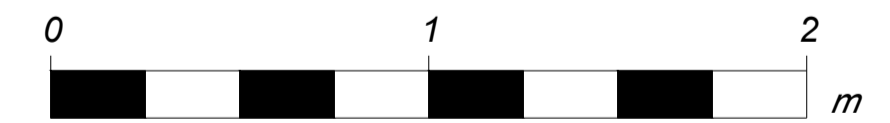

Rev.	Description	Date	Responsible
R01	First Issue	2025-06-13	AL

This document and its contents are confidential and it is intended solely for the use of the recipient(s) to whom it is addressed. All content, including drawings, designs, and other materials, are the intellectual property of Elements Green Trent Ltd. Any unauthorised use or distribution of this document without the prior written consent of Elements Green Trent Ltd (company number 13065201) is strictly prohibited. Registered Office: 1 Half Moon Street, London, England, W1J 7AY




Figure 5.15
Illustrative Power Conversion Systems (PCS) Elevations

Illustrative Purposes Only


Drawing No. **UK003-PV-ENG-0-460-R00-5.15**

ABBREVIATIONS:




AUX TX	AUXILIARY TRANSFORMER	HL	HIGH LEVEL
CB	CIRCUIT BREAKER	LL	LOW LEVEL
CSE	CABLE SEALING END	PI	POST INSULATOR
D/S	DISCONNECTOR	SA	SURGE ARRESTER
E/S	EARTH SWITCH	GTX	GRID TRANSFORMER

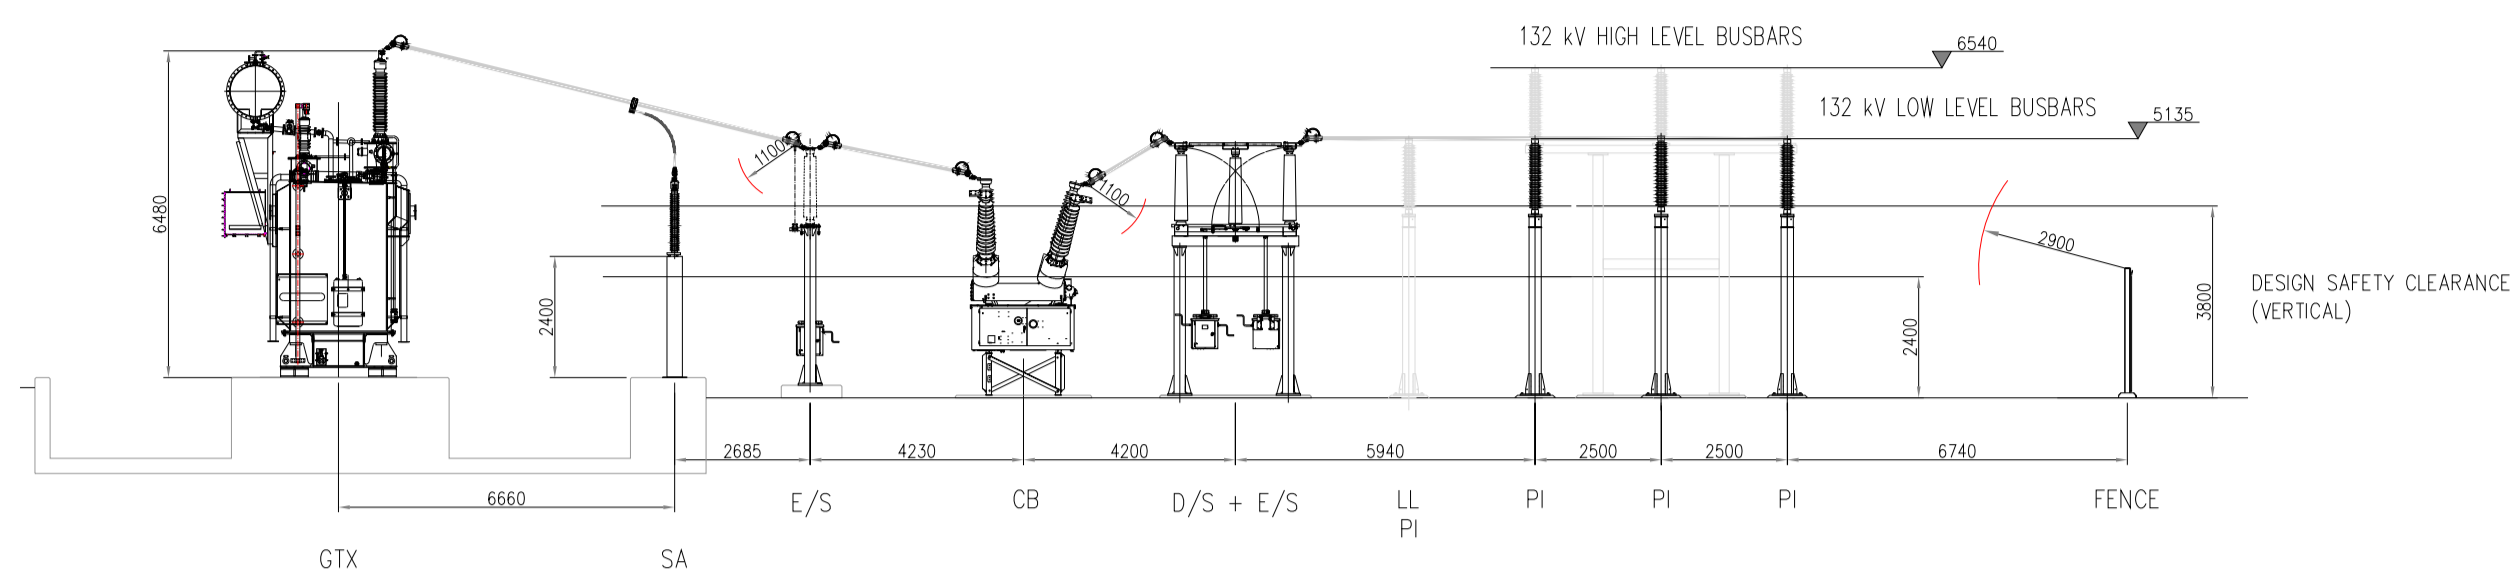


132kV COMPOUND ELEVATION VIEW
SCALE 1:150

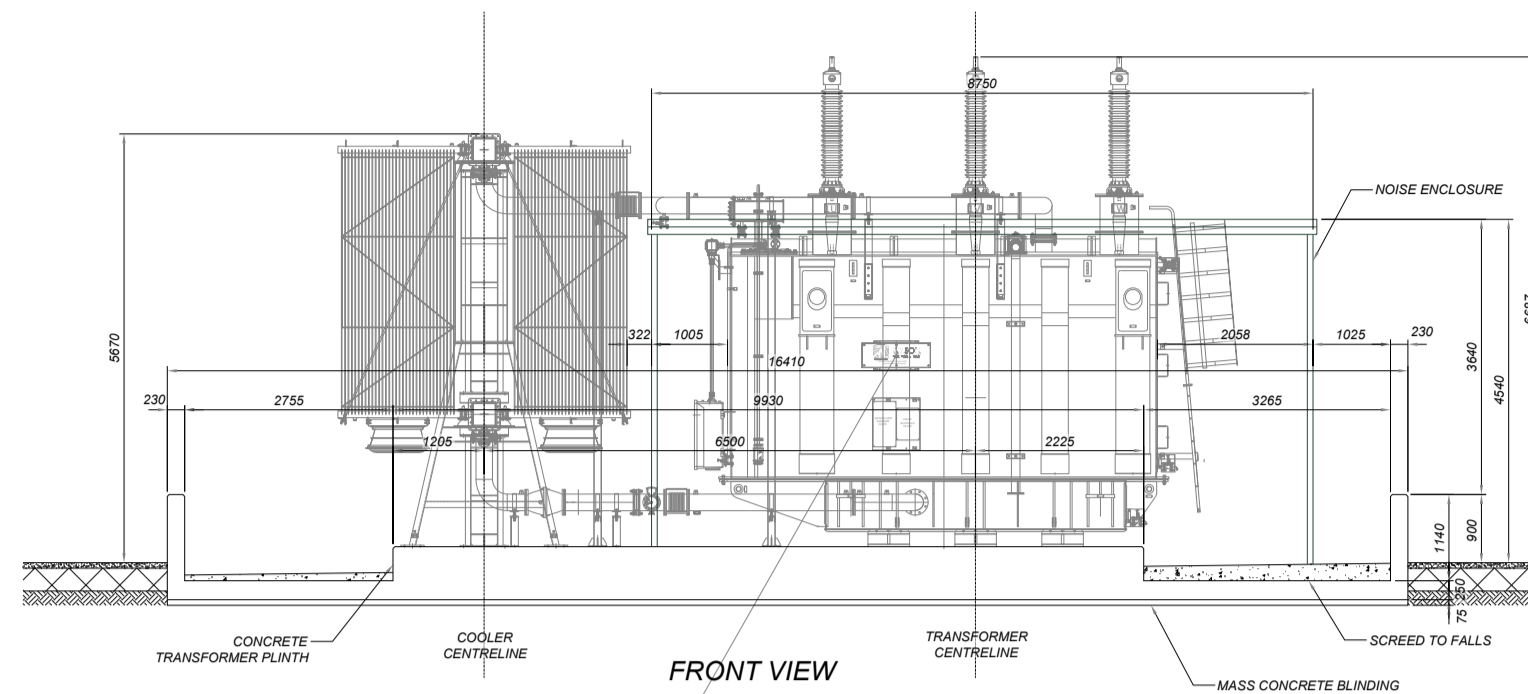

132kV TRANSFORMER BUNDLE
SCALE 1:100

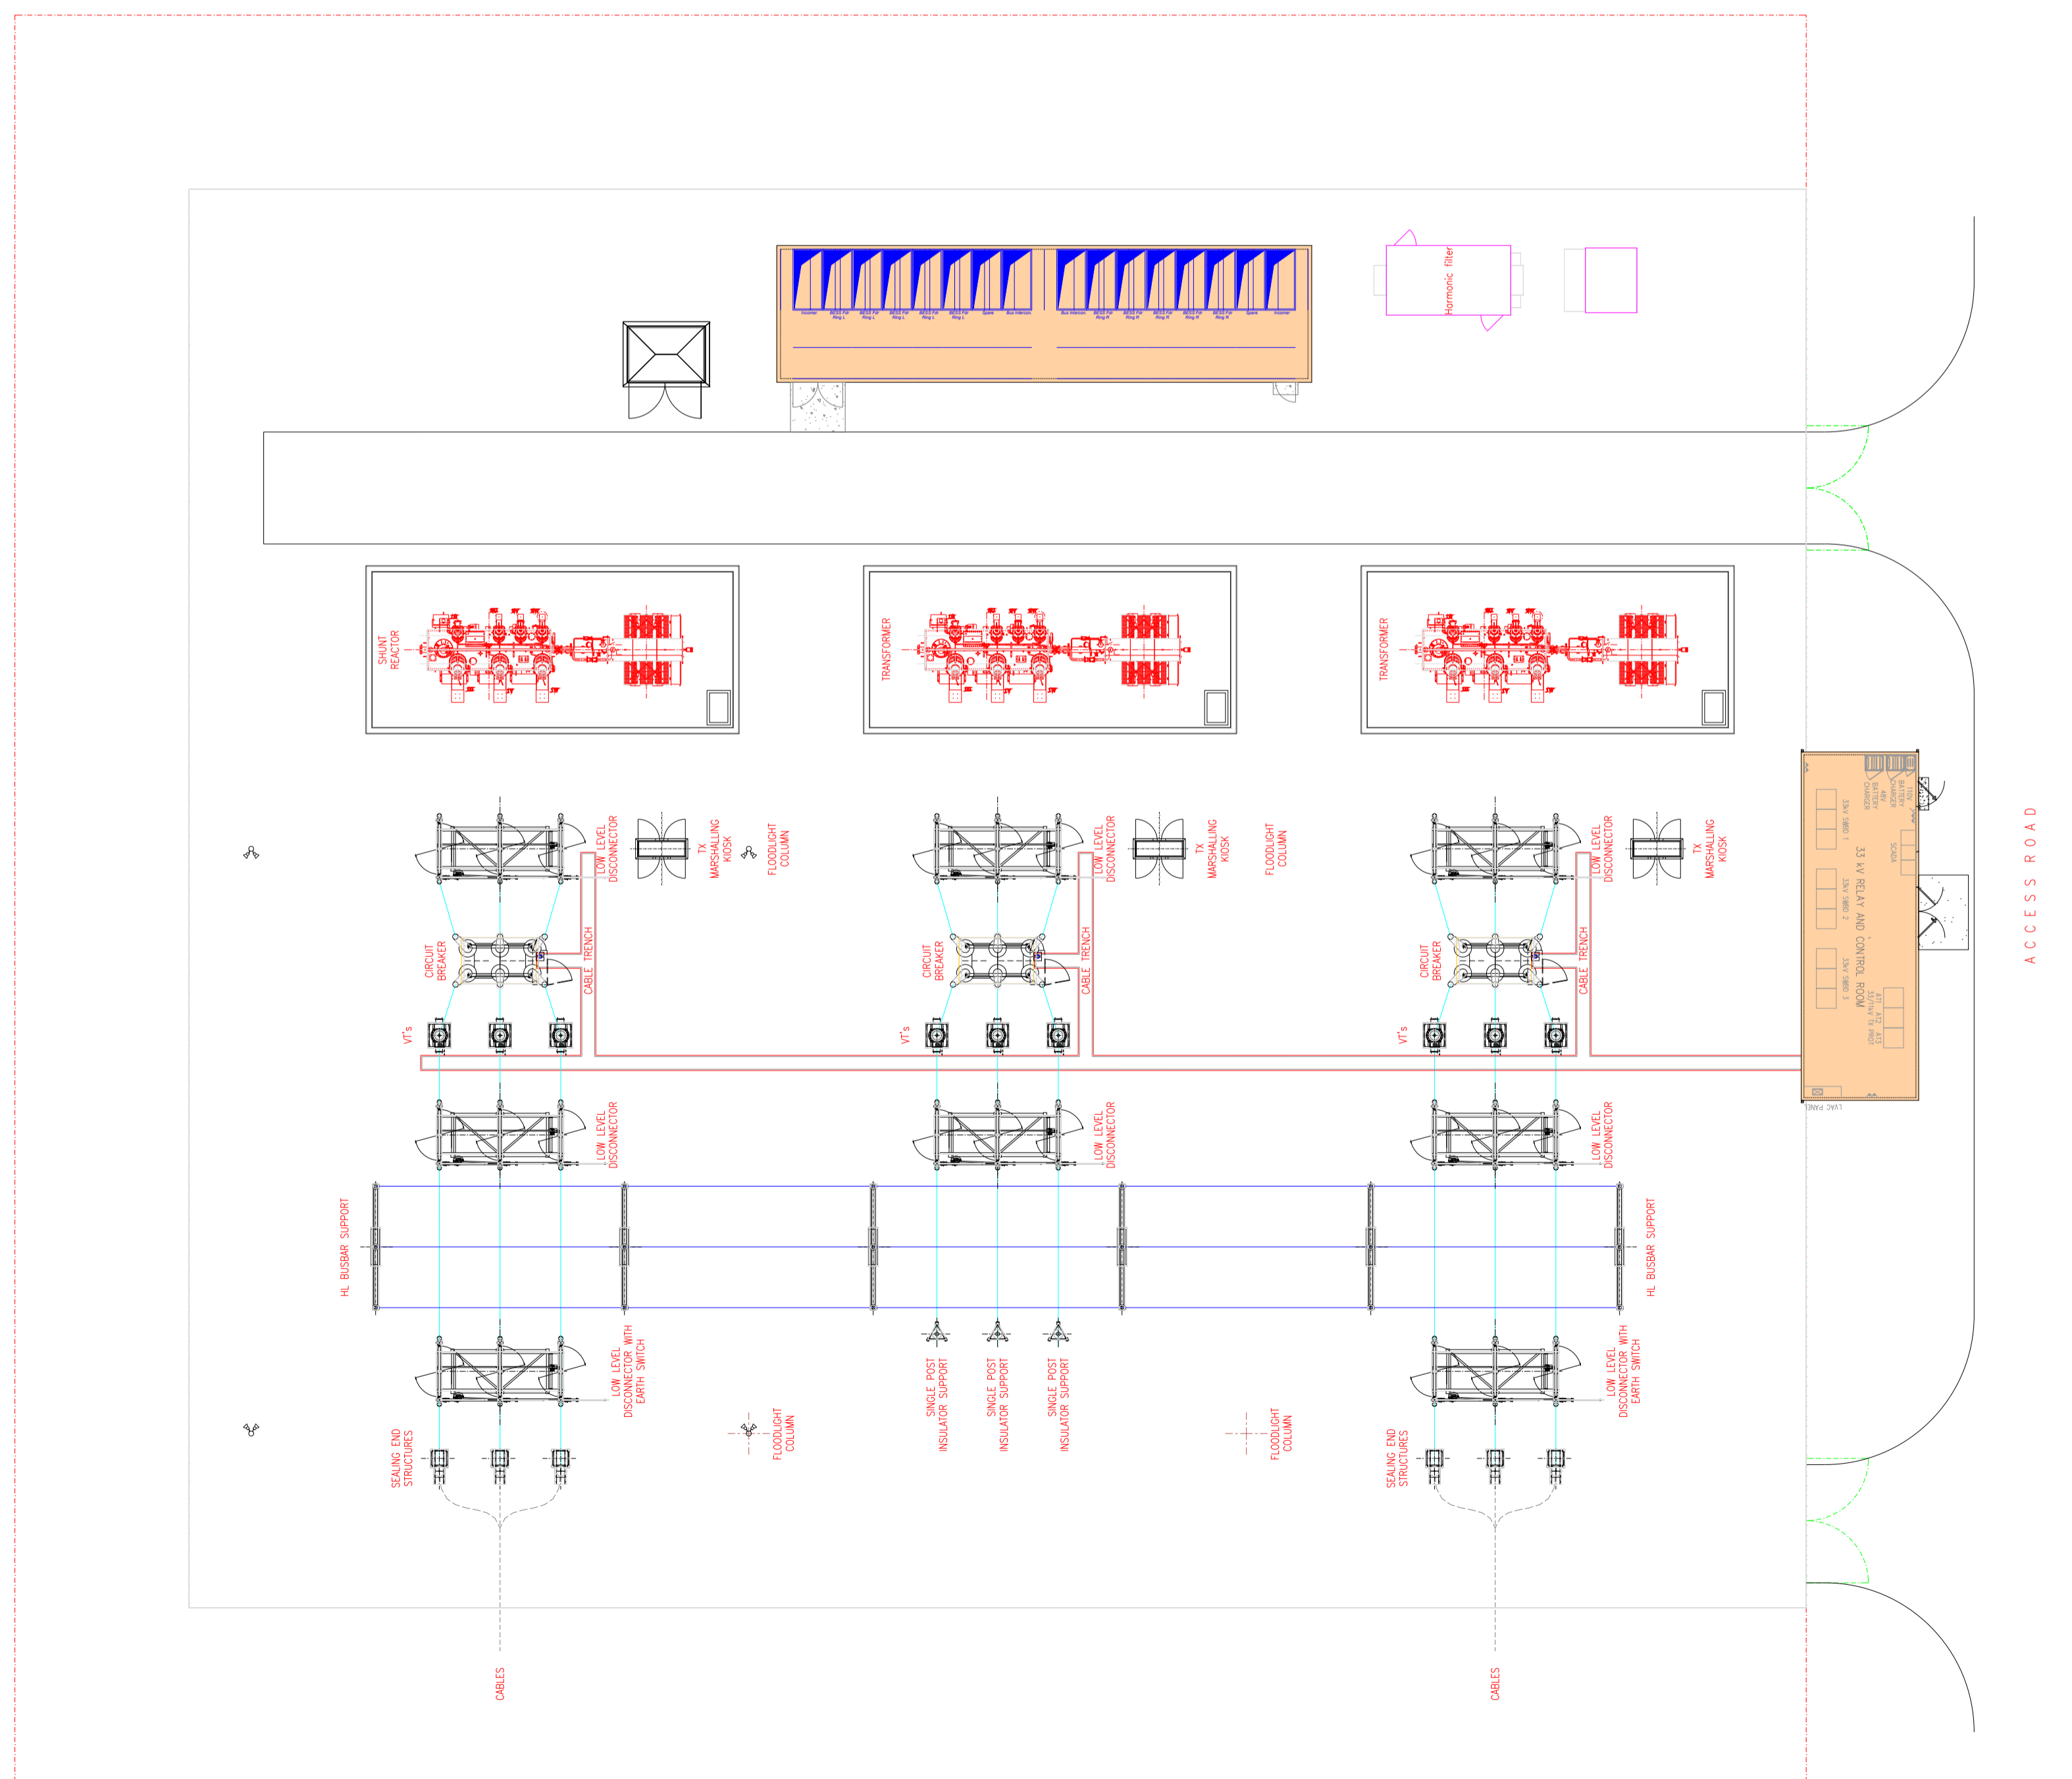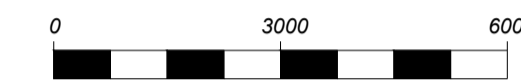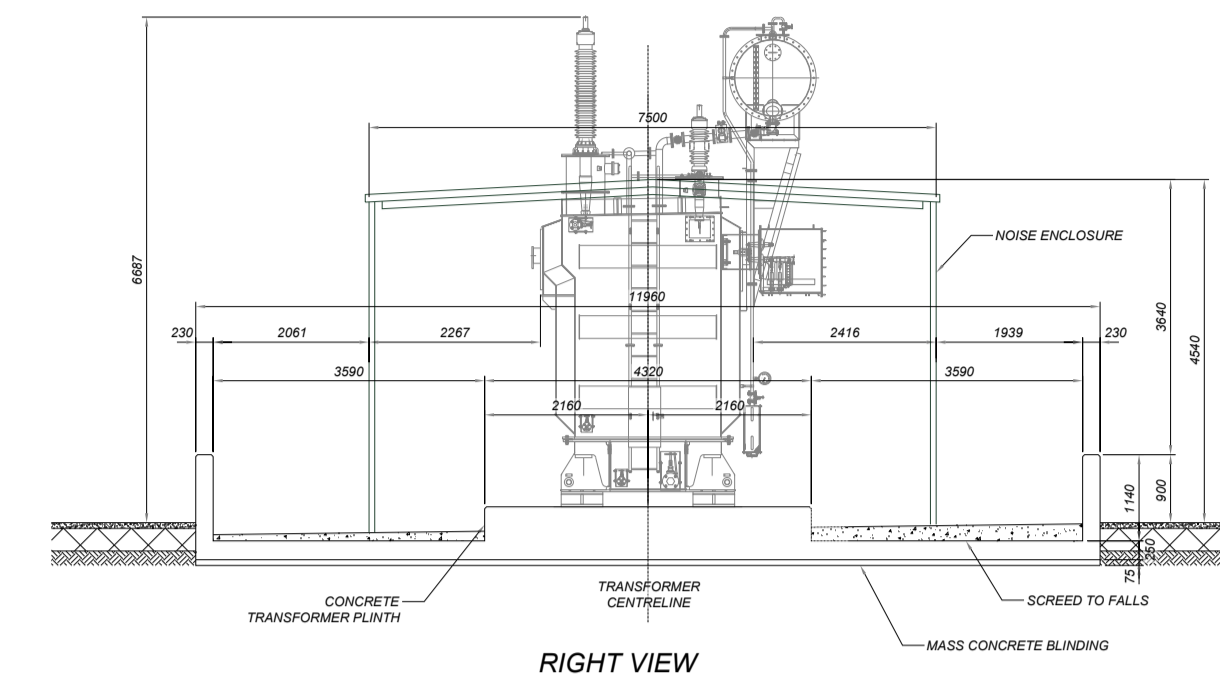

132kV COMPOUND LAYOUT
SCALE 1:200

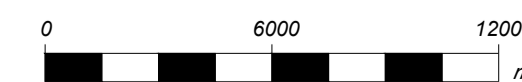

Rev	Description	Date	Responsible
R01	First Issue	2025-06-13	AL


This document and its contents are confidential and it is intended solely for the use of the recipient(s) to whom it is addressed. All content, including drawings, designs, and other materials, are the intellectual property of Elements Green Trent Ltd. Any unauthorised use or distribution of this document without the prior written consent of Elements Green Trent Ltd (company number 13065201) is strictly prohibited. Registered Office: 1 Half Moon Street, London, England, W1J 7AY




Drawing Title
Figure 5.16
Illustrative 132kV Substation Elevation

Illustrative Purposes Only

Drawing No. **UK003-PV-ENG-0-460-R00-5.16**

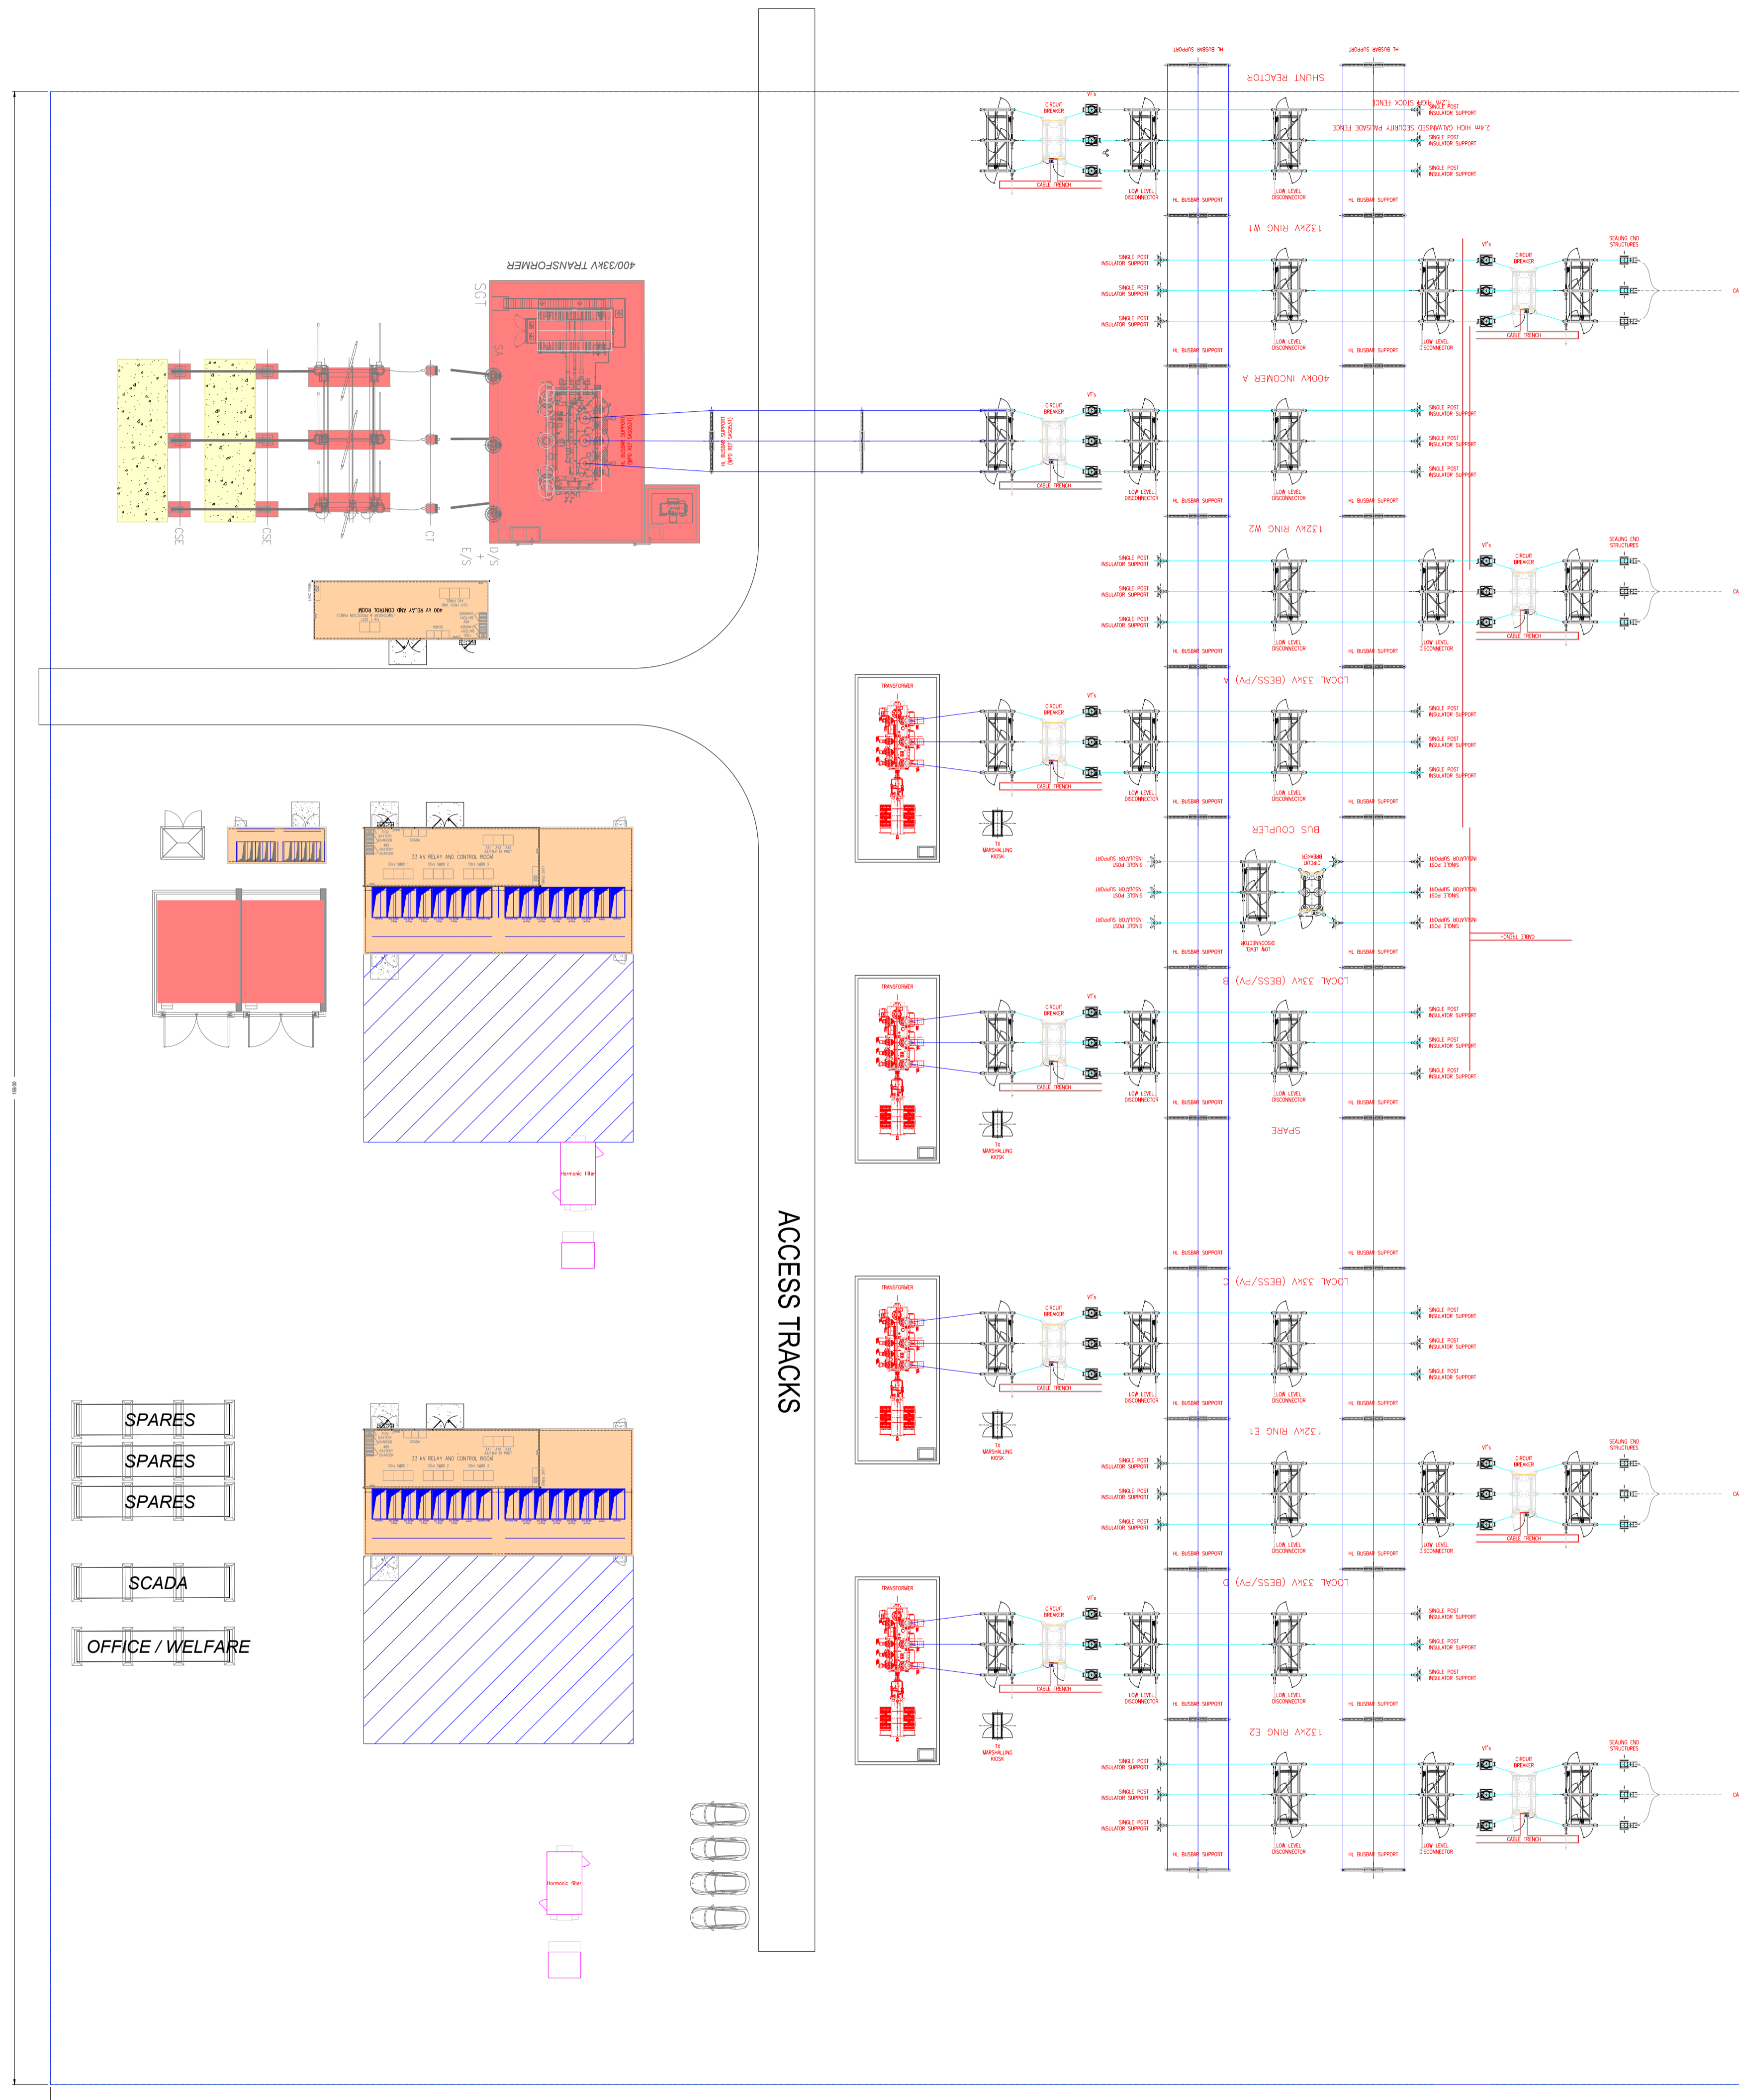

400kV COMPOUND LAYOUT

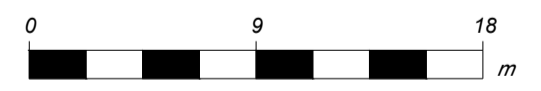

Rev.	Description	Date	Responsible
R01	First Issue	2025-06-13	AL





This document and its contents are confidential and it is intended solely for the use of the recipient(s) to whom it is addressed. All content, including drawings, designs, and other materials, are the intellectual property of Elements Green Trent Ltd. Any unauthorised use or distribution of this document without the prior written consent of Elements Green Trent Ltd (company number 13065201) is strictly prohibited. Registered Office: 1 Half Moon Street, London, England, W1J 7AY




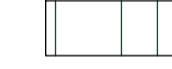
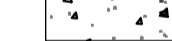
Figure 5.17
Illustrative 400kV Substation Elevation

Illustrative Purposes Only

Drawing No: **UK003-PV-ENG-0-460-R00-5.17.1**

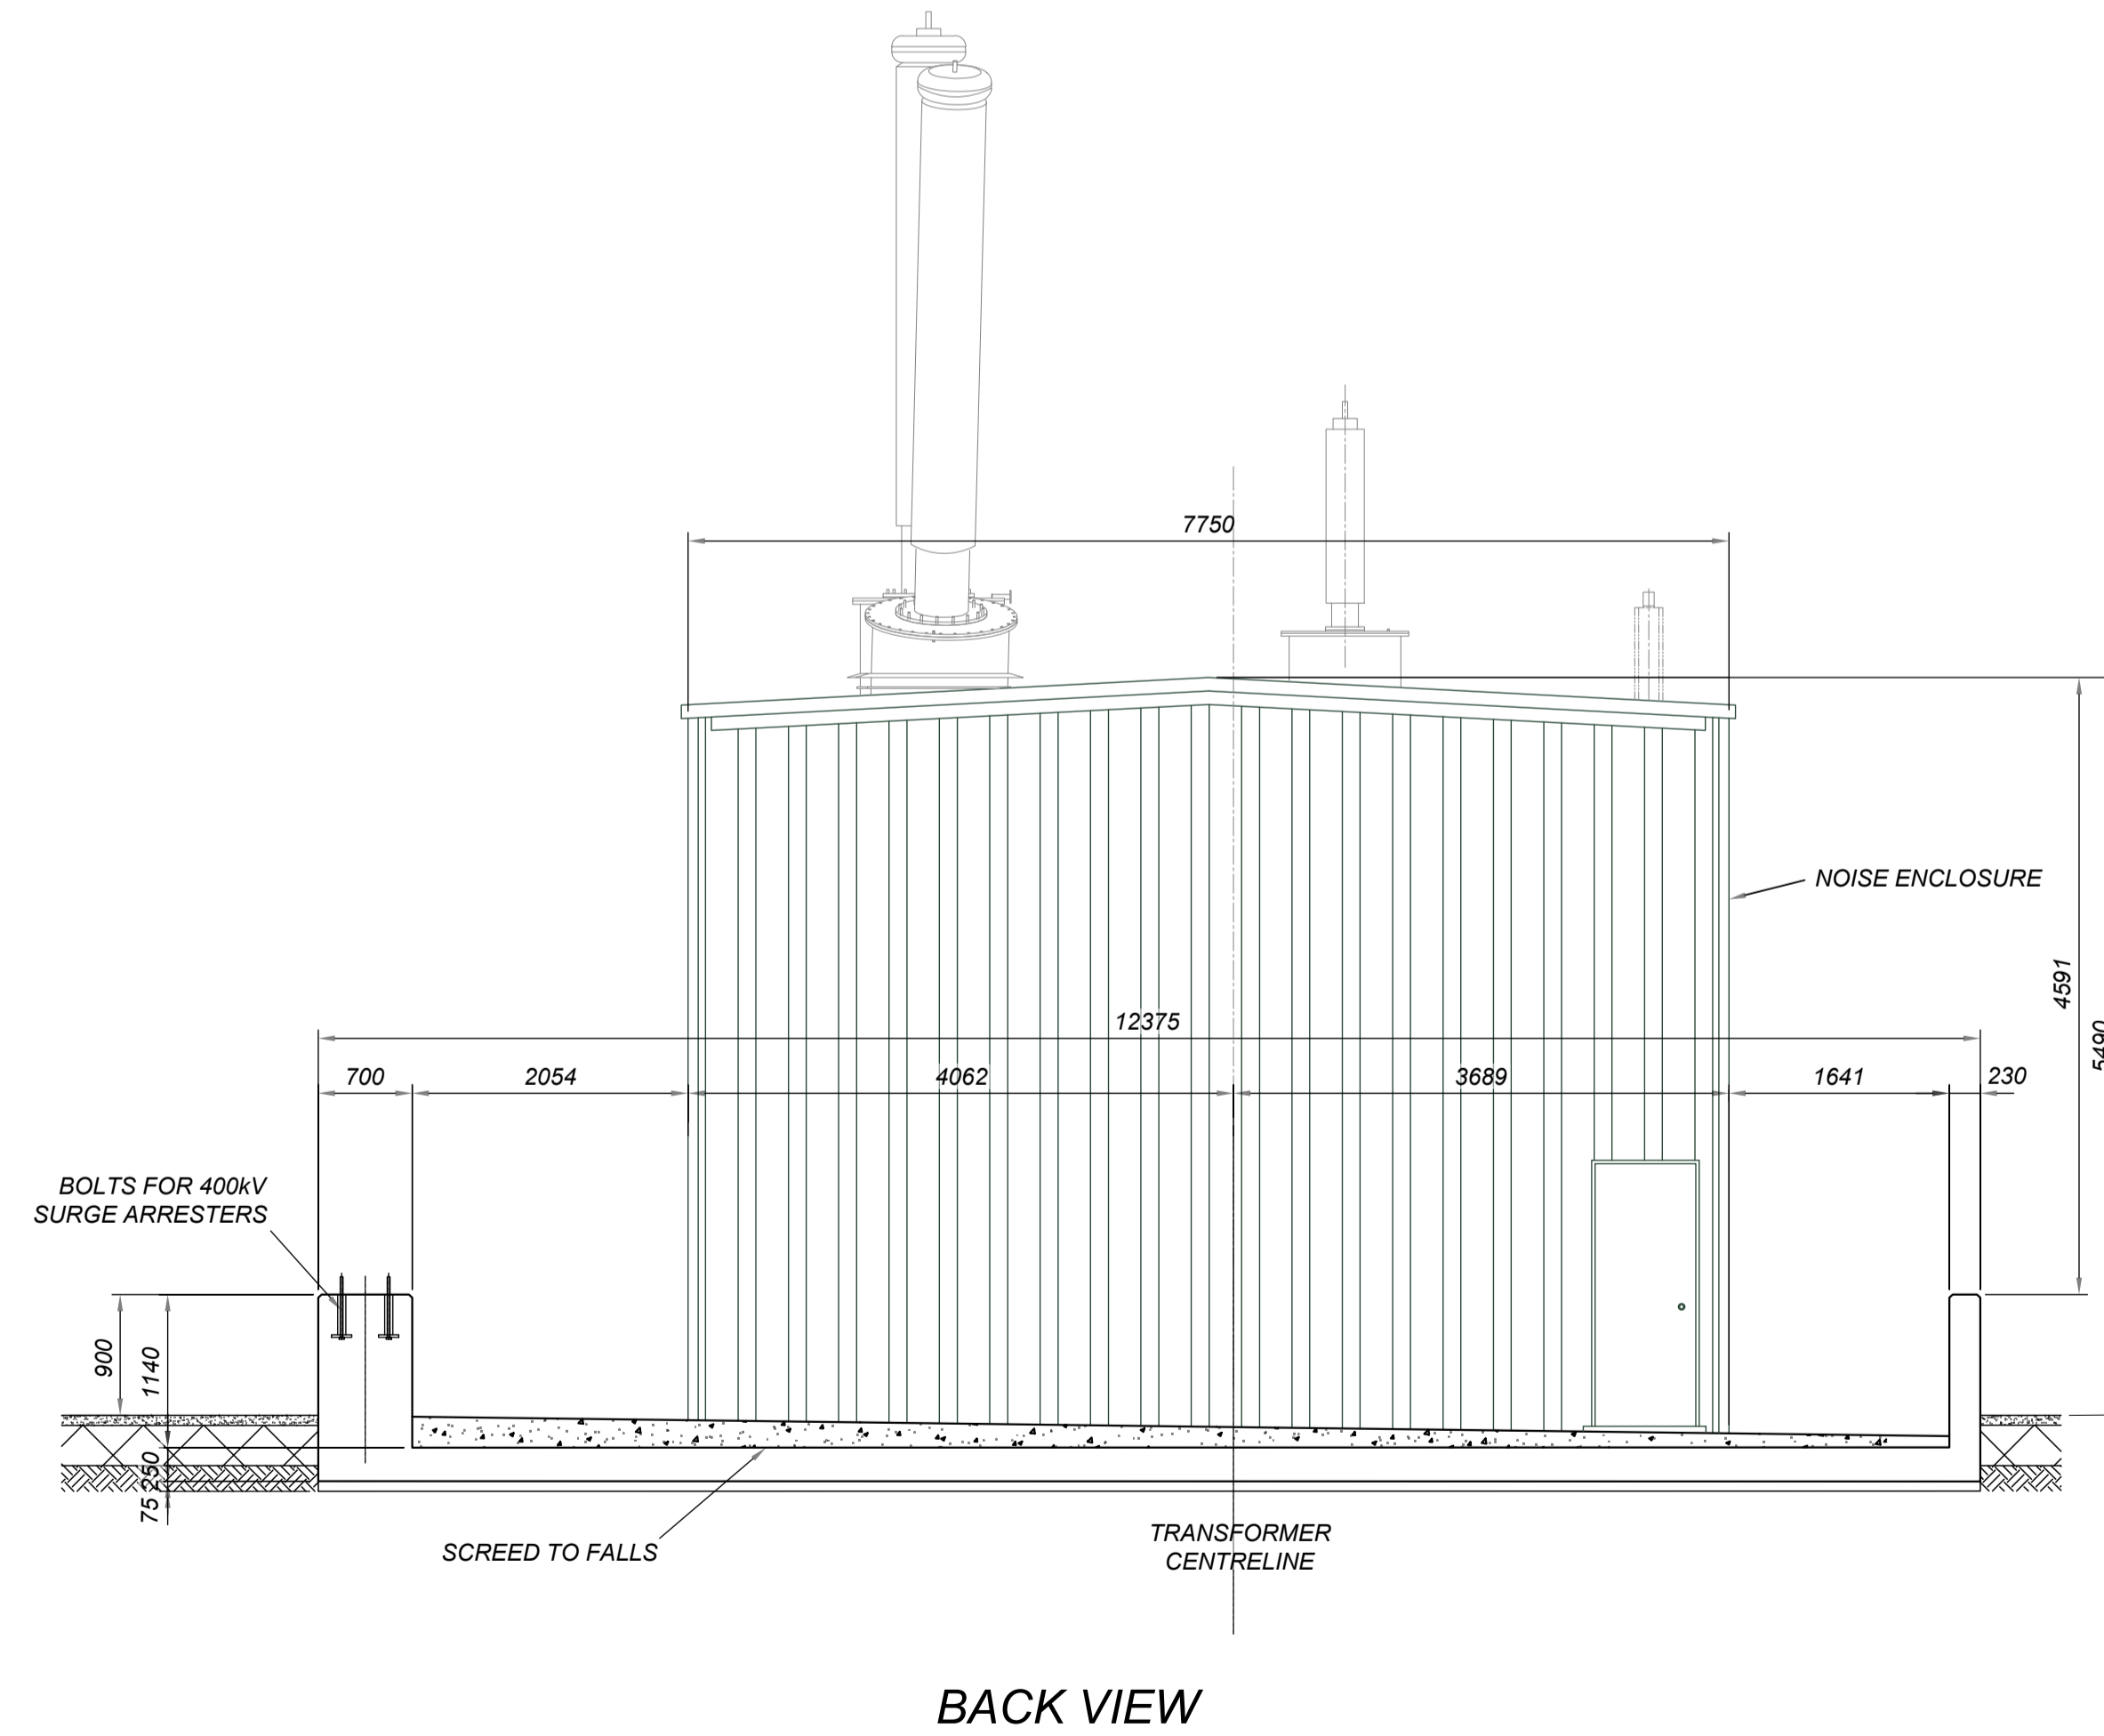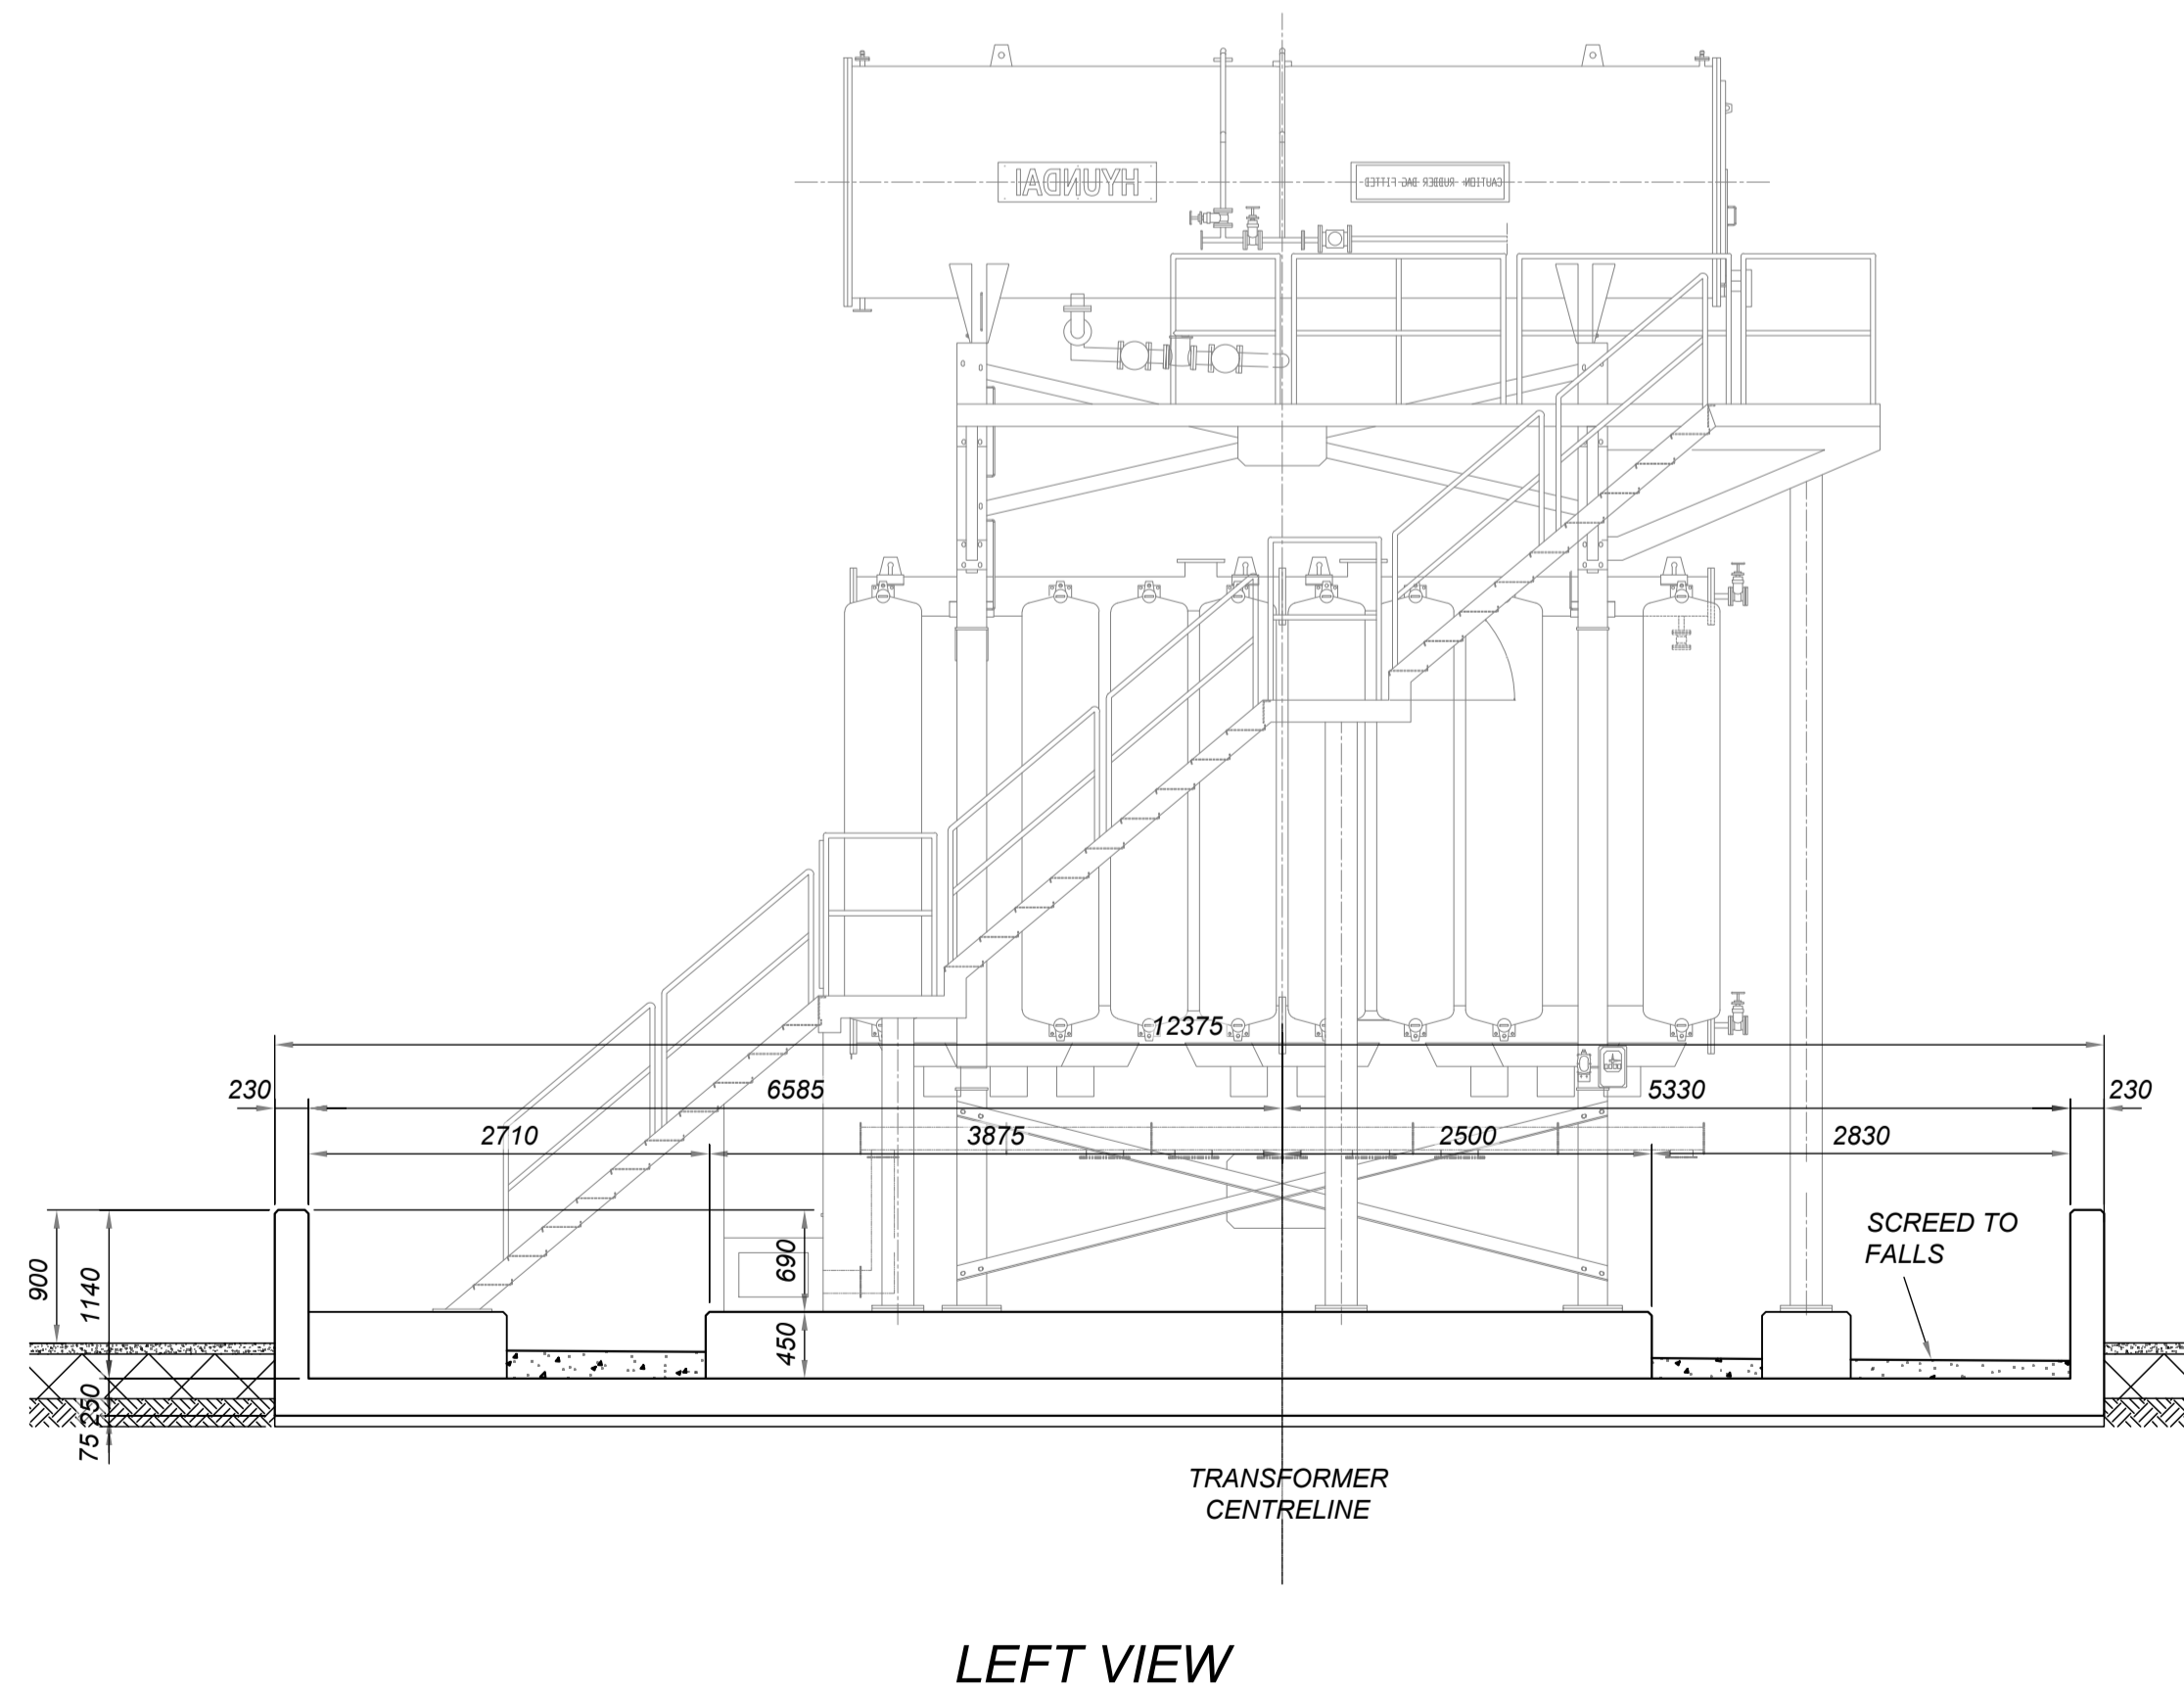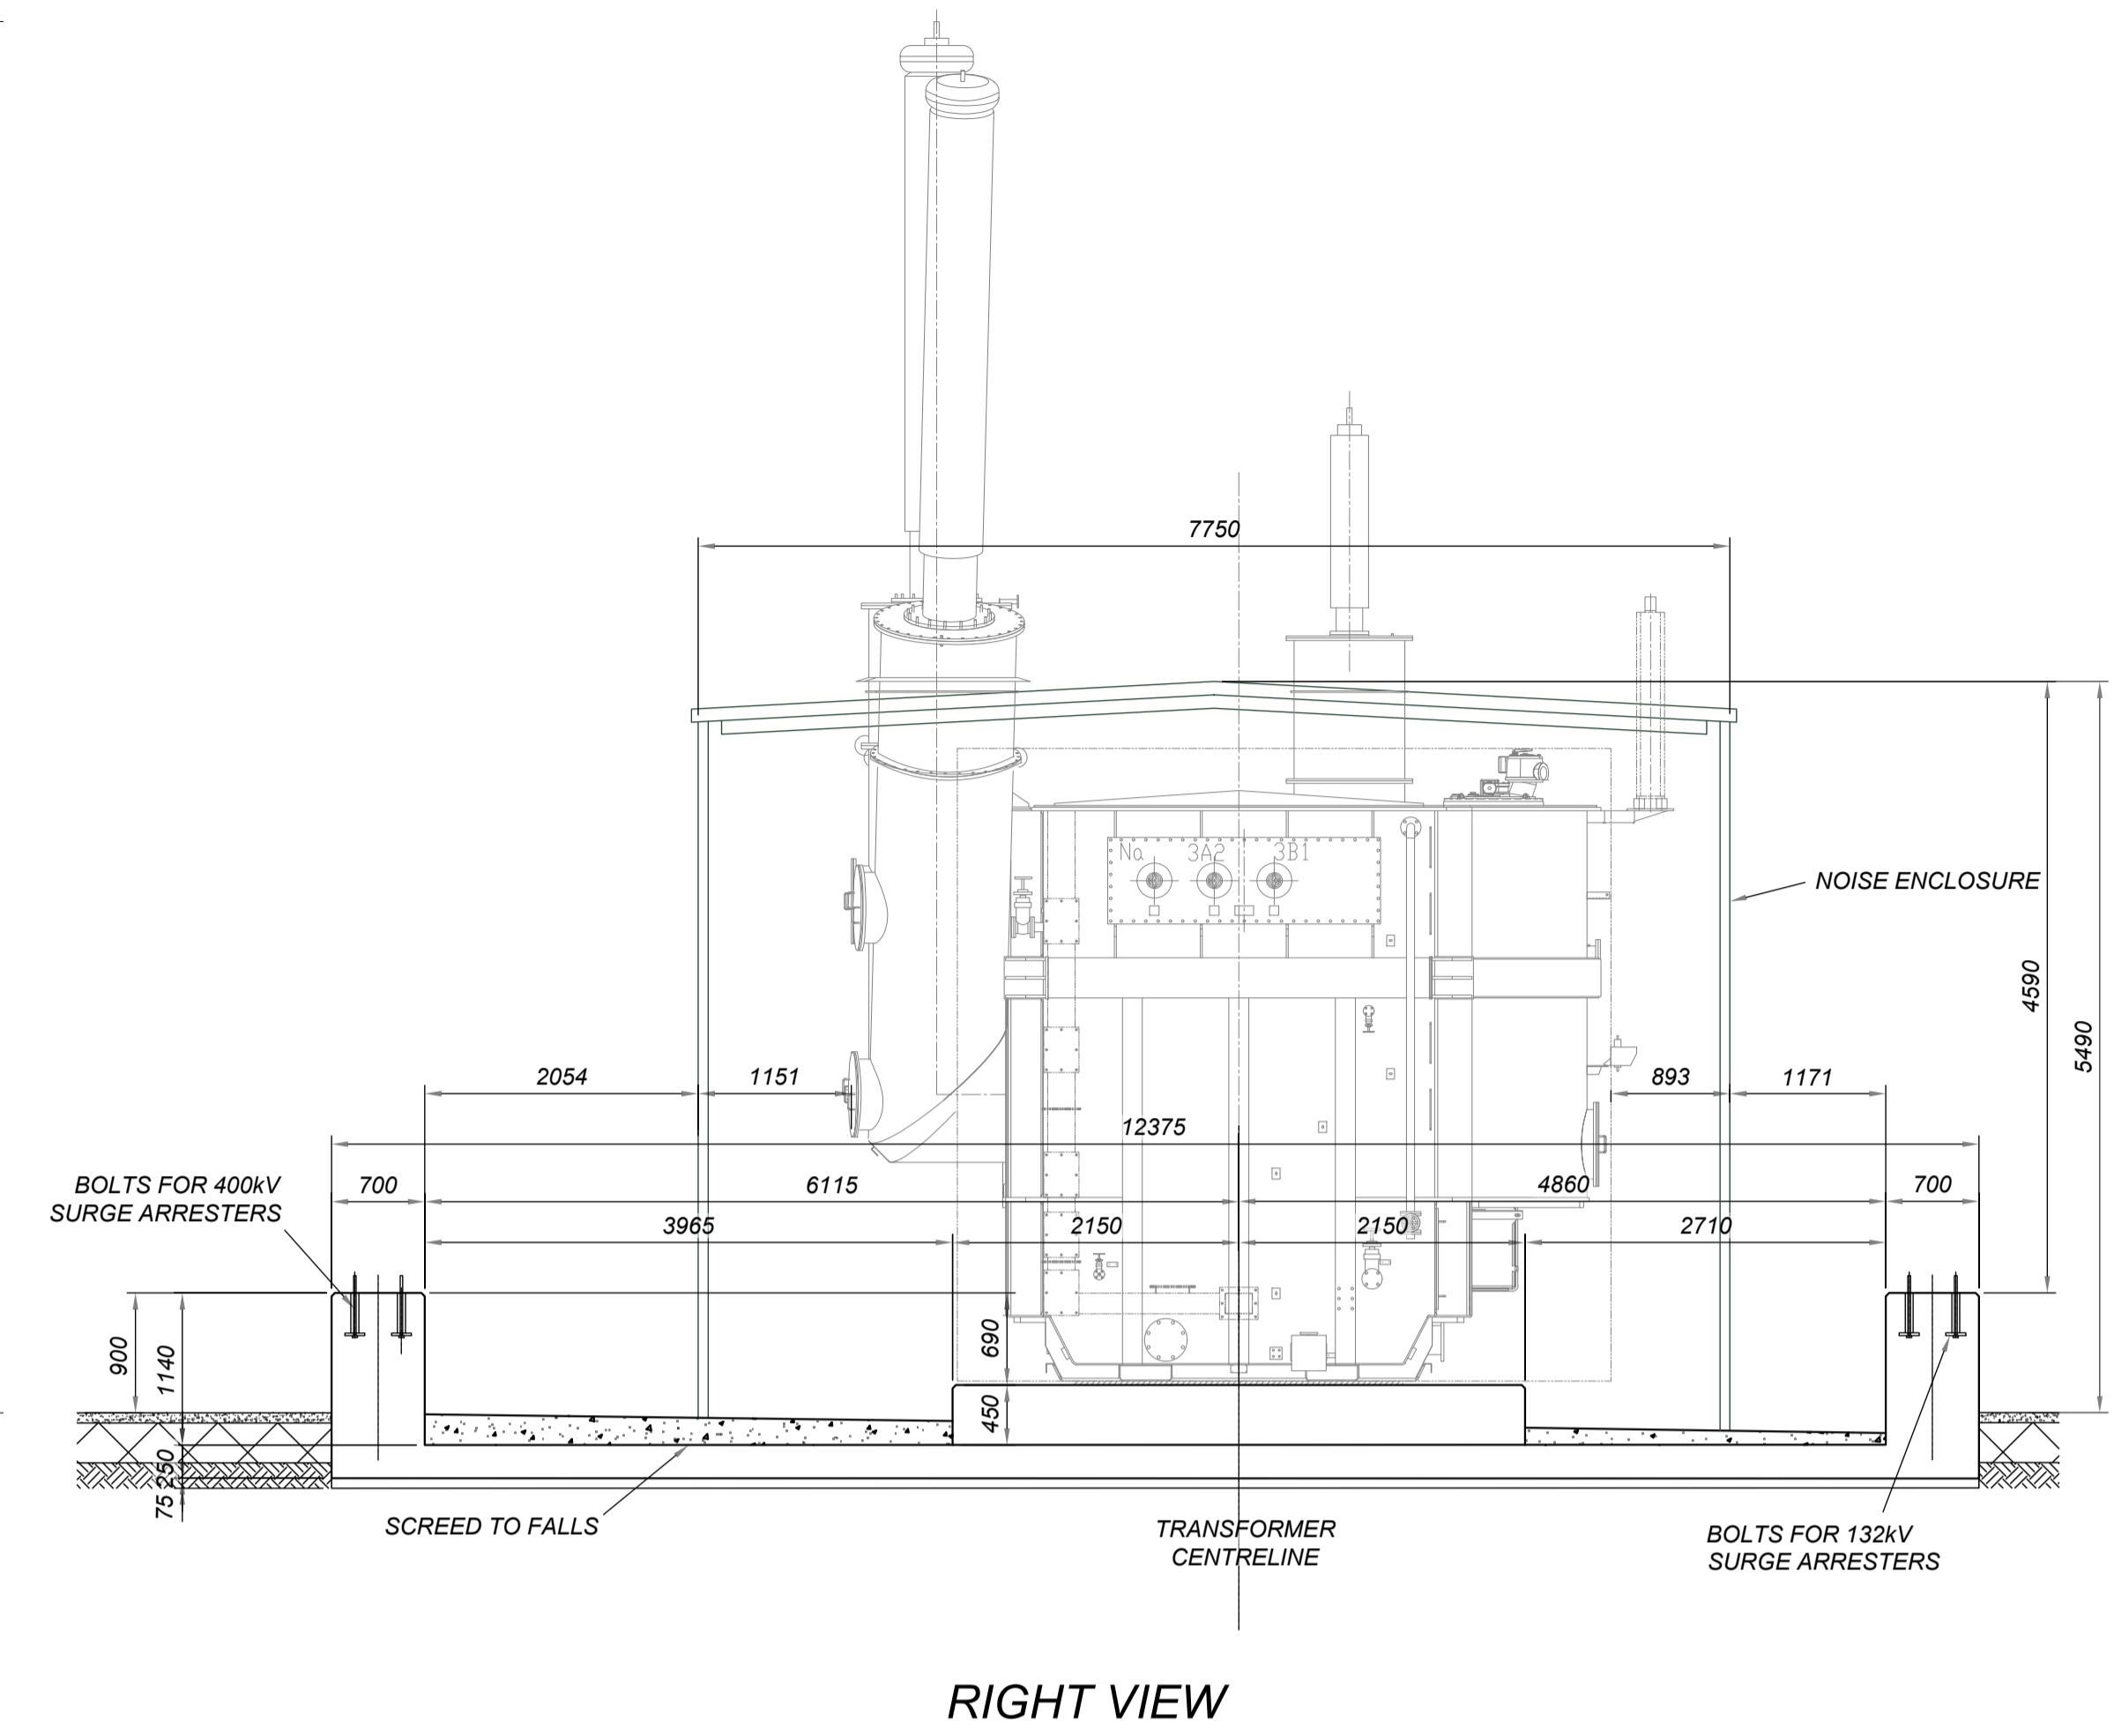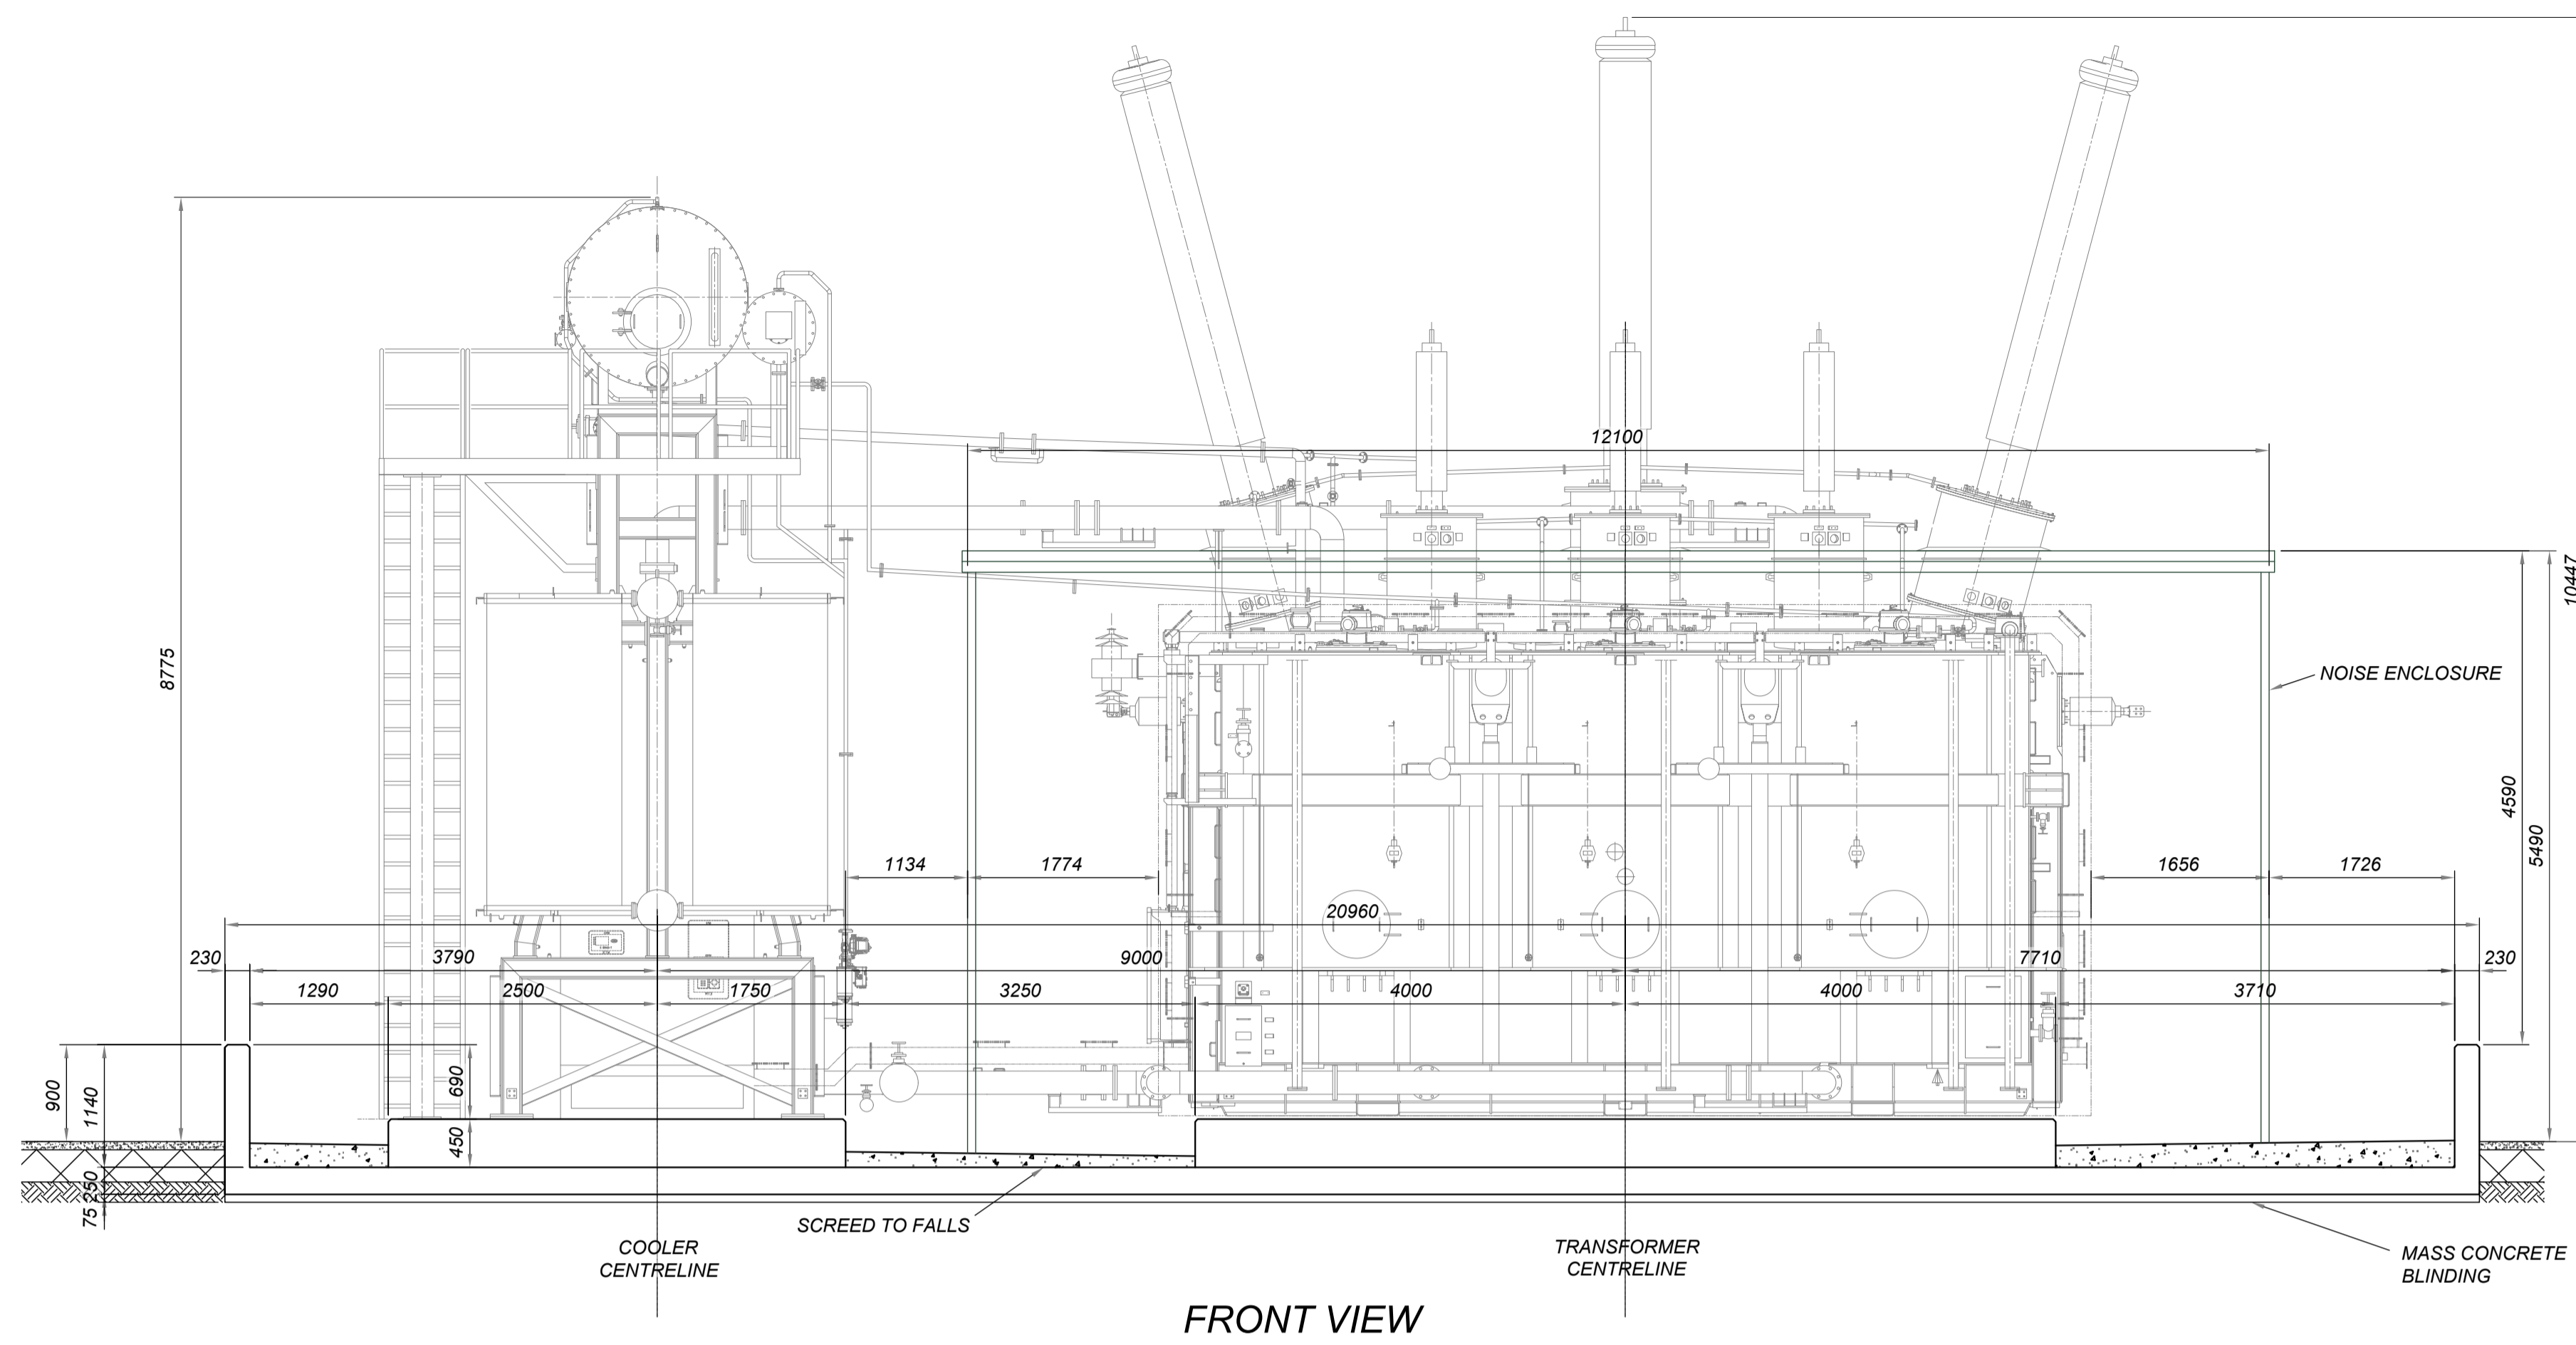



KEY:

-  CONCRETE WALLS & PLINTHS
-  NOISE ENCLOSURE
-  CONCRETE SCREED

Rev.	Description	Date	Responsible
R01	First Issue	2025-06-13	AL

TRANSFORMER BUNDLE ELEVATIONS

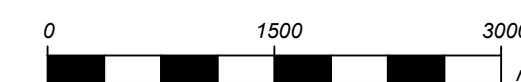



Solar & Biodiversity Park

Drawing Title
**Figure 5.17
400kV Substation Elevations**


Illustrative Purposes Only

Drawing No.
UK003-PV-ENG-0-460-R00-5.17.2

Designed by AL	Approved by OC	Date 2025-06-13	Scale 1:50	Dimensions in mm	Paper Size A1 (841x594)	Sheet 2/3
--------------------------	--------------------------	---------------------------	----------------------	----------------------------	-----------------------------------	---------------------

ABBREVIATIONS:

CB	CIRCUIT BREAKER
CSE	CABLE SEALING END
CVT	CAPACITIVE VOLTAGE TRANSFORMER
D/S	DISCONNECTOR
E/S	EARTH SWITCH
PI	POST INSULATOR
SA	SURGE ARRESTER
SGT	SUPERGRID TRANSFORMER

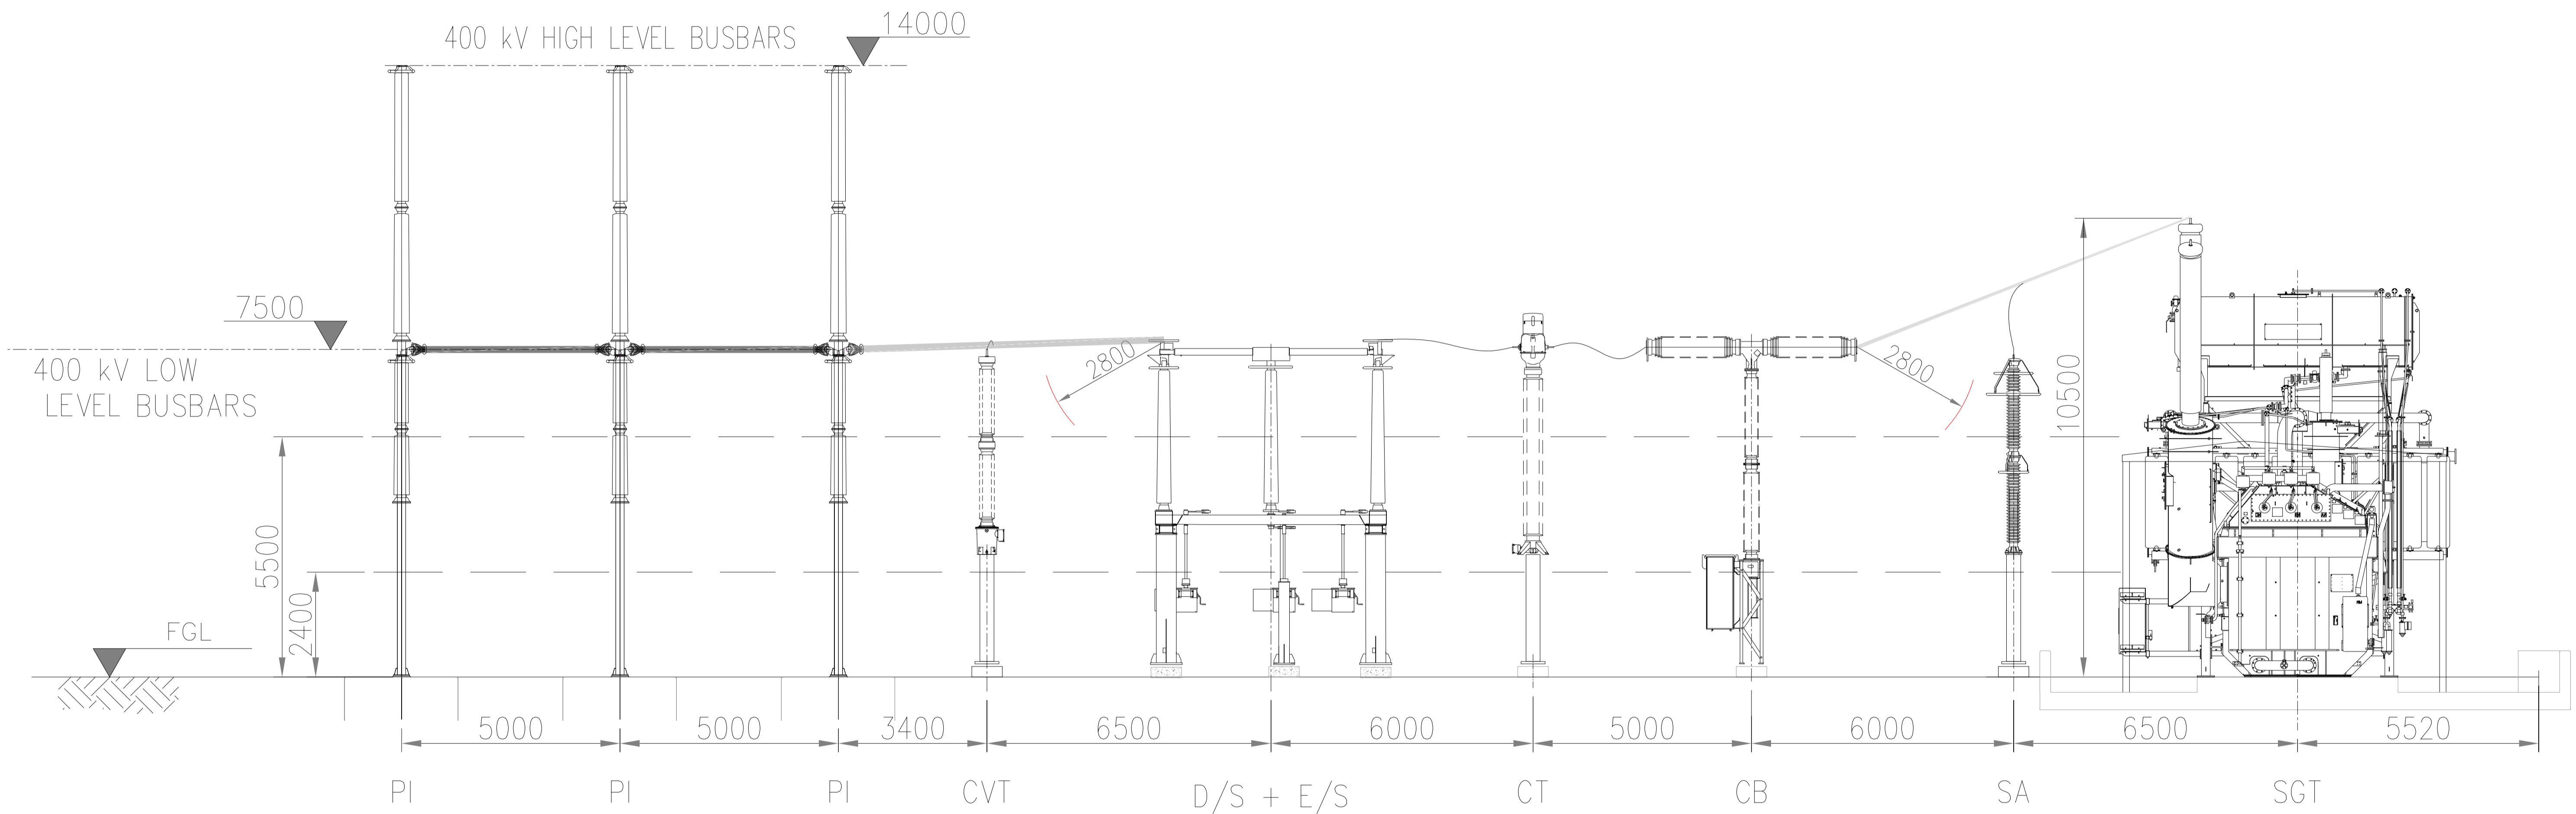

400kV COMPOUND ELEVATION VIEW

Rev.	Description	Date	Responsible
R01	First Issue	2025-06-13	AL


This document and its contents are confidential and it is intended solely for the use of the recipient(s) to whom it is addressed. All content, including drawings, designs, and other materials, are the intellectual property of Elements Green Trent Ltd. Any unauthorised use or distribution of this document without the prior written consent of Elements Green Trent Ltd (company number 13662021) is strictly prohibited. Registered Office: 1 Half Moon Street, London, England, W1J 7AY




Figure 5.17
400kV Substation Elevations


Illustrative Purposes Only

Drawing No: **UK003-PV-ENG-0-460-R00-5.17.3**

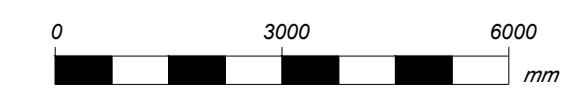


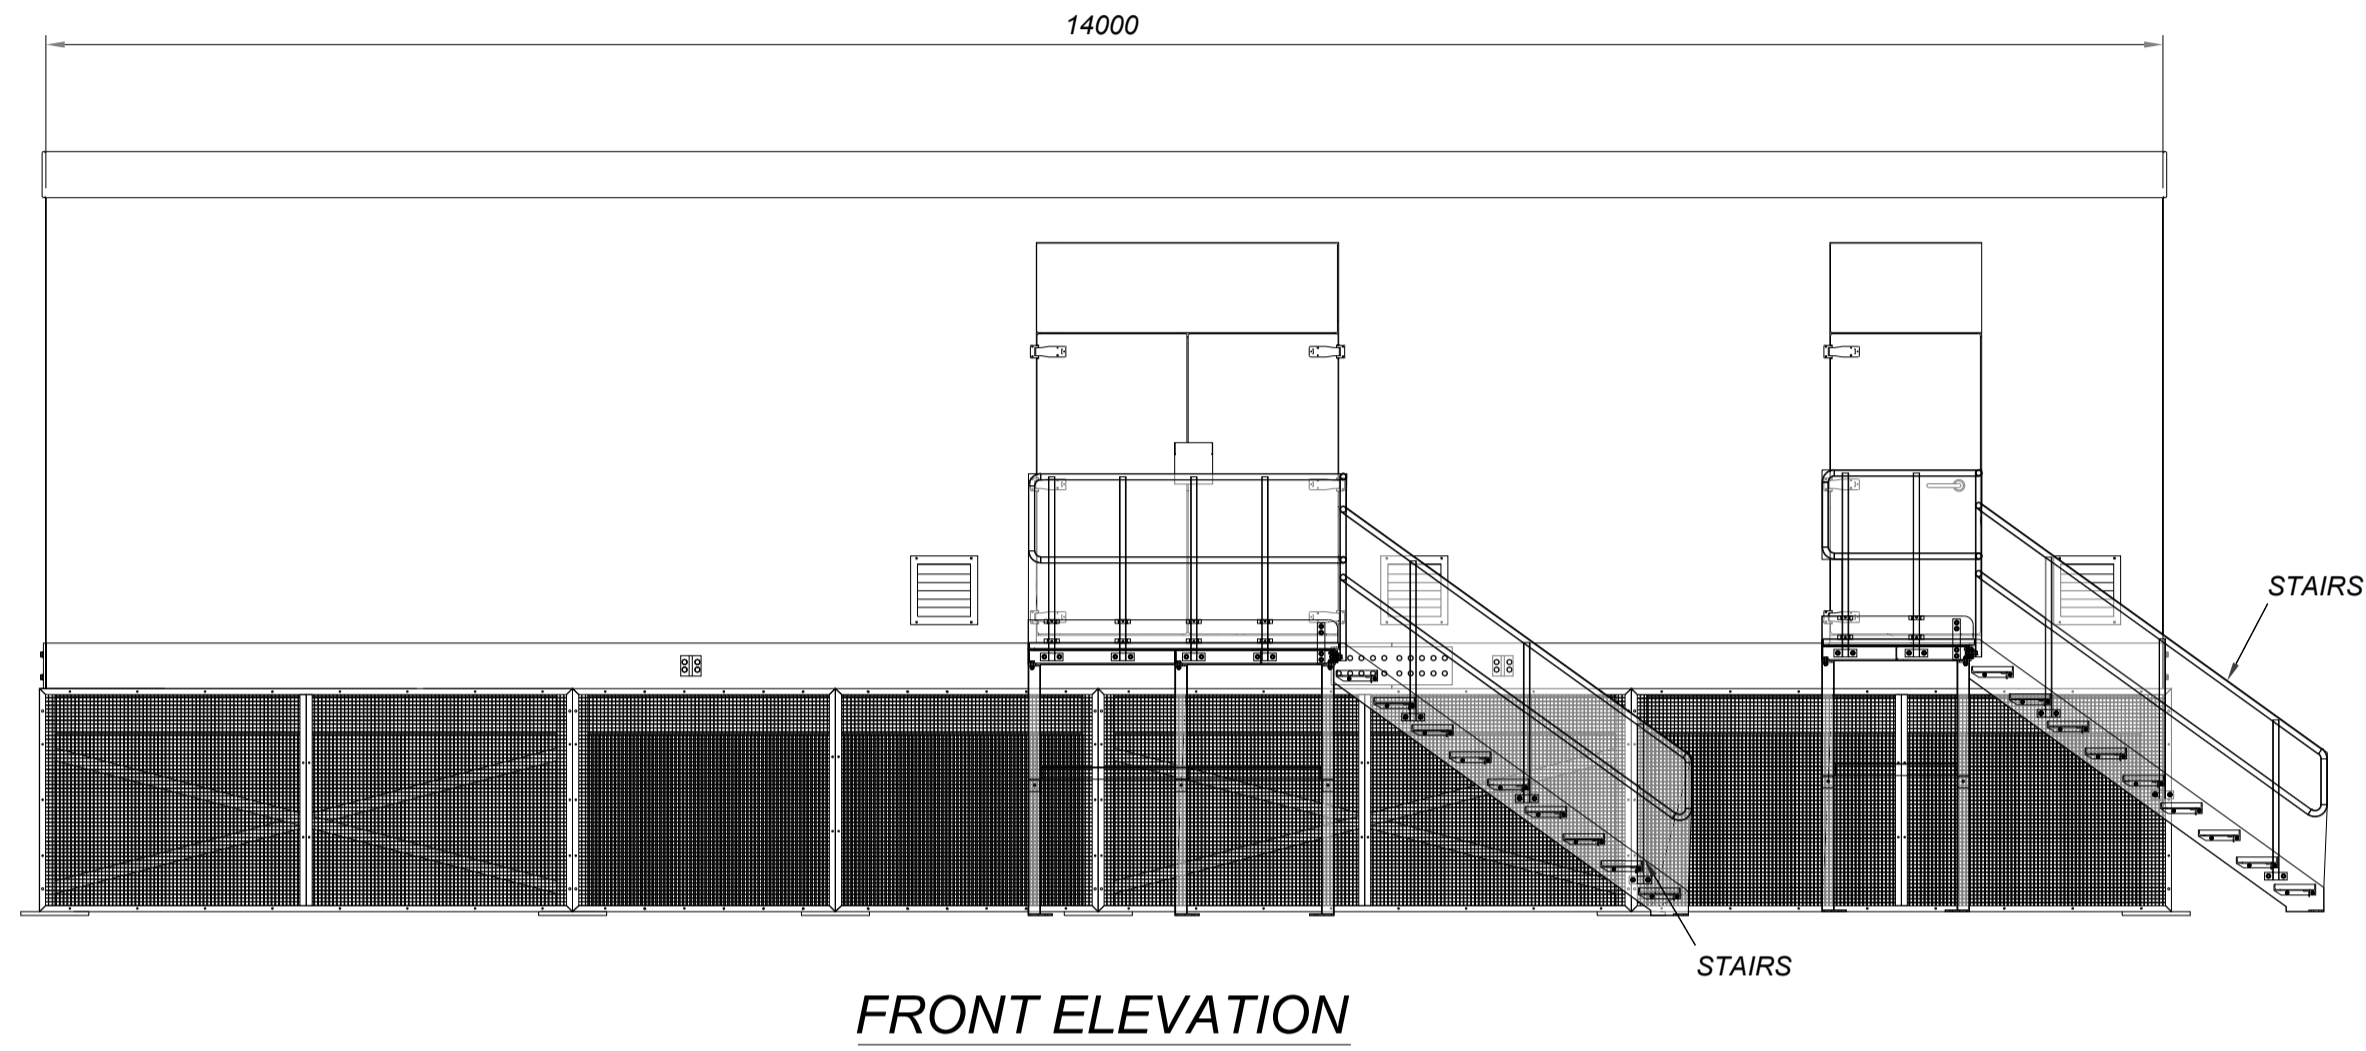


FRONT ELEVATION

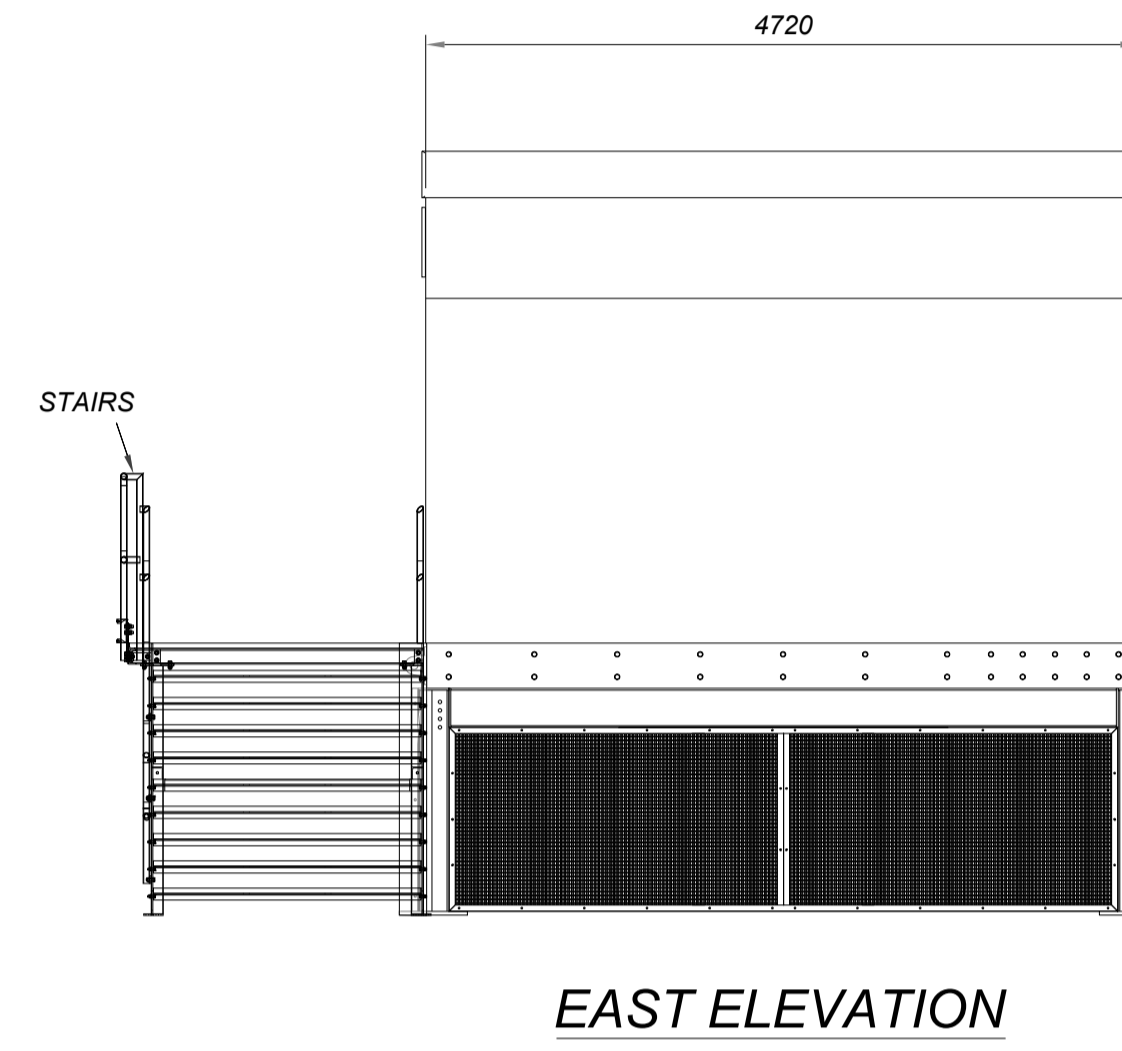

EAST ELEVATION

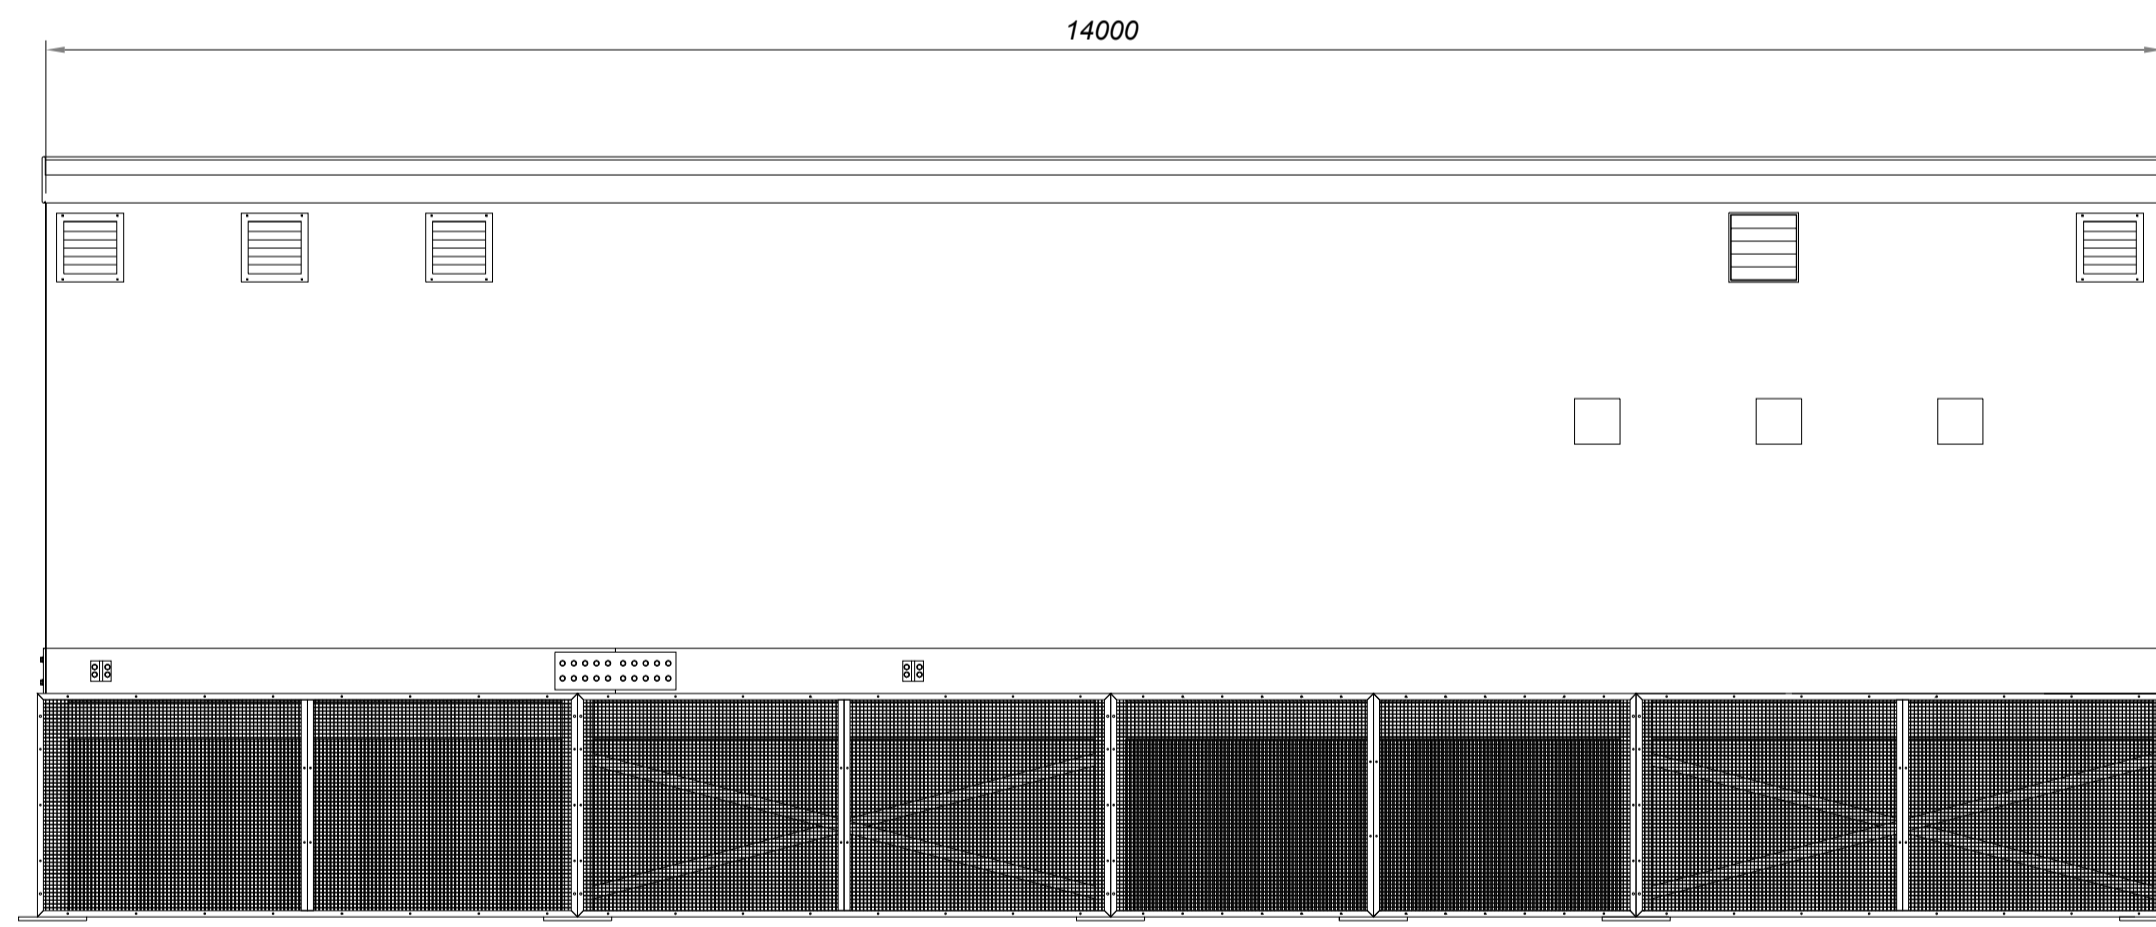

REAR ELEVATION

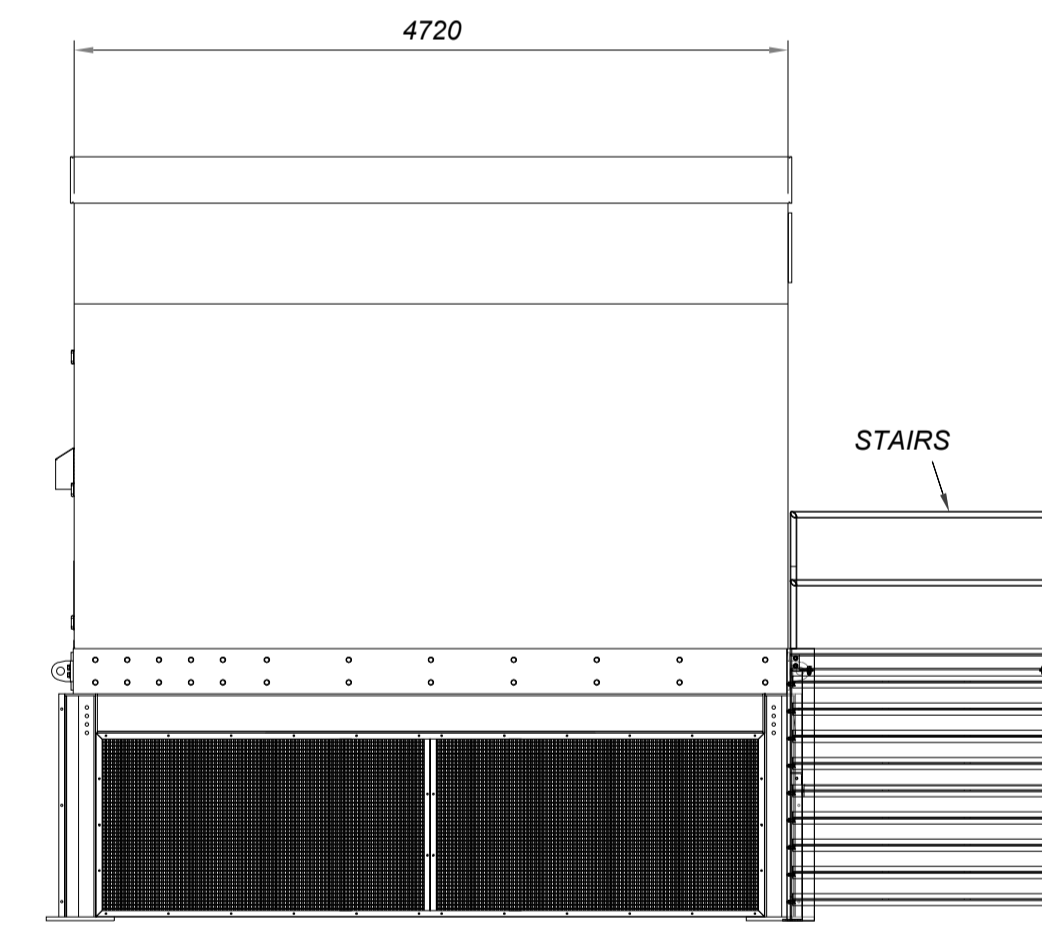

WEST ELEVATION

Rev.	Description	Date	Responsible
R01	First Issue	2025-06-13	AL

This document and its contents are confidential and it is intended solely for the use of the recipient(s) to whom it is addressed. All content, including drawings, designs, and other materials, are the intellectual property of Elements Green Trent Ltd (company number 13065201) is strictly prohibited. Registered Office: 1 Half Moon Street, London, England, W1J 7AY




Drawing Title



Figure 5.18
Illustrative 132kV and 400kV Relay and Control Room

Illustrative Purposes Only



Drawing No. **UK003-PV-ENG-0-460-R00-5.18**

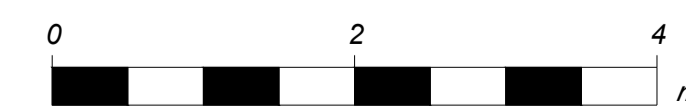

Building Type A

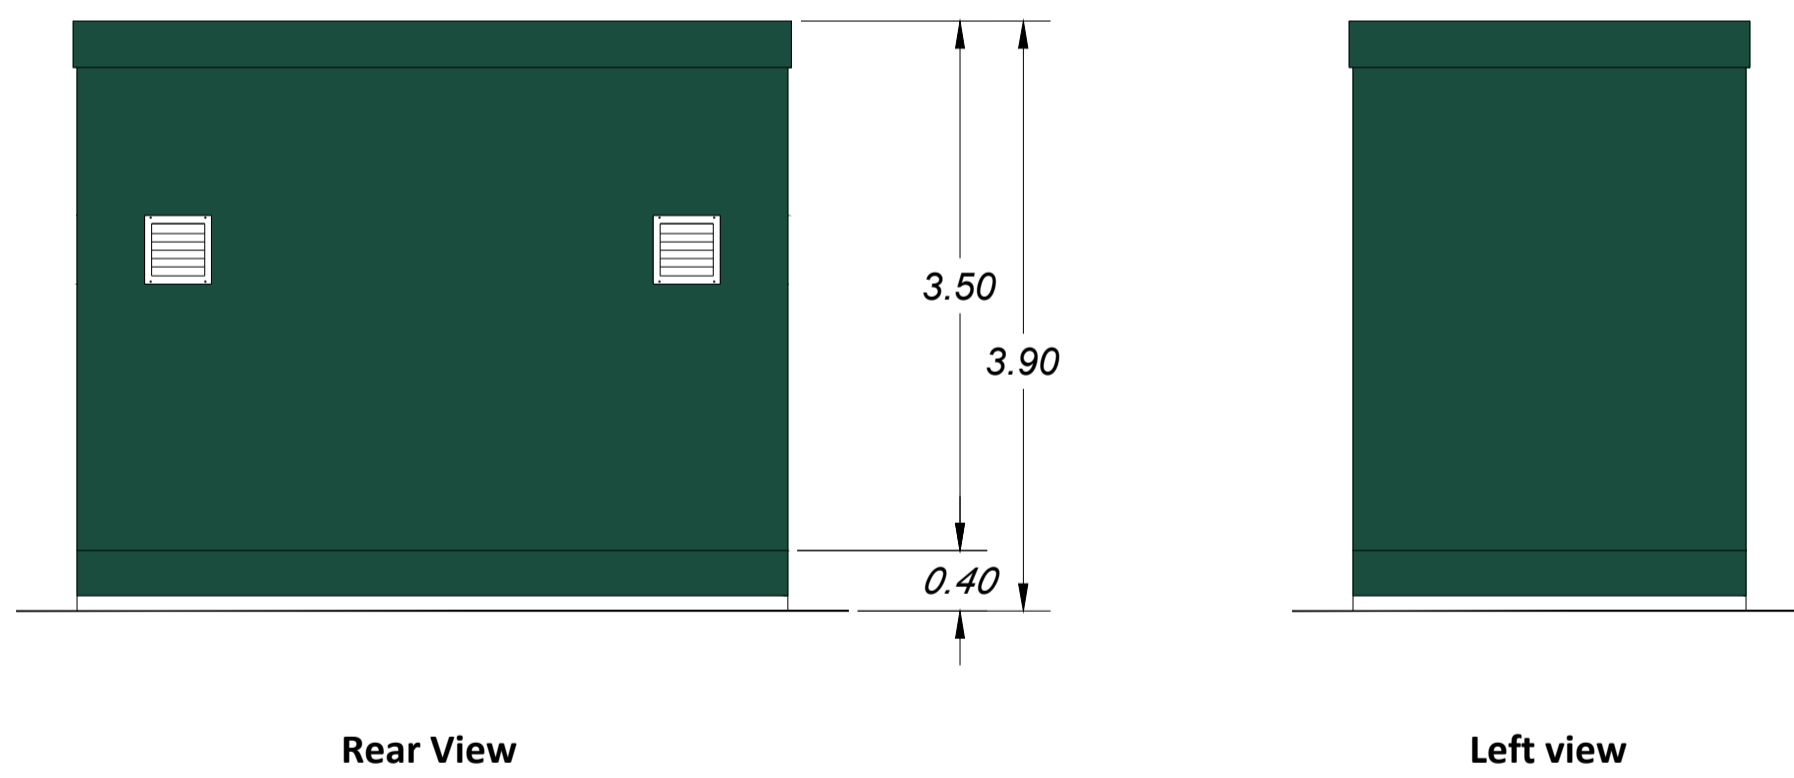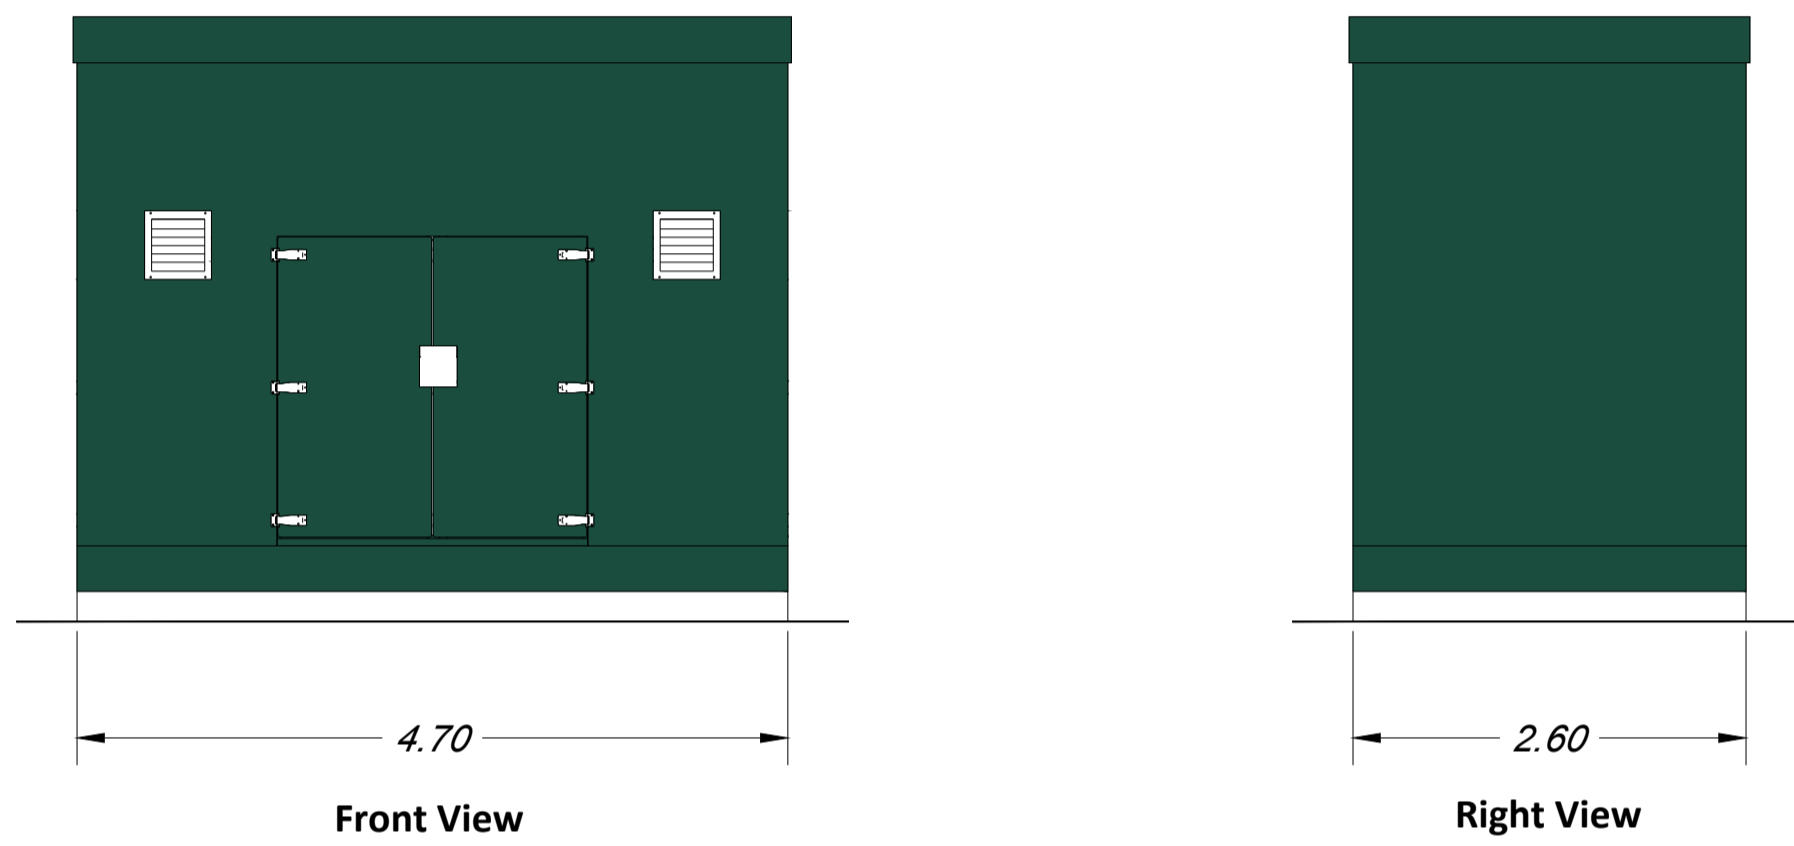

Building Type B

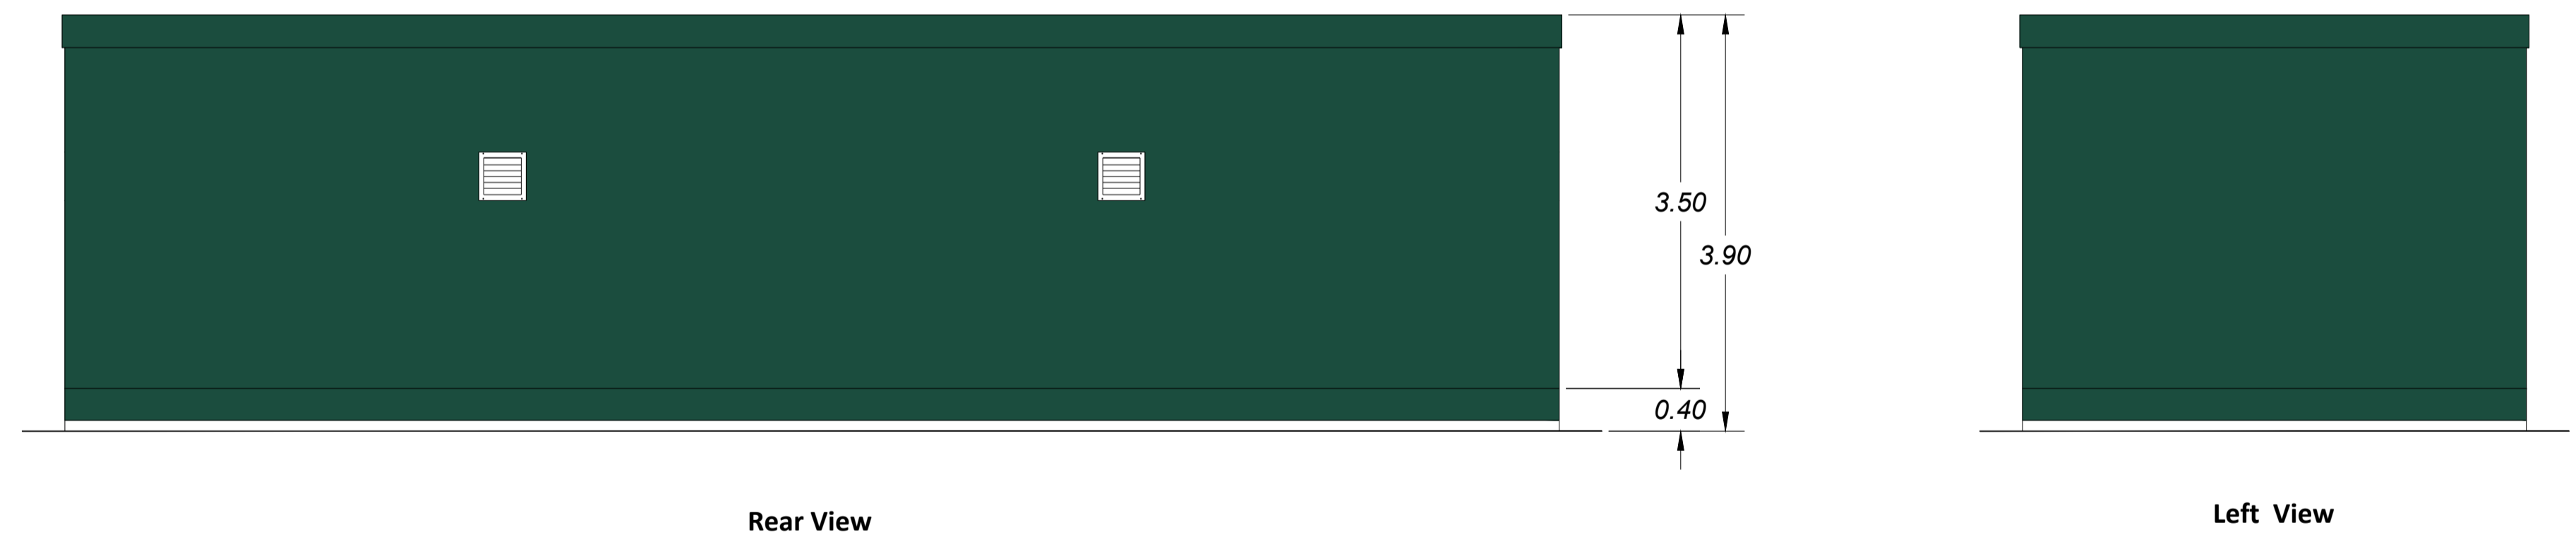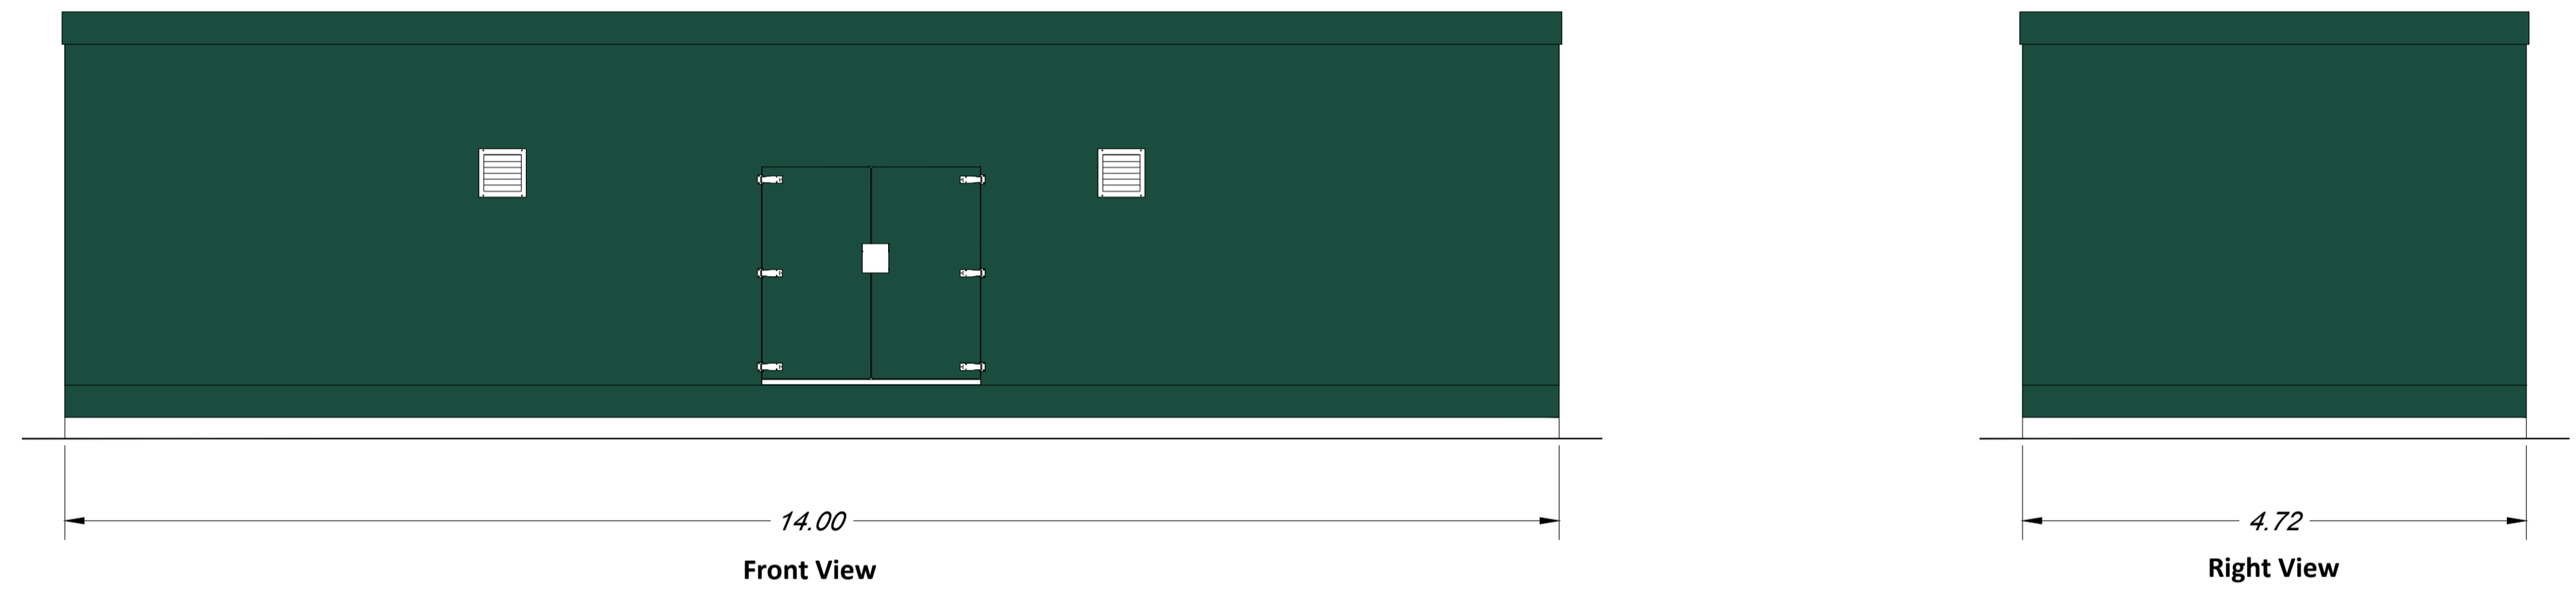

KEY:
 SURFACE PAINT
 COLOR: BRUNSWICK GREEN
 RGB Code: 27, 77, 62

Rev.	Description	Date	Responsible
R01	First Issue	2026-01-08	BA


This document and its contents are confidential and it is intended solely for the use of the recipient(s) to whom it is addressed. All content, including drawings, designs, and other materials, are the intellectual property of Elements Green Trent Ltd. Any unauthorised use or distribution of this document without the prior written consent of Elements Green Trent Ltd (company number 13662071) is strictly prohibited. Registered Office: 1 Half Moon Street, London, England, W1J 7AY







Drawing Title
Figure 5.19
Illustrative Switchgear Buildings and Welfare Cabins

Drawing No. **UK003-PV-ENG-0-460-R00-5.19**

Illustrative Purposes Only

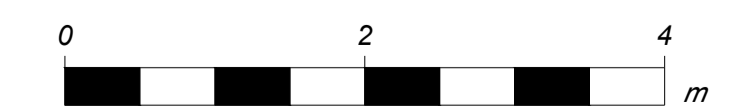

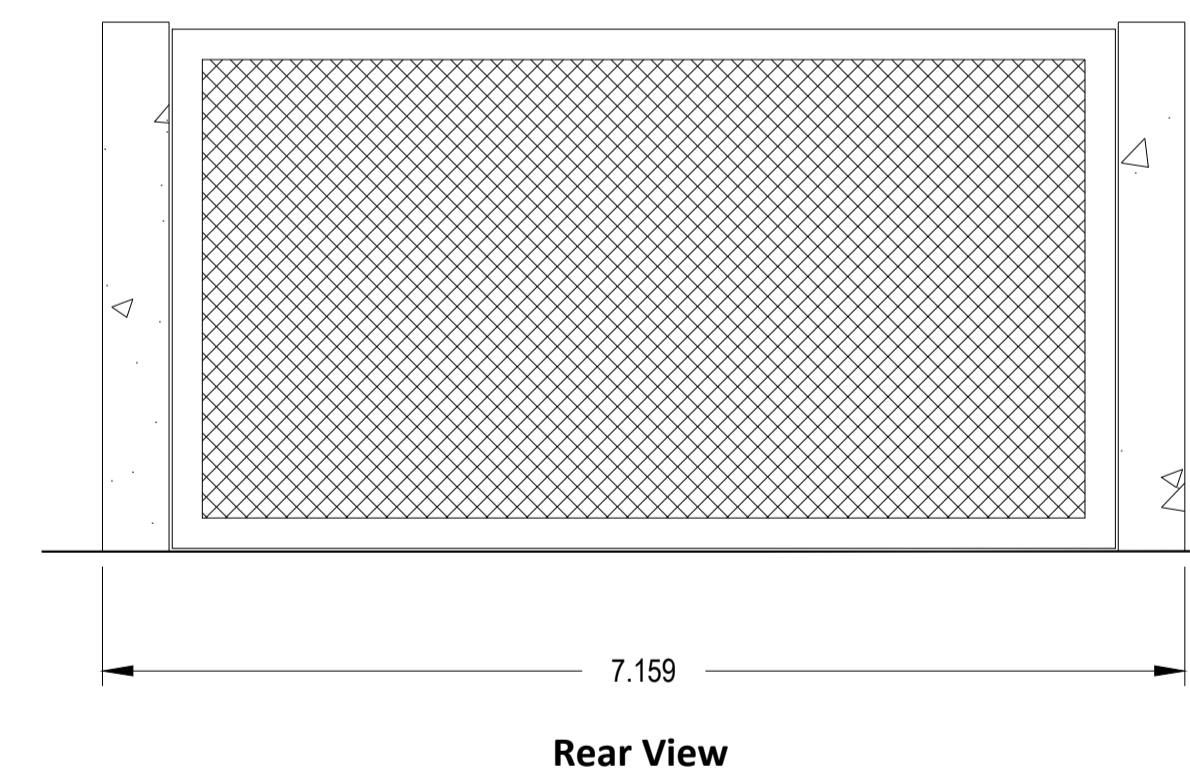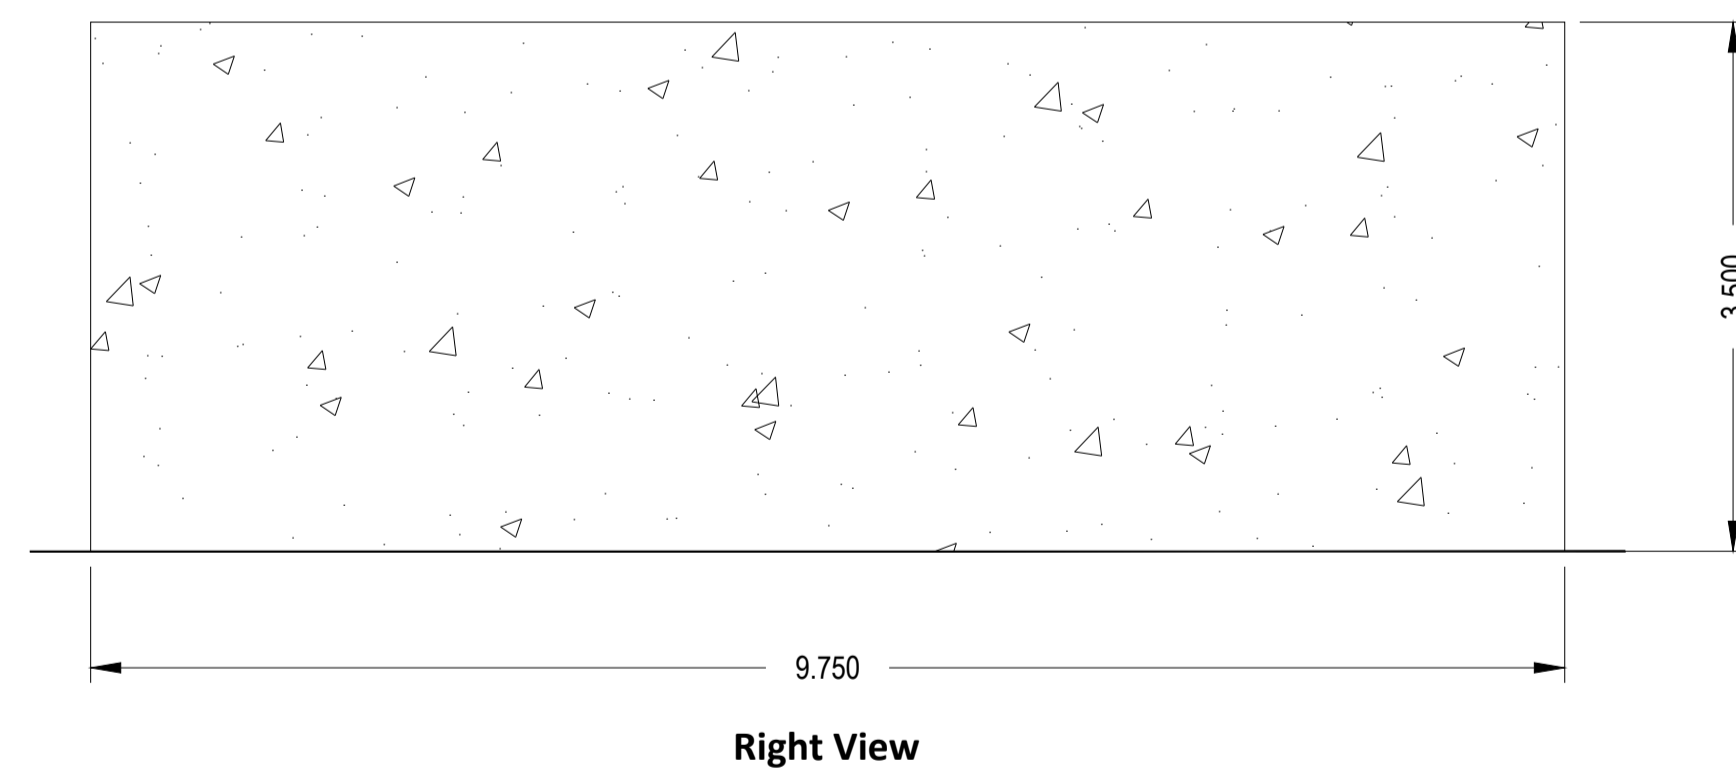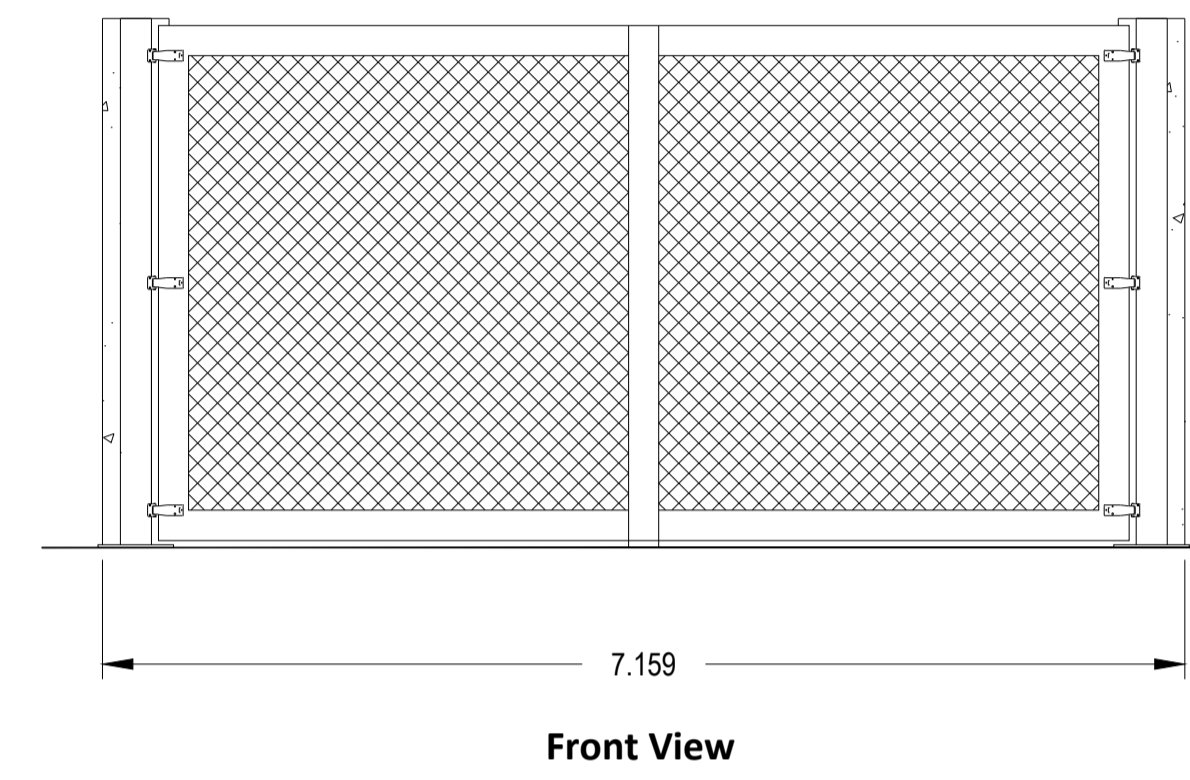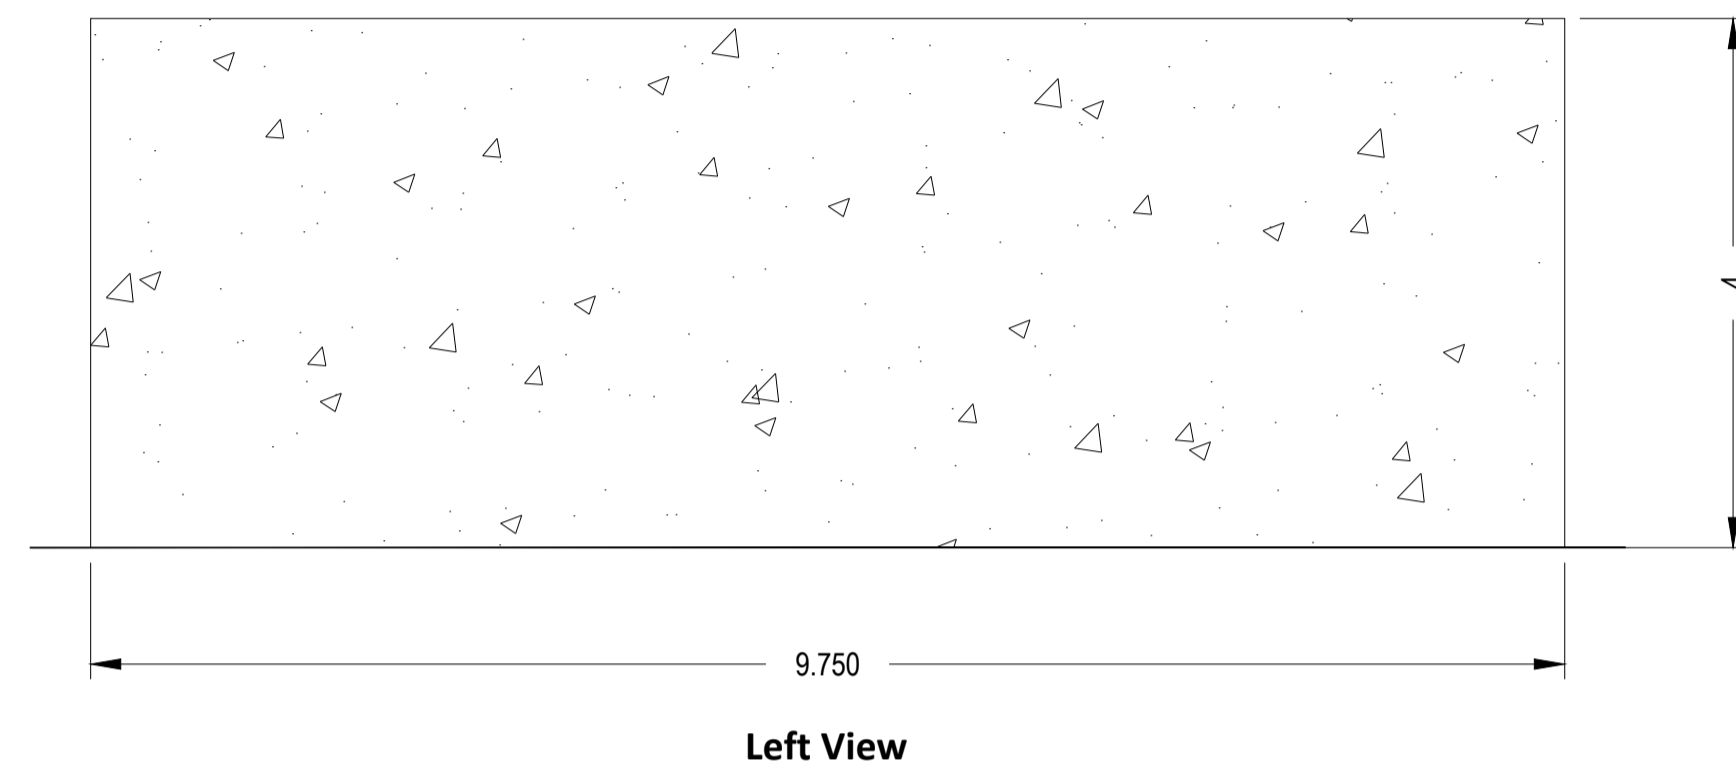

KEY:



CONCRETE FIRE WALL

Rev.	Description	Date	Responsible
R01	First Issue	2026-01-08	BA

This document and its contents are confidential and it is intended solely for the use of the recipient(s) to whom it is addressed. All content, including drawings, designs, and other materials, are the intellectual property of Elements Green Trent Ltd. Any unauthorised use or distribution of this document without the prior written consent of Elements Green Trent Ltd (company number 13665201) is strictly prohibited. Registered Office: 1 Half Moon Street, London, England, W1J 7AY









Solar & Biodiversity Park

Drawing Title


Figure 5.20
Illustrative Auxiliary Transformer House Area

Drawing No. **UK003-PV-ENG-0-460-R00-5.20**

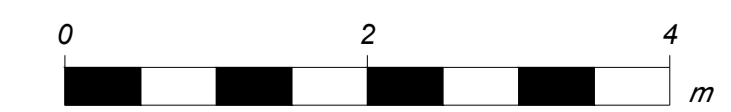

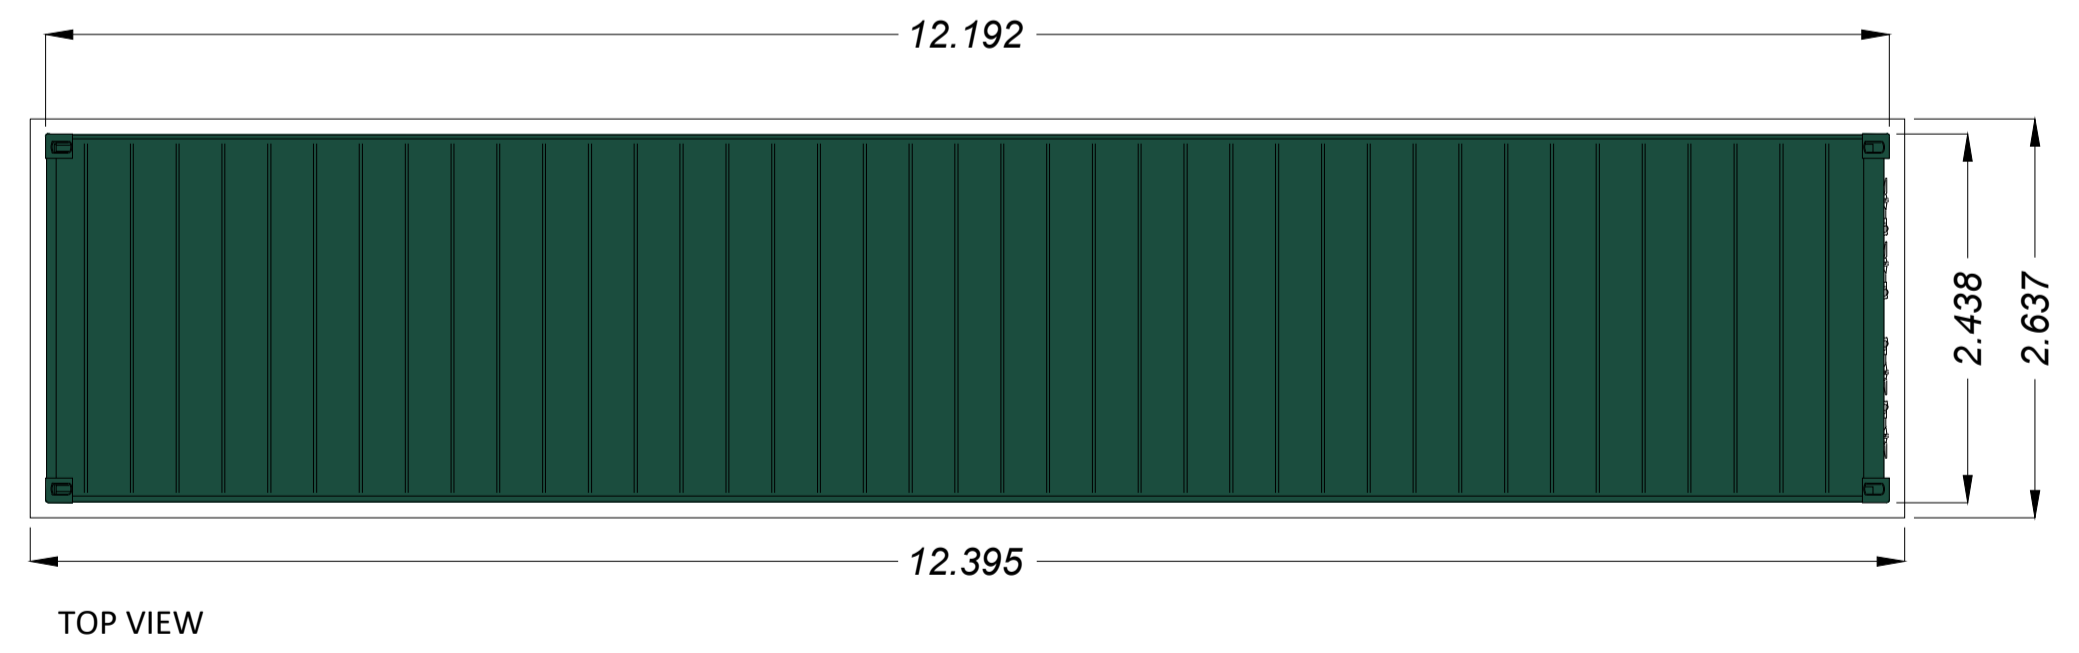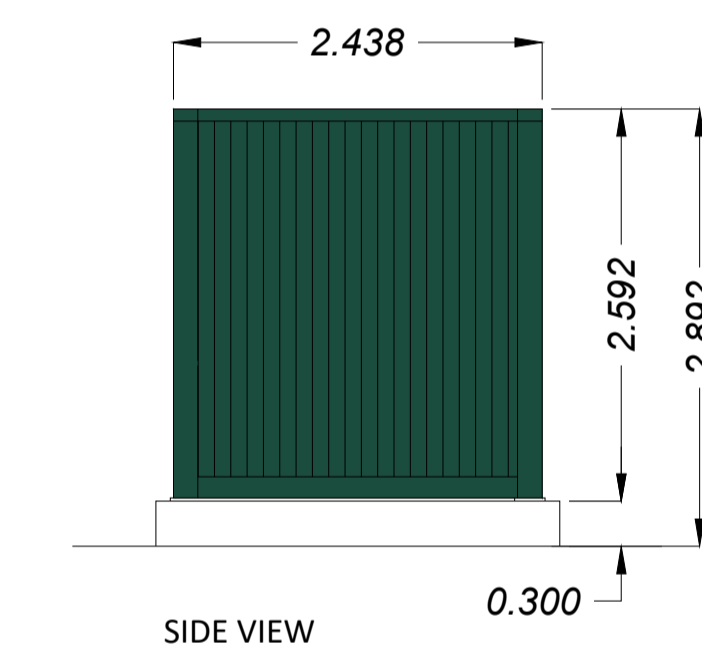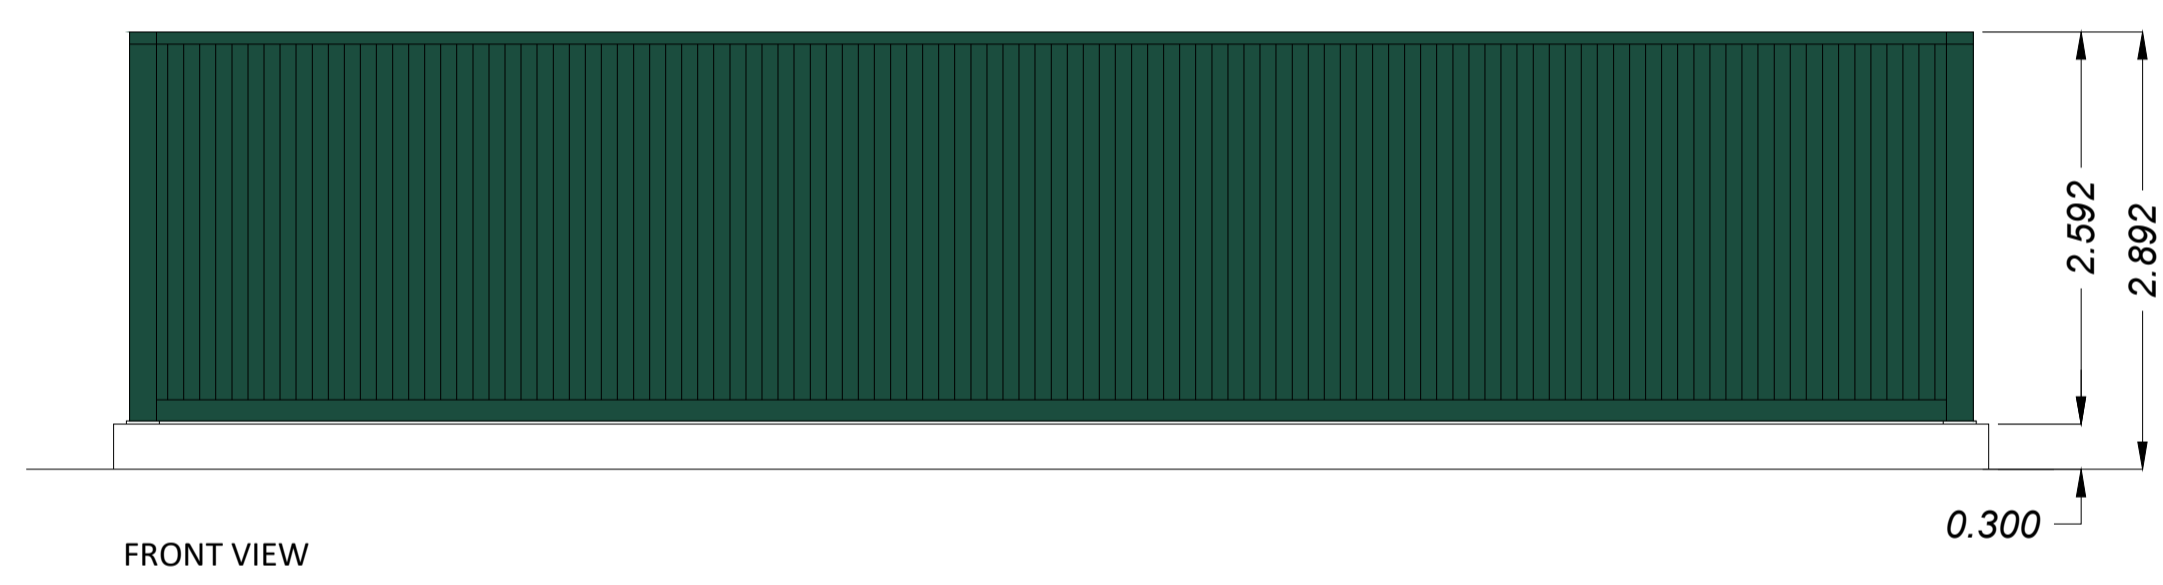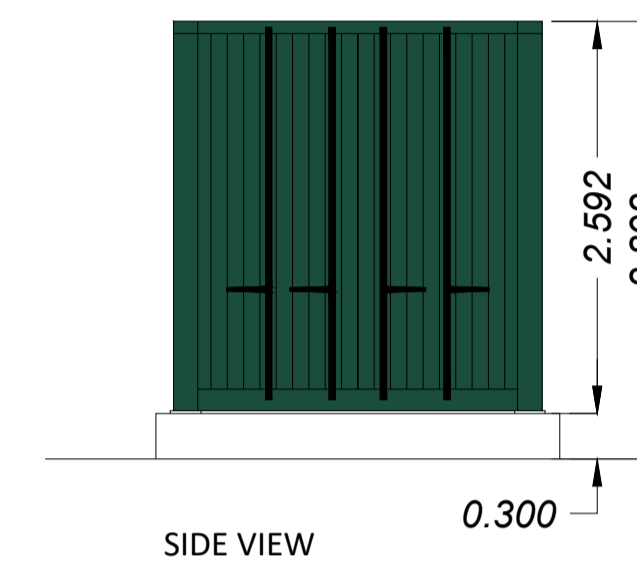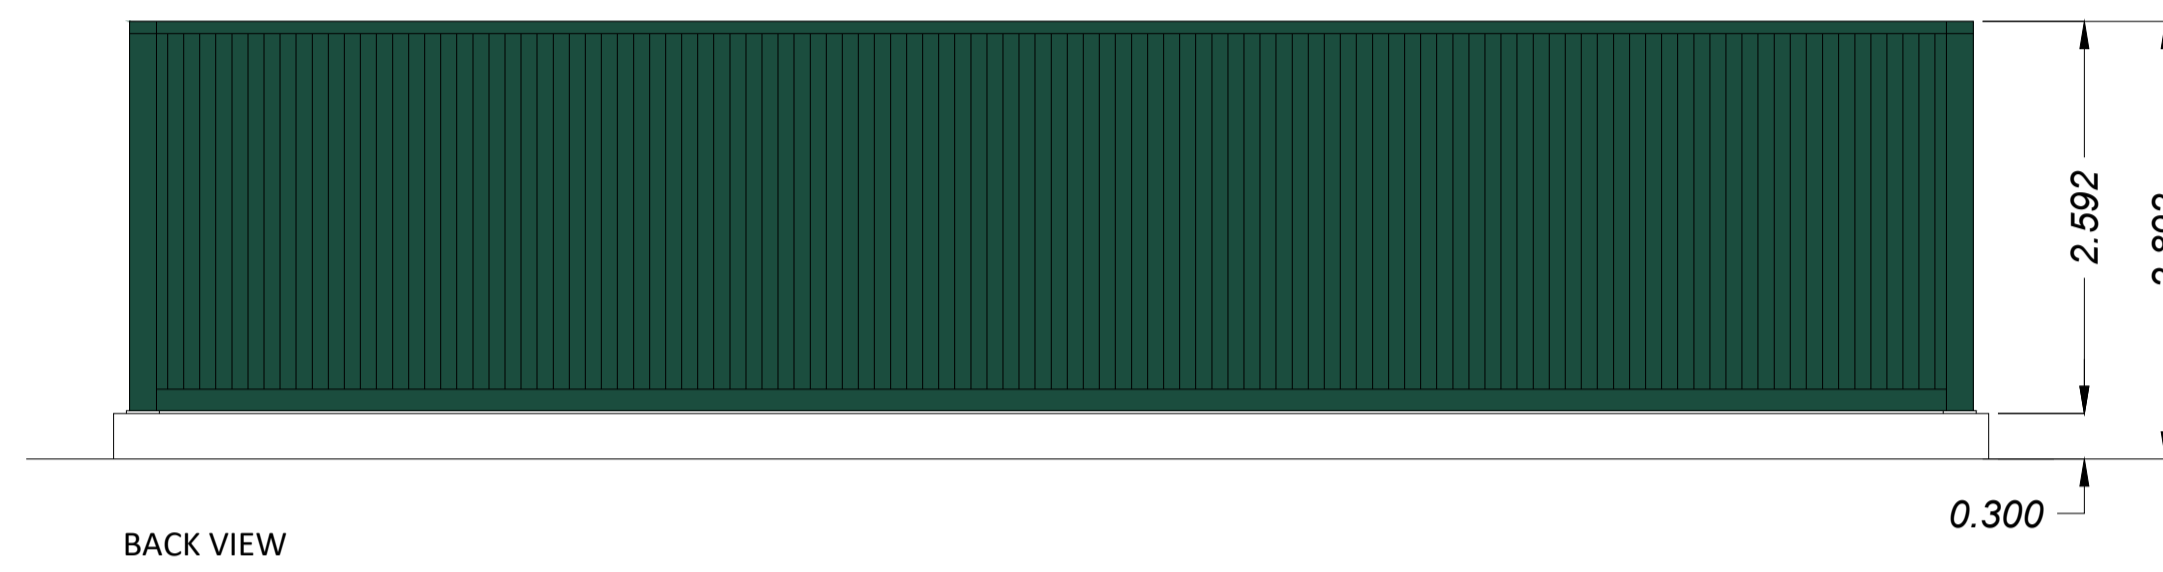

KEY:
 SURFACE PAINT
 COLOR: BRUNSWICK GREEN
 RGB Code: 27, 77, 62

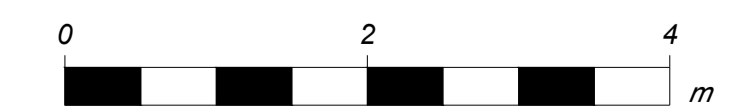

Rev.	Description	Date	Responsible
R01	First Issue	2026-01-08	BA

This document and its contents are confidential and it is intended solely for the use of the recipient(s) to whom it is addressed. All content, including drawings, designs, and other materials, are the intellectual property of Elements Green Trent Ltd. Any unauthorised use or distribution of this document without the prior written consent of Elements Green Trent Ltd (company number 13665201) is strictly prohibited. Registered Office: 1 Half Moon Street, London, England, W1J 7AY



Solar & Biodiversity Park

Drawing Title
**Figure 5.21
Illustrative Spare Parts Containers**

Drawing No.
UK003-PV-ENG-0-460-R00-5.21

Illustrative Purposes Only